ATTACHMENT D

DPS-ROW CONDITIONS OF APPROVAL

January 13, 2022

820220050 PSTA Site

Contact: Sam Farhadi at 240 777-6333

We have reviewed site and landscape plans files that were uploaded on/dated "1/11/2022".

The followings need to be addressed prior to the certification of site plan:

- 1. Access points on public roads:
 - a. Provide the minimum curb radii that will accommodate the site traffic.
 - b. Provide truck turning movement for all (especially right turn) movements.
- 2. Provide public sidewalk:
 - a. to ADA standards (minimum five feet wide) and label it accordingly.
 - b. Need dual ramps at intersections if crossing at both directions are planned.
 - c. Ensure handicap ramps are located as close as possible to the intersection.
 - d. Clarify cycle track traffic management (bike signage) at either end of the site.
- 3. On landscaping plan, provide:
 - a. more species diversity aside from maples, elms or zelkovas.
 - b. Accounting for sufficient soil volume and sight distance between the driveways along Street C West, explore providing minor species street trees in between driveways where the green panel is of enough size.

And the followings need to be conditions of the certified site plan:

- 1. Please address the following Planning Board preliminary plan 120200100 resolution dated July 29, 2021comments:
 - a. 18: Bicycle and Pedestrian.
 - b. 20: elevation difference between bike lanes and sidewalks.
 - c. 27: Traffic signals.
 - d. 28 and 29: Monetary contributions.
 - e. 30: mitigate queuing for EB LT at Darnestown Road and Great Seneca HWY.
- 2. Please address the following MCDOT preliminary plan 120200100 approval letter dated July 8, 2021comments:
 - a. Significant Review comments:
 - i. 6: Existing lot access.
 - ii. 12c: Sight distance requirement where on-street parking is provided.
 - iii. 14: Storm drain study.
 - iv. 15: TIS requirements.
 - v. 16: Providing PUE.
 - b. Standard Comments:
 - i. 2: Protected intersections details.
 - ii. 5: Sidewalks at intersections.
 - iii. 7: on-street parking locations will be determined at ROW permit.

DPS-ROW CONDITIONS OF APPROVAL

- iv. 8: Coordination with MCDOT regarding CCT.
- v. 9: Coordination with MCDOT regarding traffic signals.
- vi. 10: Undergrounding utilities.
- vii. 11: Relocate all private structures/ features out of ROW.
- viii. 16: TDM requirements. Per Preliminary Plan approval, prior to issuance of any building permit, the applicant must submit a Level 3 TDM Plan for New Development. For a TDM Plan template or for any additional information, please contact Beth Dennard at Beth.Dennard@montgomerycountymd.gov, or (240) 777-8384.
- 3. Private streets to be built to the corresponding public road classification standards per County Code 50.4.3.E.4.c.
- 4. Coordinate with MCDOT-Transit on upgrading frontage bus stops to shelters.



DEPARTMENT OF HOUSING AND COMMUNITY AFFAIRS

Marc Elrich
County Executive

Aseem K. Nigam Director

January 31, 2022

Ms. Tamika Graham Montgomery County Planning Department 2425 Reedie Drive Wheaton, Maryland 20902

Re: PSTA

Site Plan No. 820220050

Dear Ms. Graham:

The Montgomery County Department of Housing and Community Affairs (DHCA) has reviewed the above referenced plans and recommends Approval with the updated floor plans for multi-family MPDUs which were received on 1/28/2022.

Sincerely,

Julia Chen

Julia Chen, Planning Specialist Affordable Housing Programs Section

cc: Kate Kubit

Division of Housing

Affordable Housing

Common Ownership Communities

Landlord-Tenant Affairs

Multifamily Housing



Department of Permitting Services Fire Department Access and Water Supply Comments

DATE: 08-Jun-21

TO: Randall Rentfro - rrentfro@rodgers.com

Rodgers Consulting, Inc.

FROM: Marie LaBaw

RE: PSTA Site

120200100 820220050

PLAN APPROVED

1. Review based only upon information contained on the plan submitted **04-Jun-21** .Review and approval does not cover unsatisfactory installation resulting from errors, omissions, or failure to clearly indicate conditions on this plan.

2. Correction of unsatisfactory installation will be required upon inspection and service of notice of violation to a party responsible for the property.

*** Parking restrictions (fire lane orders and traffic orders) to be submitted at site plan ***

*** See statement of performance based design ***

*** 3/10/2022 Site plan 820220050 - see statement of performance based design ***



February 24, 2022

Marie LaBaw PhD, PE

Fire Department Access and Water Supply
Department of Permitting Services, Montgomery County
2425 Reedie Drive, 7th Floor
Wheaton, MD 20902

Project Name: PSTA Site

Preliminary Plan: #120200100

Site Plan: #820220050

Statement of Performance Based Design

Rodgers File #: 0643T1

Dear Marie:

This document serves to outline the non-prescriptive design elements of the Fire Access Plan associated with the former Public Safety Training Academy (P.S.T.A.) Site development project. For your reference, the architecture for each unit type has been included with the Fire Access Plan submission.

Building Height

<u>2-Over-2:</u> The 2-Over-2 condominium product features four (4) levels of living space. All four (4) levels are above finished grade, and appropriate fire department access is provided to eliminate height restriction.

<u>16' Townhome:</u> The 16' townhome features four (4) levels of living space, with an exposed rear terrace and side hinged door on the top floor. In the front you will notice a fourth-floor dormer. This option will not be permitted for lots that are front height restricted. Fire department access is provided in the rear to serve front height restricted units with rear terraces.

<u>20' Townhome:</u> The 20' townhome product features a rear-loaded garage entry, with four (4) levels of living space. All four (4) levels will be exposed the rear. In the front, the highest-level dormer is to be no more than 27' from finished grade. The intent is for this product to satisfy front height restriction requirements. A modified version of this architecture will also be produced to meet full height restriction requirements.

<u>24' Townhome:</u> There are two 24' townhome products: rear-loaded and front-loaded. Both products feature three (3) levels of living space. On the front elevations, you will notice an option for a fourth-floor dormer; this will not be permitted on height restricted units. Additionally, rear-loaded units with a living space below finished grade will provide access via egress window wells.

<u>Apartment Buildings:</u> The multi-family apartment buildings will be four (4) stories with a basement. Only one FDC is required.

Per the 2019 Performance Based Design Guide, multi-family buildings and townhomes with windowsills greater than 27' from grade will require protection by an automatic sprinkler system compliant with NFPA 13 and 13D, respectively. The Fire Access Plan shows one Fire Department Connection (FDC) per building, located in the line of sight from the adjacent fire access route or operation bay. Not all FDC's are located within 50' of the adjacent fire access route or operation bay. However, all FDC's are served by a fire hydrant no more than 100' away. Please note that FDC's are shown on the Preliminary Fire Access Plan for graphical purposes only, and do not mandate implementation on the units shown. Required FDC's will be determined at building permit.



Roadways and Operation Bays

Medical Center Drive and Street C West are both roadways with 12' wide one-way travel lanes. To support fire department vehicular access along these routes, operation bays have been spaced in accordance with MCFRS code. Each operation bay features a dedicated fire hydrant within the limits of the operational area. Per our discussion on 2/12/21, it is desired for these bays to provide a rectangular operation area that is 60' in length (minimum dimensions are 20' x 50'). This has been implemented along Street C West in coordination with on-street parking; operation bays along Street C West measure 20' x 58'. This was also implemented along Medical Center Drive to eliminate all height restrictions on fronting units.

Due to the reduced travel lane width, the minimum effective turning radii at full intersections were calculated using the equation:

$$\mathit{Min.Radius} = 25' + 20' - \frac{(\mathit{Street}\ 1 + \mathit{Street}\ 2)}{2}$$

where the variables *Street 1* and *Street 2* are the travel lane widths of the intersecting roadways. Bends in the vehicular access route throughout the site have a minimum inside radius of 30' and outside radius of 50'. For the bend scenario, the 25' variable is replaced with 30' in the minimum radius equation.

To provide the required 38' effective radii for the intersections of Medical Center Drive and Street C West, custom surface treatments are proposed and detailed on Sheet 2 of the Fire Access Plan. The intent is to utilize two curbs to delineate the protected pedestrian paths from the primary roadway, while providing a mountable area for the fire apparatus to complete the turning movement. The northern intersection (1. Turn In – Street C West) proposes mountable curb to begin at the 38' effective radius and continue around the intersection at a 25' radius with transitions to depressed curb at the crosswalks. Behind this is a 6" curb to follow the 38' radius. This curb transitions down to comply with ADA grading for the crosswalks, and detectable warning surfaces are used to delineate the pedestrian refuge are within the 38' radius.

A similar treatment is proposed for the southern intersection (2. Turn Out – Street C West). Depressed curb follows the 25' radius around the intersection and transitions to mountable curb before converging along Medical Center Drive with the rear 6" curb. Detectable warning surfaces are used to delineate the safe limits of pedestrian paths within the depressed area. For both intersections, ladder bar crosswalk pavement markings shall extend to the limits of the fire access route. All concrete and asphalt within the depressed areas and indicated as fire access route shall meet tertiary road loading standards.

Operation bays outside of a standard roadway are to be constructed in compliance with tertiary road loading standards. This includes the 12' Emergency Vehicle Access to the pool facilities. All mountable curb will be MC-104.01. Final details of aprons, surface hardscape, and method of control are now shown on the fire access plan. Method of control will not be vinyl pillars. All driveway entrances shown as fire access route are to be constructed in compliance with the MCFRS modified residential driveway detail on the Fire Access Plan, unless shown otherwise.

Multi-Family Hydrant Spacing

The Fire Access plan identifies the Multi-family fire access loop through the internal parking lot. Per your e-mail on 2/26/2021, fire hydrant spacing is to be no farther than 500 feet apart measured as the truck travels along any FD access route. The northern portion of this loop that runs parallel to Key



West has hydrants on either end that are spaced 530' apart. However, because there is no building frontage along this stretch, Rodgers requests the spacing and alignment be accepted. Additionally, it has been agreed upon that the northernmost operation bay, adjacent to Multi-family Building One (1) on Medical Center Drive as it approaches Key West Avenue, does not require a fire hydrant.

Should you have any questions or require additional information, please feel free reach out.



Sincerely,

Rodgers Consulting, Inc.

Randall Rentfro, PE

Senior Team Engineer/Senior Associate

"I hereby certify that these documents were prepared or approved by me, and that I am a duly licensed professional engineer under the laws of the State of Maryland, License No. 42356, Expiration Date: 12/19/22."

CC: Elm Street Development, Inc.
Doug Flanagan
Kate Kubit

Rodgers Consulting, Inc.

N:\MD-Montgomery\WMAL Bethesda\documents\Technical\Fire Order\2018-03-29 Performance Based Design(Rev).docx

FIRE CODE ENFORCEMENT

Fire Department Access Review

Review based only upon information contained on this plan. Does not cover unsatisfactory layout resulting from ommisions, errors or failure to clearly indicate conditions on this plan. Correction of such unsatisfactory layout to afford required access will be required if found upon inspection after installation

BY: 5 MC FM: 43 DATE: 3/10/2022



February 24, 2022

Marie LaBaw PhD, PE

Fire Department Access and Water Supply Department of Permitting Services, Montgomery County 2425 Reedie Drive, 7th Floor Wheaton, MD 20902

Project Name: PSTA Site

Preliminary Plan: #120200100

Site Plan: #820220050

Traffic Order

Rodgers File #: 0643T

Introduction:

The intent of this document is to outline the areas designated "No Parking Any Time" per Montgomery County Executive Regulation 29-08 for the Former P.S.T.A. site development project. In addition to the regulation, proximity to proposed fire hydrants was accounted for when delineating these parking restricted areas.

All roads to be constructed will be described and for reference purposes, the terminology of North, East, South, and West will be used. Private streets will not be covered in this document as signage in for these areas is proposed by the fire lane order.

Medical Center Drive:

Medical Center Drive is a primary road that begins with a connection to existing Key West Ave (MD Route 28) and continues to the southeast for 2,679 linear feet (LF) with one travel lane in each direction. The roadway begins as two 12' travel lanes separated by a median with turning lanes on the outside. The road then tapers to a continuous 12' paving width with intermittent 8.5' parking bump-outs on the outer sides. The roadway ends with a connection to Great Seneca Highway with turning lanes. There are numerous intersecting cross streets that will be referenced for location purposes. Areas designated as "No Parking Any Time" are as follows:

- 1. The north side of Medical Center Drive beginning at Key West Ave. and terminating 218 LF past the intersection.
- The north side of Medical Center Drive from 155 LF to 105 LF before the intersection of Blackwell Road.
- 3. The north side of Medical Center Drive beginning 50 LF before Blackwell Road and terminating 50 LF past the intersection.
- 4. The north side of Medical Center Drive from 215 LF to 287 LF after the intersection of Blackwell Road.
- 5. The north side of Medical Center Drive from 126 LF to 43 LF before the intersection of Street C.
- 6. The north side of Medical Center Drive from 54 LF to 116 LF after the intersection of Street C.
- 7. The north side of Medical Center Drive from 218 LF to 168 LF before the intersection of Street A.
- 8. The north side of Medical Center Drive beginning at Street A and terminating 160 LF past the intersection.
- 9. The north side of Medical Center Drive from 300 LF to 175 LF before the intersection of Great Seneca Highway.



- 10. The north side of Medical Center Drive beginning 66 LF before Great Seneca Highway and continuing to the end of the road.
- 11. The south side of Medical Center Drive beginning at Key West Ave. and terminating 212 LF past the intersection.
- 12. The south side of Medical Center Drive beginning 95 LF before Blackwell Road and terminating 175 LF past the intersection.
- 13. The south side of Medical Center Drive from 292 LF to 191 LF before Street C.
- 14. The south side of Medical Center Drive beginning 125 LF before Street C and terminating 116 LF past the intersection.
- 15. The south side of Medical Center Drive from 191 LF to 141 LF before Street A.
- 16. The south side of Medical Center Drive beginning 66 LF before Street A and terminating 55 LF past the intersection.
- 17. The south side of Medical Center Drive beginning 222 LF before Great Seneca Highway and continuing to the end of the road.

Blackwell Road:

Blackwell Road is a secondary road that begins with a connection to Great Seneca Highway and continues to the west for 1000 LF to Medical Center Drive. The road has a 21.0' paving width with one travel lane in each direction and intermittent 8' parking bump-outs on the outer sides. Areas designated as "No Parking Any Time" are as follows:

- 1. The north side of Blackwell Road from Great Seneca Highway to 250 LF past the intersection.
- 2. Both sides of Blackwell Road beginning 35 LF before Street B and terminating 35 LF past the intersection.
- 3. The north side of Blackwell Road beginning 35 LF before Street A and terminating 35 LF past the intersection.
- 4. The north side of Blackwell Road beginning 73 LF before Medical Center Drive and continuing to the end of the road.
- 5. The south side of Blackwell Road from Great Seneca Highway to 228 LF past the intersection.
- 6. The south side of Blackwell Road beginning 35 LF before Street A and terminating 125 LF before the intersection of Medical Center Drive.
- 7. The south side of Blackwell Road beginning 68 LF before Medical Center Drive and continuing to the end of the road.

Street A:

Street A is a secondary road that begins with a connection to Blackwell Road and continues to the south for 1000 LF to Medical Center Drive. The road has a 21.0' paving width with one travel lane in each direction and intermittent 8' parking bump-outs on the east side. Areas designated as "No Parking Any Time" are as follows:

- 1. The west side of Street A for the entirety of the road.
- 2. The east side of Street A beginning at Blackwell Road and terminating 35 LF past the intersection.
- 3. The east side of Street A from 142 LF to 167 LF past the intersection of Blackwell Road.
- 4. The east side of Street A from 250 LF to 275 LF past the intersection of Blackwell Road.
- 5. The east side of Street A from 161 LF to 135 LF before the intersection of Street C East.
- 6. The east side of Street A beginning 51 LF before Street C East and terminating 73 LF past the intersection.
- 7. The east side of Street A beginning 158 LF past Street C East and terminating 25 LF past the alley apron.



8. The east side of Street A beginning 153 LF before Medical Center Drive and continuing to the end of the road.

Street B:

Street B is a secondary road that begins with a connection to Blackwell Road and continues to the south for 1000 LF to Street C East. The road has a 21.0' paving width with one travel lane in each direction and intermittent 8' parking bump-outs on the east side. Areas designated as "No Parking Any Time" are as follows:

- 1. The west side of Street B for the entirety of the road.
- 2. The east side of Street B beginning at Blackwell Road and terminating 157 LF past the intersection.
- 3. The east side of Street B from 281 LF to 256 LF before the intersection of Street C East.
- 4. The east side of Street B from 172 LF to 147 LF before the intersection of Street C East.

Street C West:

Street C West is a secondary road that begins and ends with a connection to Medical Center Drive. It is a one-way travel lane going from north to south for 850 LF. The travel lane width is 12.0' and there is an 8' parking bump out on the east side. Areas designated as "No Parking Any Time" are as follows:

- 1. The west side of Street C West for the entirety of the road.
- 2. The east side of Street C West beginning at the north connection to medical center drive and terminating 222 LF past the intersection.
- 3. The east side of Street C West from 282 LF to 340 LF past the northern connection to Medical Center Drive.
- 4. The east side of Street C West from 372 LF to 314 LF before the southern connection to Medical Center Drive.
- 5. The east side of Street C West from 258 LF before the southern connection to Medical Center Drive and continuing to the end of the road.

Street C East:

Street C East is a a secondary road that begins with a connection to Medical Center Drive and continues to the east for 600 LF until Street B. The road has a 22.0' paving width with one travel lane in each direction Areas designated as "No Parking Any Time" are as follows:

1. Both sides of Street C East for the entirety of the road.

Street D:

Street D is a secondary road that begins with a connection to Medical Center Drive and continues to the south for 215 LF. The road has a 21.0' paving width with one travel lane in each direction and an 8' parking bump-out on the west side. Areas designated as "No Parking Any Time" are as follows:

- 1. The east side of Street D for the entirety of the road.
- 2. The west side of Street D beginning at Medical Center Drive and terminating 50 LF past the intersection.
- 3. The west side of Street D beginning at 162 LF past Medical Center Drive and continuing to the end of the road.



MONTGOMERY COUNTY FIRE AND RESCUE SERVICE

Date: 2/24/2022

Fire Lane Establishment Order

Pursuant to Section 22-33, Montgomery County Code, 1971, as amended, you are hereby notified that a Fire Lane has been established as described in this order. You are hereby ordered to post fire lane signs and paint curbs/pavement as identified below. When signs or paint work has been completed, this order will authorize the enforcement of this Fire Lane by appropriate police or fire officials. Compliance with this order must be achieved within 30 days of receipt when any of the following conditions are met:

- One or more structures addressed from the subject road are occupied;
- The road or accessway is available for use and at least one building permit for an address on the subject road has been issued; or
- The road or accessway is necessary fire department access.

LOCATION: Former P.S.T.A. Site - 9710 Great Seneca Highway

Delineate all areas where indicated by signs and/or paint.

☑ SIGNS -- (See attached diagram for location of sign placement)





(Red letters on white background)

Signs must be posted so that it is not possible to park a vehicle without being in sight of a sign. Signs may be no further apart than 100 feet.

□ PAINT -- (See attached diagram when painting is required)

Paint must be traffic yellow with lines of Sufficient width to be readily identifiable/ readable by motor vehicle operators.

Signature of Order Writer/I.D. #

Cc: Fire Code Enforcement Section Attachment: Fire Lane Diagram

FIRE LANE ESTABLISHMENT FORM

BUILDING OR SUBDIVISION NAME: The Elms at PSTA
FIRE LANE LOCATION/ADDRESS: Former P.S.T.A. Site - 9710 Great Seneca Highway
See attached drawing for designated fire lanes:
I have received the drawing and instructions for installing the designated fire lanes on property not owned by state or local government.
NAME AND TITLE OF PROPERTY REPRESENTATIVE NAME: Kallyryn Kubat TITLE: VICE President ESEC!, SIGNATURE: Kuly Celit Menager
SIGNATURE: Weng
PHONE (703) 134-9730 DATE: 2.24-2012
ADDRESS (where processed order will be mailed): 1355 Bevery Rd #240, McLean VA 22101
The designated fire lanes are the minimum necessary for fire/rescue access and are in accordance with Section 22-33 of the Fire Safety Code.
NAME; SIGNATURE:
STA.#: DATE:
Comments:
Fire Lane Installed Per Order
NAME: DATE:

0092N/23

FORMER P.S.T.A SITE FIRE LANE SIGN PACKAGE



SHEET INDEX:

SHEET No. PLAN TYPE FIRE LANE SIGNAGE PLAN MCFR-1 FIRE LANE SIGNAGE PLAN MCFR-2 MCFR-3 FIRE LANE SIGNAGE PLAN MCFR-4 FIRE LANE SIGNAGE PLAN MCFR-5 FIRE LANE SIGNAGE PLAN FIRE LANE SIGNAGE PLAN MCFR-6 - 8

DESCRIPTIONCOVER SHEET-KEY MAP NOTES SAMPLE SIGN TYPICAL SIGNS & PLACEMENT SIGN PLACEMENT & CURB PAINT DIAGRAM PLAN VIEW LAYOUT

- E: HOA alley parcels that are not designated as fire lane access routes and do not meet design criteria for designation as access routes should be noted as such in project's HOA Covenant documents. All signage shall be installed outside of easement dedications.

NOTE:
The Planimetric information shown on this plan is based in part on copyrighted GIS Data from M-NCPPC, and may not be copied or reproduced without express written permission from M-NCPPC.

FORMER P.S.T.A. SITE FIRE LANE SIGNAGE PLAN

ELECTION DISTRICT No. 2 MONTGOMERY COUNTY

RODGERS CONSULTING

19847 Century Boulevard, Suite 200, Germantown, Maryland 20874 Ph: 301.948.4700 Fx: 301.948.6256 www.rodgers.com

PLAN SHEET LEGEND		
•	FIRE HYDRANT	
	ACCESS ROUTE	
	FIRE LANE SIGN	

L			
	BY	DATE	SCALE: 1"=400'
BASE DATA			JOB No.
DESIGNED			0643T
DRAWN			DATE:
REVIEWED			FEB 2022
RELEASE FO	DR .		MCFR-1
BY DATE		_ 	SHEET No. 1 OF 8

SIGNAGE GENERAL NOTES:

Characteristics

Signs shall be all-season durable with red reflective lettering on a white background.

Where Required

Fire lane signs may be required in areas that meet the following criteria:

- Fire department access roadways with clear and unobstructed pavement width
 less than 28 feet wide signs shall be posted on both sides and/or per direction
 from the fire marshal.
- Fire department access roadways with clear and unobstructed pavement width between 28 feet and 36 feet wide signs shall be posted on one side only and/or per direction from the fire marshal.
- Fire department access roadways with clear and unobstructed pavement width exceeding 36 feet wide - fire lane restrictions per direction from the fire marshal.
- Fire department access roadways with limiting factors such as traffic calming devices, heavy volume, access to high risk occupancies, etc - fire lane restrictions per direction from the fire marshal.

Installation

Installation of the NO PARKING signs shall meet all of the following requirements:

- One at the begining of the restriction (one arrow pointing towards the restriction zone).
- One at the end of the restriction (one arrow pointing back into the restricted zone).
- One *at least* every 200 feet within the restricted area (double arrow pointing in each direction, to indicate the continuing restriction).
- Spaced evenly within the restriction (for straight curbs/zones). For example, if the parking restriction zone is 400 feet long, only one *double arrow* sign is required at a distance of 200 feet from the beginning of the restriction. If the restriction zone is 450 feet long, two *double arrow* signs are required; spaced evenly from each other and from the beginning/ending signs.
- Spaced so that at least one readable sign is visible in front of a parked vehicle from any point along the restriction (for curved curbs/zones and areas that may present visual obstacles).
- Set at an angle of no fewer that 30 degrees and no more than 45 degrees with the lane of traffic flow visible to approaching traffic.

Some areas may need additional fire lane signs. Review by the Fire Marshal's office will identify additional requirements.

Other Fire Lane Designations

MCFRS Office of the Fire Marshal *may* require other designations such as curb painting in addition to signs. Per *NFPA 1 Section 18.2.3.5* where required by the Montgomery County Fire and Rescue Service, approved signs or other approved notices shall be maintained to identify fire department access roads.

FORMER P.S.T.A. SITE
FIRE LANE
SIGNAGE PLAN

ELECTION DISTRICT No. 2 MONTGOMERY COUNTY RODGERS CONSULTING
1987 Century Boulevard, Suite 200, Germantown, Maryland 20874
Phi 301 948 4700 Fx: 301.948 6256 www.rodgers.com

	BY	DATE	SCALE:
BASE DATA			JOB No.
DESIGNED			0643T
DRAWN			DATE:
REVIEWED			FEB 2022
RELEASE FO	DR .		MCFR-2
			SHEET No.
BY	DAT	TE	2 OF 8

Per Montgomery County Executive Regulation 29-08AM, Fire Department apparatus access serving one and two family dwellings of three (3) stories or less, and having no window sill greater than twenty-seven (27) feet from grade on the same side of the structure as the access route, may be twenty-six (26) feet wide and allow parking on one side, if there are fifty (50) foot long operating bays at a maximum interval of three hundred (300) feet.

Per Montgomery County Code

No parking within 30 feet of an intersection.


No parking within 5 feet of a driveway.

31-20(b) No parking within 15 feet of fire hydrant

No Parking within 20 feet of painted crosswalk

No parking within 30 feet of traffic control signal/device

SAMPLE SIGN

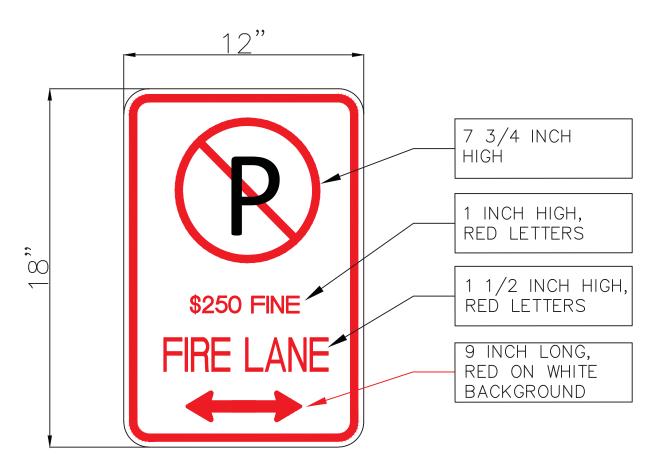

FIRE LANE SIGNS SHALL BE 12 INCHES WIDE AND 18 INCHES HIGH

FORMER P.S.T.A. SITE
FIRE LANE
SIGNAGE PLAN

ELECTION DISTRICT No. 2 MONTGOMERY COUNTY RODGERS CONSULTING
19847 Century Boulevard, Suite 200, Germantown, Maryland 20874
Ph: 301.948.4700 Fz: 301.948.6256 www.rodgers.com

TYPICAL SIGNS & PLACEMENT





200 FT.



\$250 FINE FIRE LANE

\$250 FINE FIRE LANE


EITHER TYPE OF SIGN MAY BE USED PROVIDED THE SAME TYPE IS USED CONSISTENTLY

FORMER P.S.T.A. SITE
FIRE LANE
SIGNAGE PLAN

ELECTION DISTRICT No. 2 MONTGOMERY COUNTY RODGERS

19847 Century Boulevard, Suite 200, Germantown, Maryland 20874 Ph: 301.948.4700 Fx: 301.948.6256 www.rodgers.com

SIGN PLACEMENT DETAIL

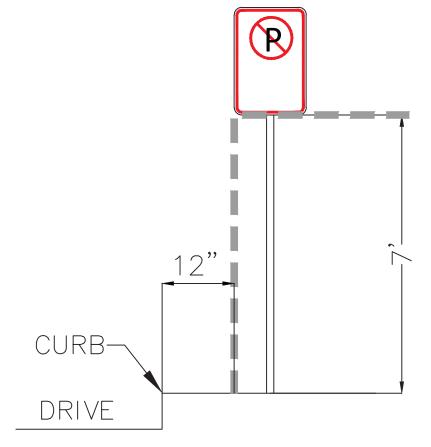


FORMER P.S.T.A. SITE
FIRE LANE
SIGNAGE PLAN

ELECTION DISTRICT No. 2 MONTGOMERY COUNTY RODGERS


| 19847 Century Boulevard, Suite 200, Germantown, Maryland 20874 Ph: 301.948.4700 Fx: 301.948.6256 www.rodgers.com


	_			00115
		BY	DATE	SCALE:
BASE D	ATA			JOB No.
DESIGNI	ΞD			0643T
DRAWN				DATE:
REVIEW	G			FEB 2022
RELEASE FOR		MCFR-5		
I				SHEET No.
BY DATE		5 OF 8		

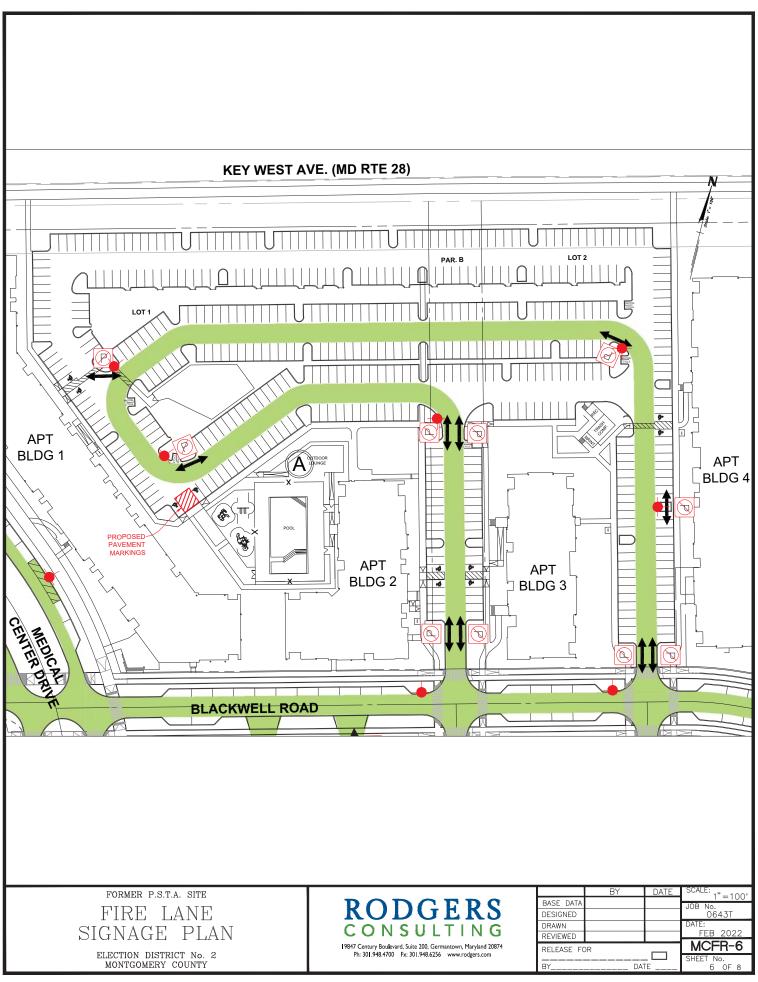





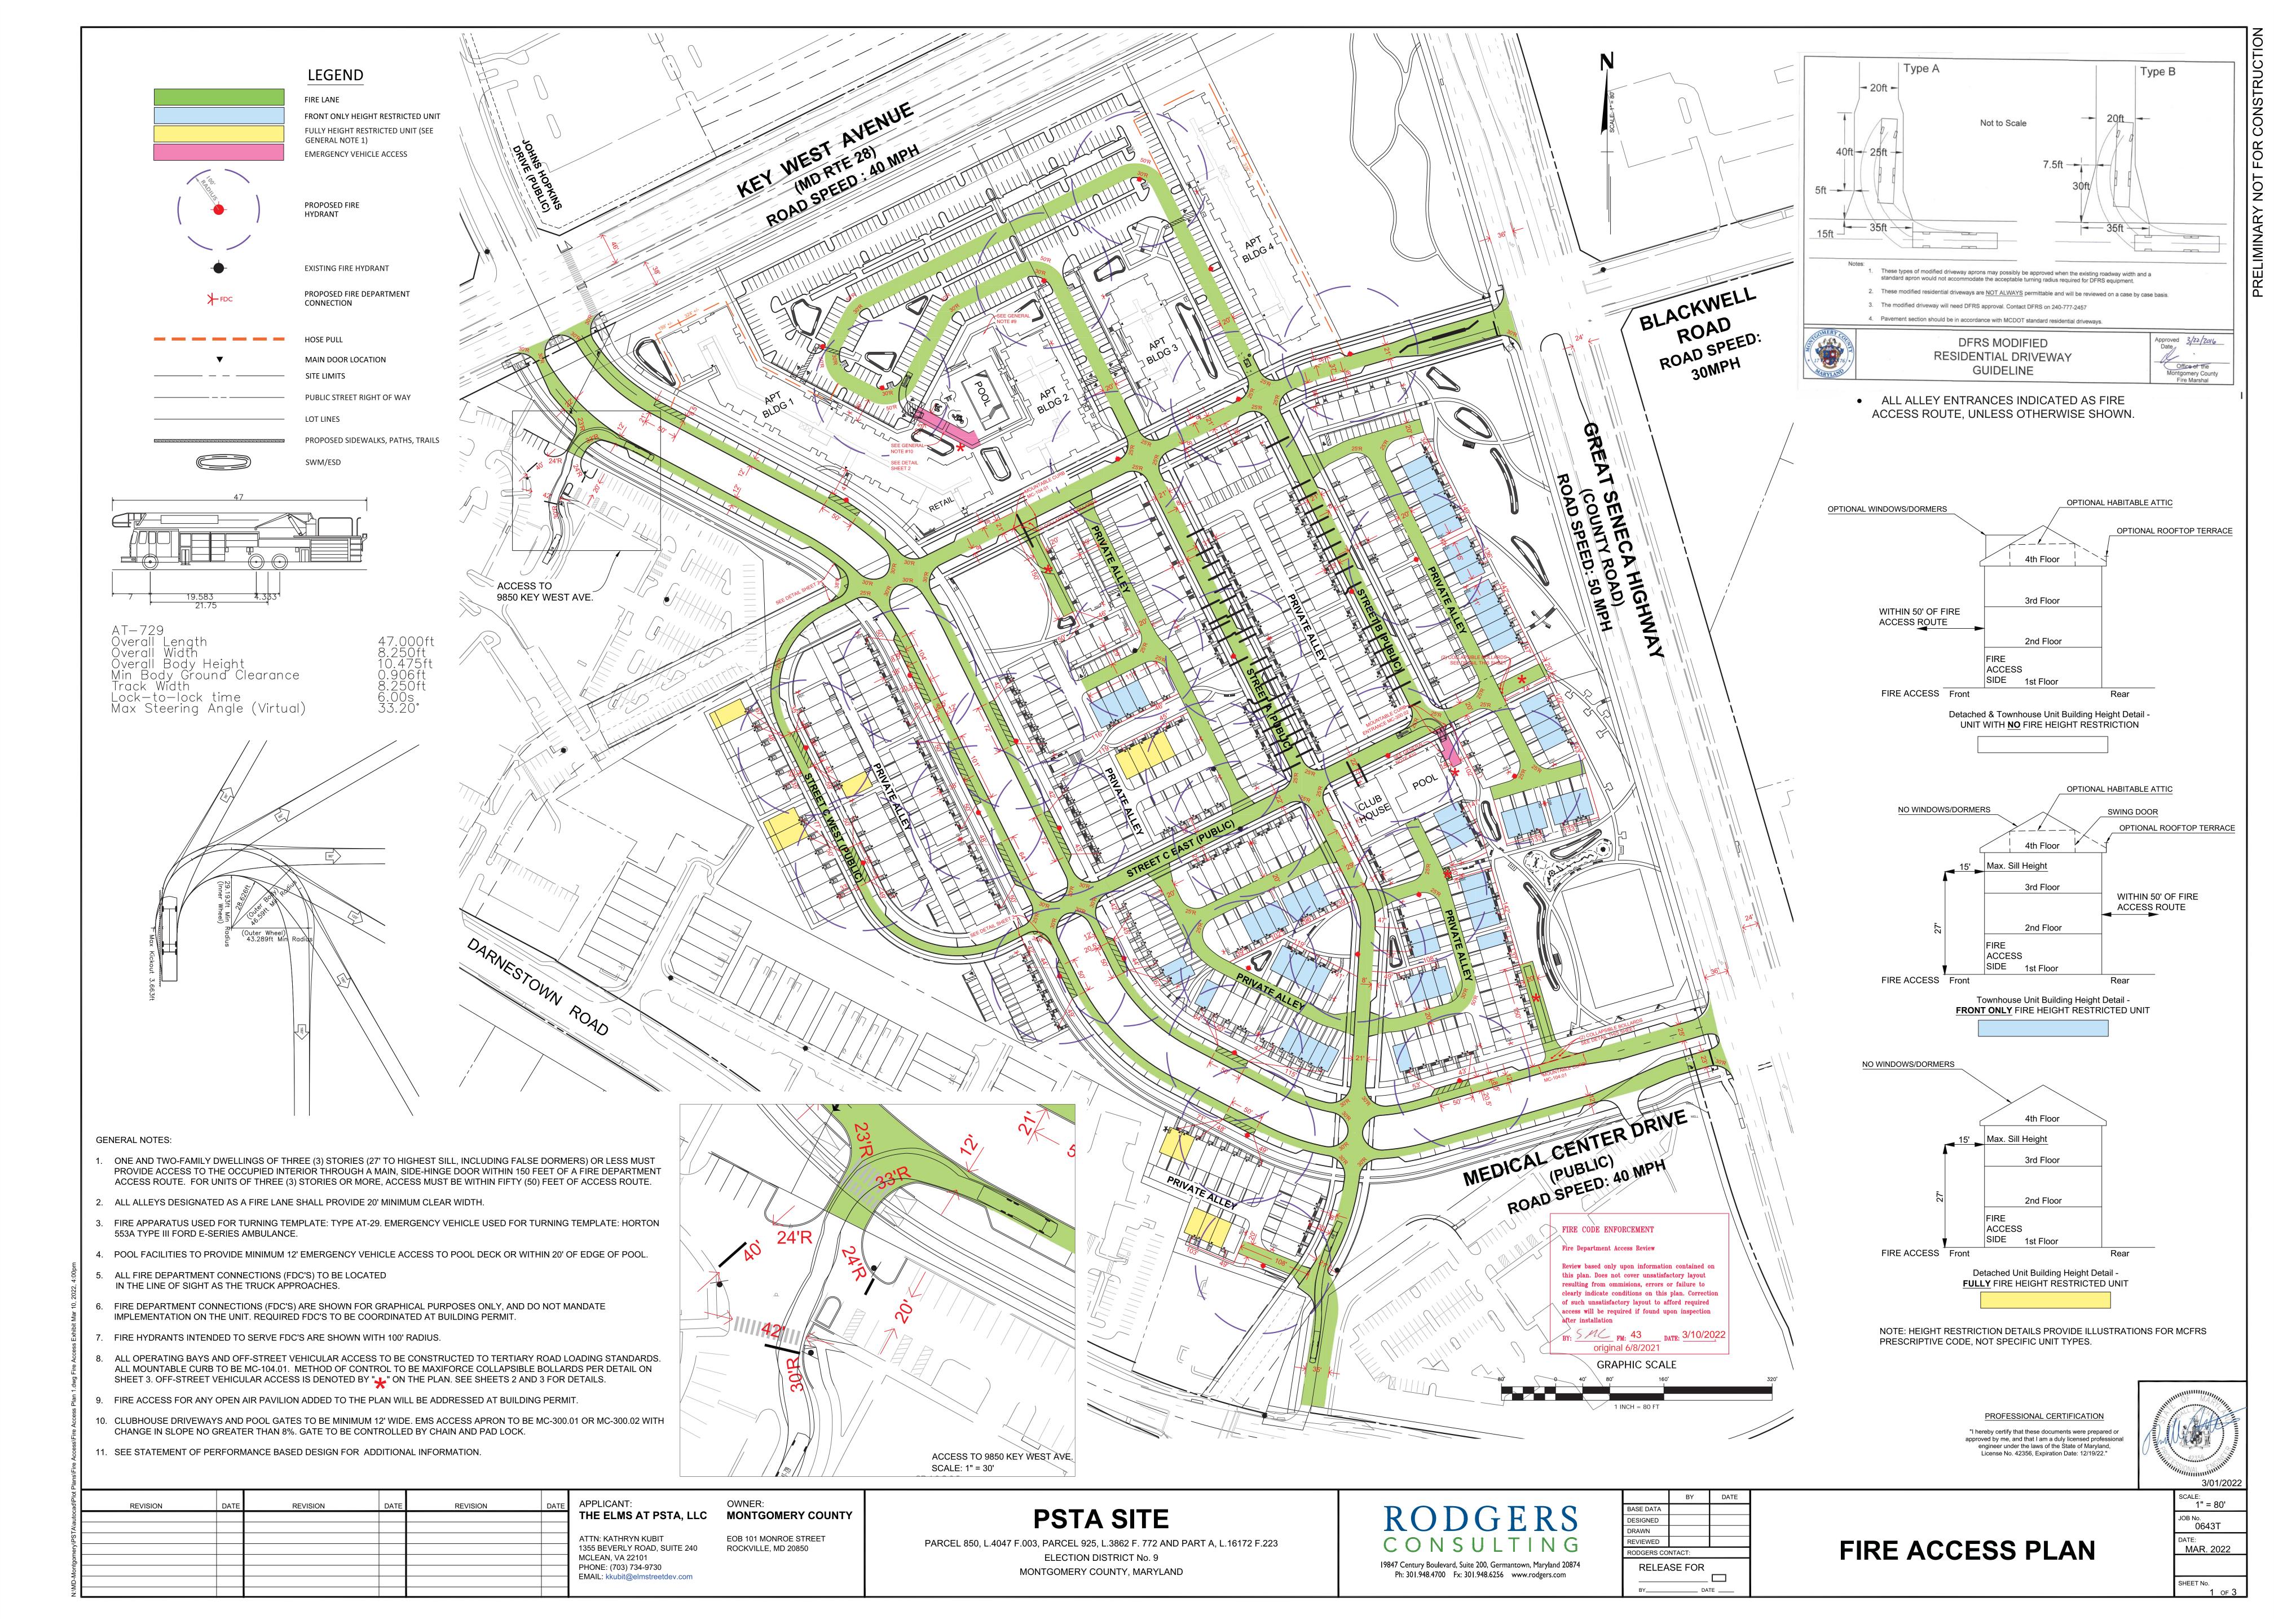

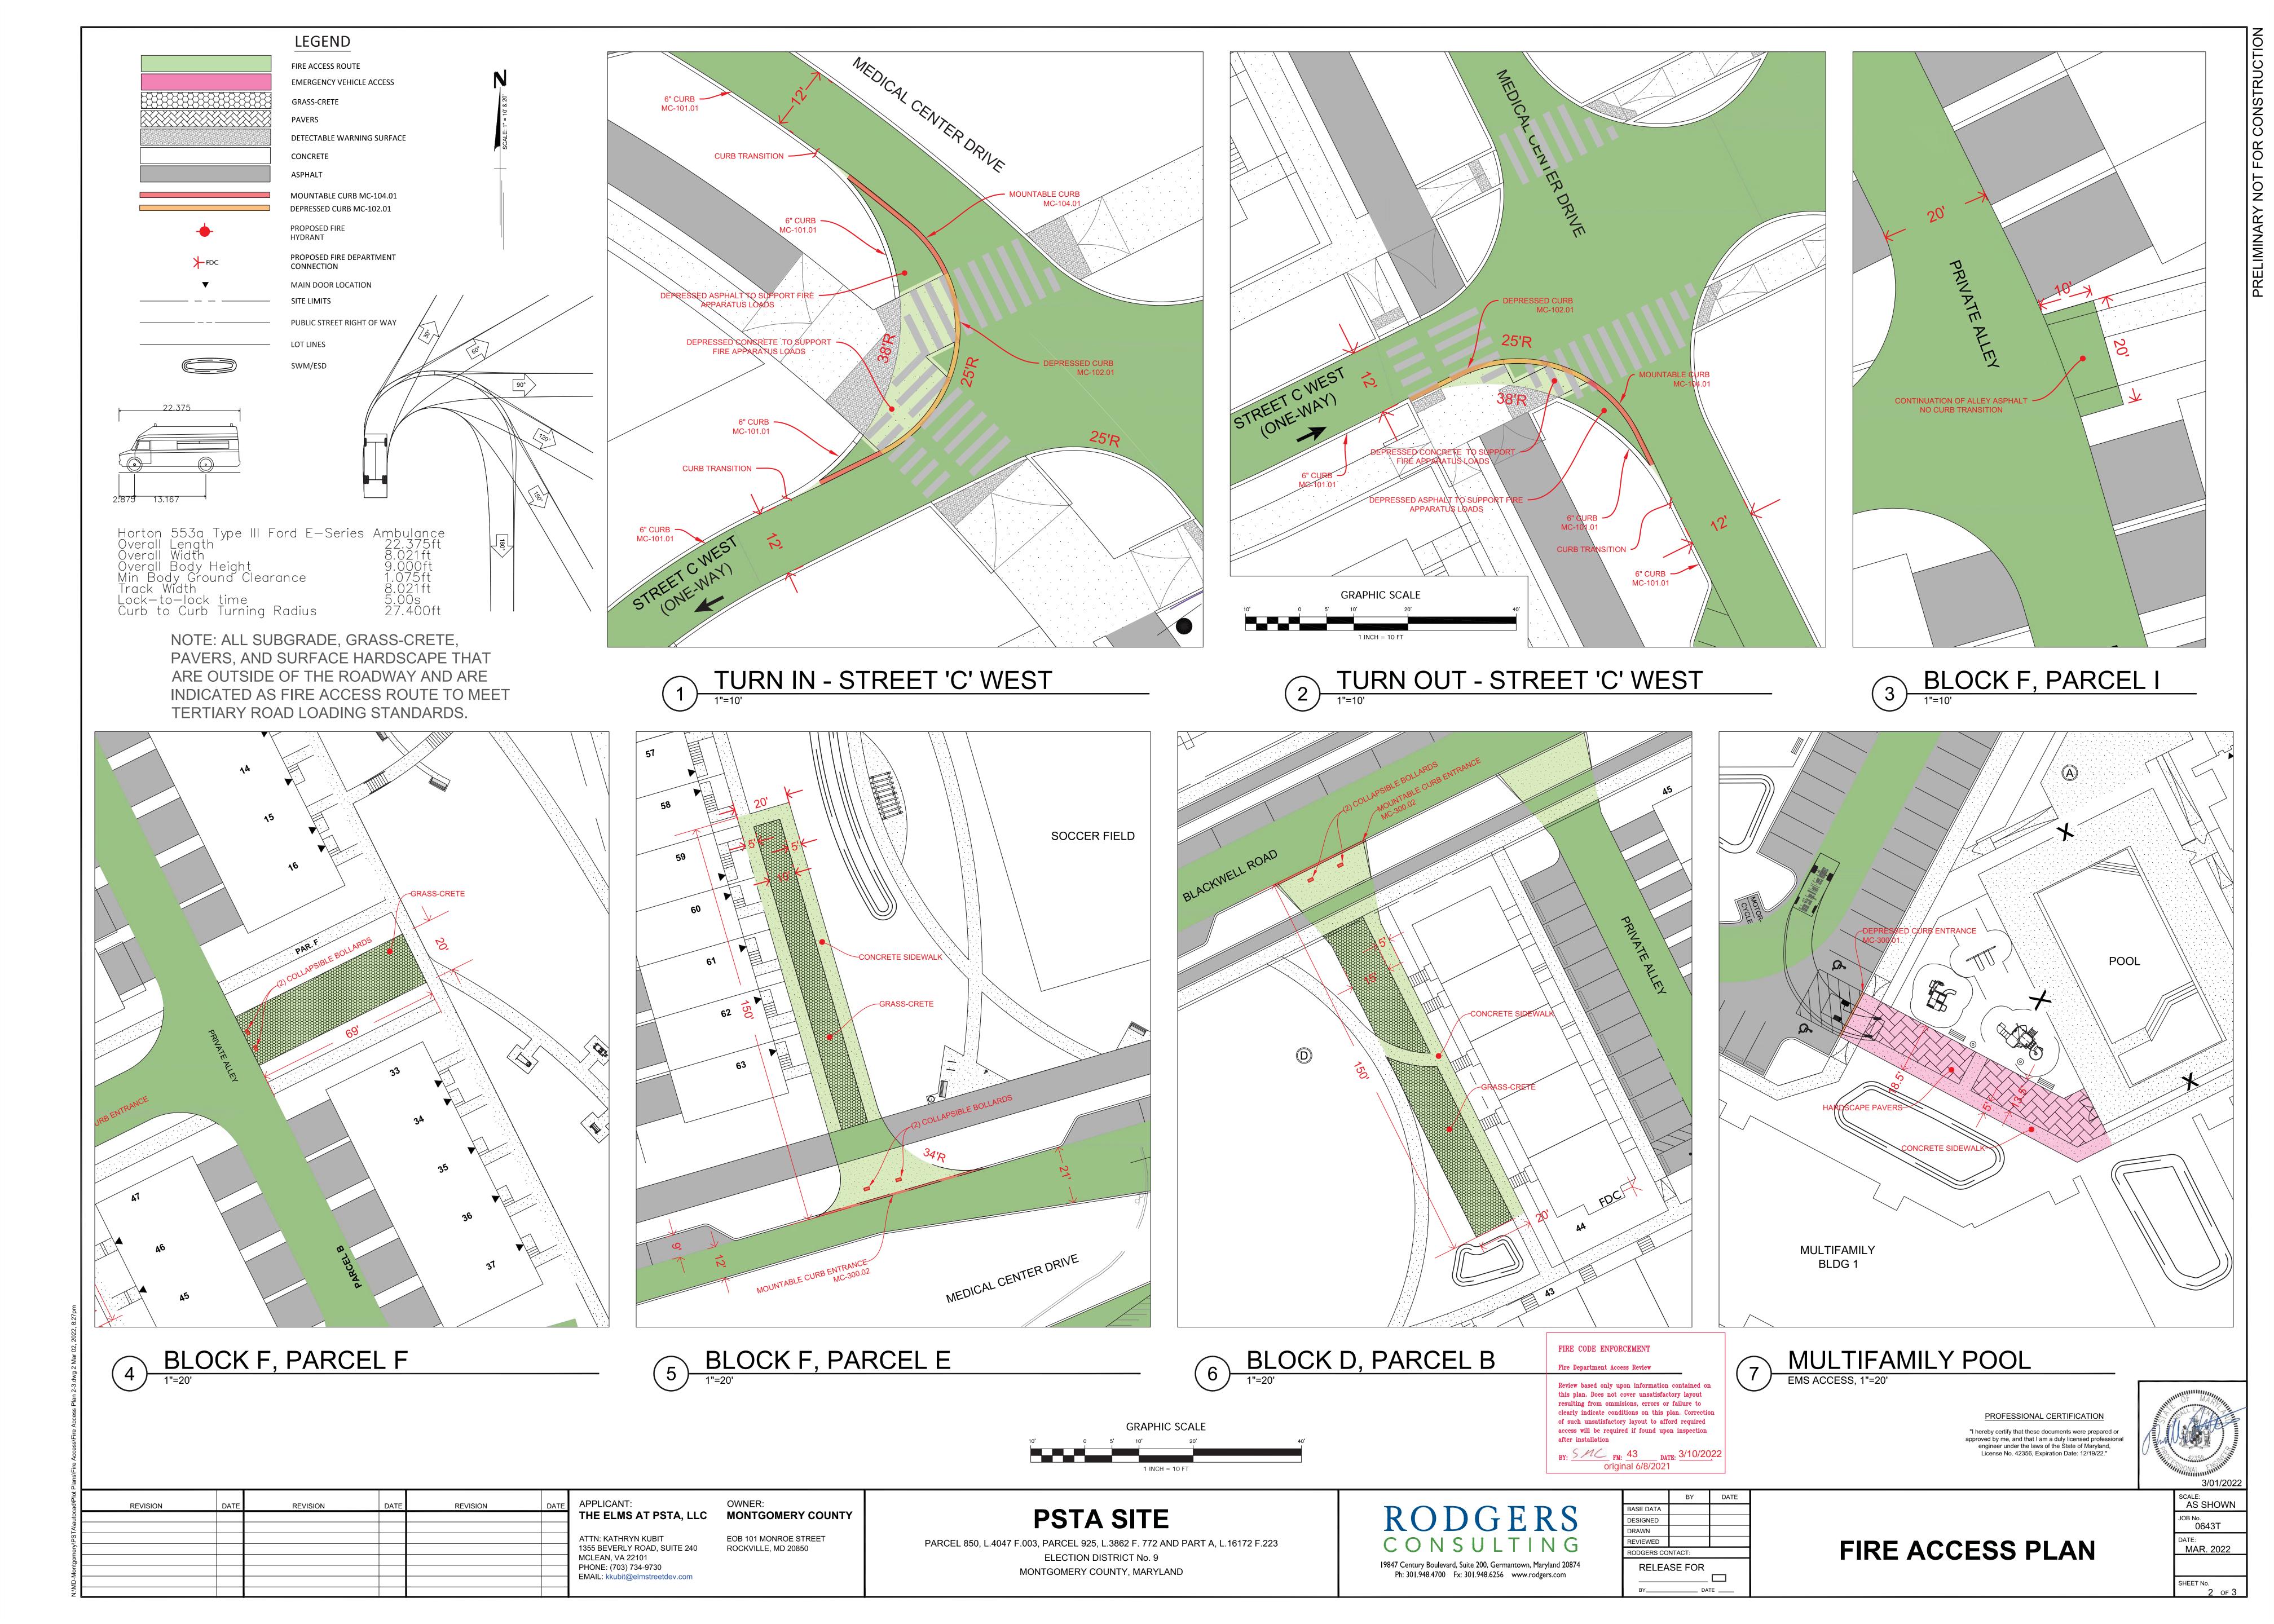

1. REFER TO MONTGOMERY COUNTY DEPARTMENT OF TRANSPORTATION SPECIFICATIONS FOR MATERIALS,

GENERAL NOTES

2. THIS STANDARD SHALL BE USED ON PRIMARY RESIDENTIAL, ARTERIAL AND BUSINESS DISTRICT ROADS AS WELL AS CURB RETURNS AND INLET THROATS.

METHODS OF CONSTRUCTION AND EXPANSION JOINT LOCATIONS.

- 3. WHENEVER STANDARD MC-101.01 CURB IS USED IN CONJUNCTION WITH THIS STANDARD, A TEN FOOT TRANSITION SHALL BE PROVIDED FROM STANDARD MC-100.01 TO STANDARD MC-101.01 FOR CURB RETURNS AND CURB SECTIONS WHICH INCLUDE INLETS.
- 4. THE STANDARD DISTANCE BETWEEN JOINTS SHALL BE TEN FEET (MAXIMUM AND MINIMUM DISTANCES SHALL BE THIRTEEN FEET AND FIVE FEET RESPECTIVELY).
- 5. EXPANSION JOINT MATERIAL SHALL BE 1/2 INCH PREFORMED CORK, TRIMMED AND SEALED WITH NON-STAINING TWO-COMPONENT POLYSULFIDE OR POLYURETHANE ELASTOMERIC TYPE SEALANT COMPLYING WITH ASTM-C920.

APPROVED 14 APR 06 REVISED		MONTGOMERY COUNTY	
DATE	ASTM-C920 4/2006	DEPARTMENT OF PUBLIC WORKS & TRANSPORTATION	
DIRECTOR, DEPT. OF PUBLIC WORKS & FRANSPORTATION		COMBINATION CONCRETE CURB AND GUTTER TYPE A	
A CHIEF, DIV. OF CAP. DEV.		STANDARD NO. MC-100.01	

POURED CONCRETE BASE, 3500 PSI

WITHIN SLAB

COMPACTED SUBGRADE

** 7" THICK CONCRETE SUBBASE AT DRIVEWAY ENTRANCES

GENERAL NOTES

Pavers shall be WATSONTOWN "Garden Blend" or approved equal, class SX, type I, have compressive strength of

an average water absorption rate of 4% or less, and shall conform to ASTM Designation of C-902.

Refer to Maryland State Highway Administration specifications for materials and methods of construction.

A tack coat of 2% neoprene-modified asphalt adhesive shall be used.

Provide 1/2" expansion joint where brick abuts a rigid structure.

Joint filler shall be one part Portland cement mixed with three parts sand.

The 28 day compressive strength for the concrete subbase shall be 3500 p.s.i.

10,000 psi for any five block tested, shall be capable of withstanding a min. of a 100 freeze—thaw cycles, have

The Bituminous setting shall consist of Hot Mix Asphalt Superpave 4.75mm for surface PG58-28 conforming to AASHTO

6" X 6" X 2.1 X 2.1 WELDED WIRE CONTINUOUS

1/4" X 7" STEEL EDGE FRAME BOLTED TO CONCRETE

TOP OF MULCH

DENSE GRADED AGGREGATE

BASE WITH 1/2" GALVANIZED WEDGE ANCHOR AND


WASHER, 18" C/C - PROVIDE WHERE BRICK DOES NOT ABUT A RIGID STRUCTURE. (SEE NOTE NO. 6.)

MONTGOMERY COUNTY

DEPARTMENT OF TRANSPORTATION

STREETSCAPE - PAVERS SIDEWALK

STANDARD NO. MC-111.02

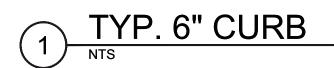

4" X 8" X 2 1/4"MIN. BRICK PAVERS WITH

ADHESIVE COAT-NEOPRENE MODIFIED ASPHALT

PRIMECOAT-LOW VISCOSITY LIQUID ASPHALT

3/4" BITUMINOUS SETTING BED (ADJUST

FINISH GRADE OF PAVEMENT -

designation M-320.

APPROVED

and Half

TYP. PAVERS


5 IYP. PAVERS
REQUIRED TO BE HARDSCAPE PAVERS

DIRECTOR, DEPARTMENT OF TRANSPORTATION

CHIEF, DIVISION OF THANSPORTATION ENGINEERING

THICKNESS IF PAVER THICKNESS VARIES)

HAND TIGHT JOINTS AND 3:1 SAND CEMENT SWEEP

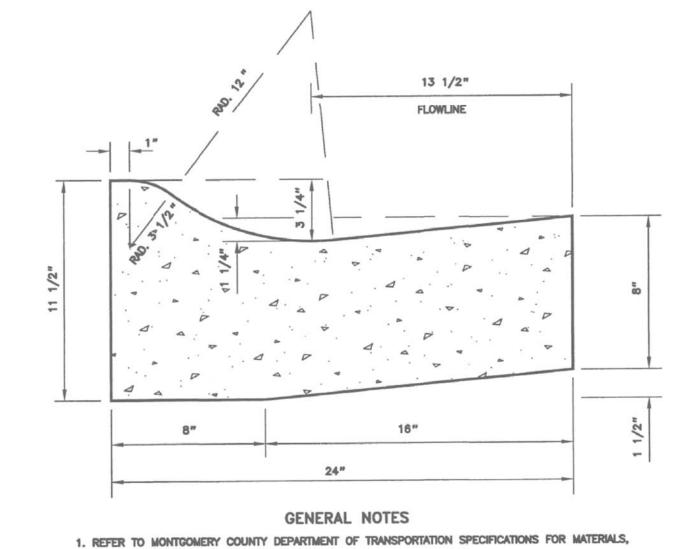


- METHODS OF CONSTRUCTION, AND EXPANSION JOINT LOCATIONS.
- 2. MOUNTABLE CURB SHALL ONLY BE USED ON TERTIARY STREETS OR ON SECONDARY RESIDENTIAL CUL-DE-SACS 500 FEET OR LESS IN LENGTH, MEASURED FROM THE LAST INTERSECTING STREET.
- 3. WHENEVER STANDARD MC-100.01 IS USED IN CONJUNCTION WITH THIS STANDARD, A TEN FOOT TRANSITION SHALL BE PROVIDED FROM STANDARD MC-104.01 TO STANDARD MC-100.01 FOR CURB RETURNS AND CURB SECTIONS WHICH INCLUDE INLETS.
- 4. TRANSITION BETWEEN STANDARD MC-104.01 AND MC-100.01 OR MC-101.01 SHALL BE ACCOMPLISHED HOLDING THE FLOW LINE SLOPE CONSTANT.
- 5. THE STANDARD DISTANCE BETWEEN JOINTS SHALL BE TEN FEET (MAXIMUM AND MINIMUM DISTANCES SHALL BE THIRTEEN FEET AND FIVE FEET RESPECTIVELY).
- 6. EXPANSION JOINT MATERIAL SHALL BE 1/2 INCH PREFORMED CORK, TRIMMED AND SEALED WITH

		OMPONENT POLYSULFIDE WITH ASTM—C920.	OR POLYURETHANE ELASTOMERIC	TYPE SEALANT
/FD	14 APR-106	REVISED	MONTGOMERY	COUNTY

APPROVED 14 APIL 106	REVISED ↑ ASTM-C920 4/2006	MONTGOMERY COUNTY DEPARTMENT OF PUBLIC WORKS & TRANSPORTATION
DIRECTOR, DEPT. OF PUBLIC WORKS & TRANSPORTATION		MOUNTABLE CONCRETE CURB AND GUTTER TYPE F
forger Sencino for CHIEF, DIV. OF CAP. DEV.		STANDARD NO. MC-104.01

TYP. MOUNTABLE CURB

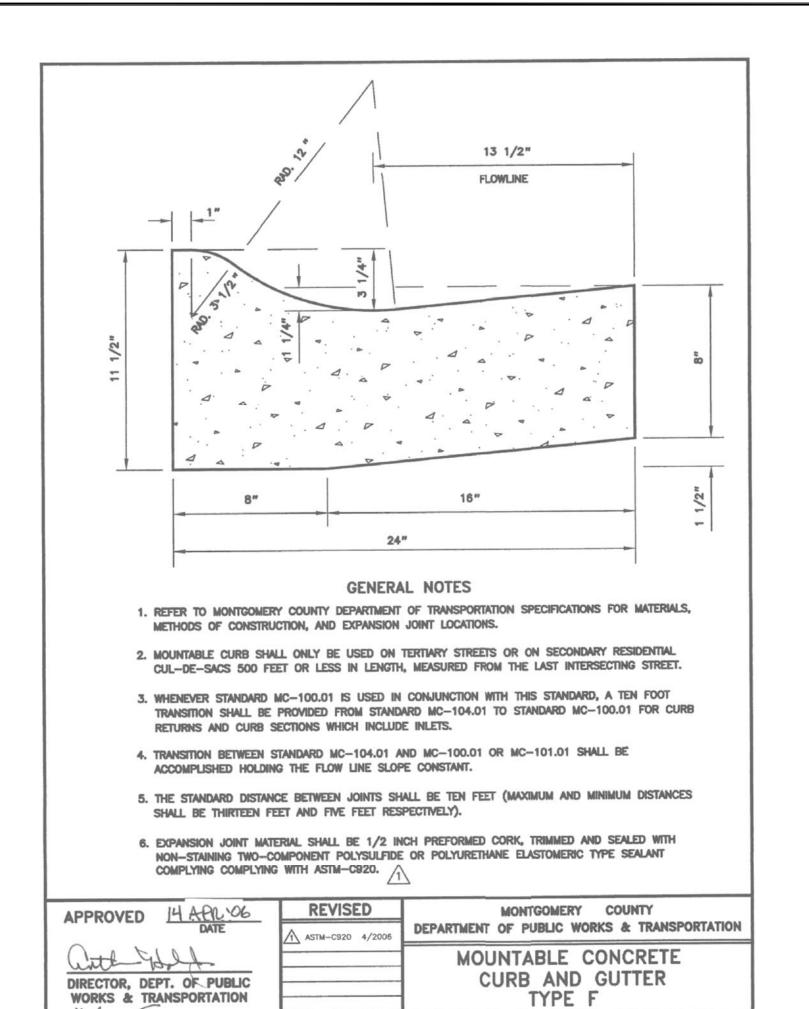

TYP. DEPRESSED CURB

TYPICAL WHEN SIDEWALK
CONSTRUCTION IS NOT PART OF
INITIAL CONSTRUCTION——

10' P.I.E.

MC-104.01

MOUNTABLE CURB | ROOFING PAPER -

-ROOFING PAPER

DRIVEWAY AND DRIVEWAY APRON TO BE MAINTAINED BY PROPERTY OWNER.

5. THIS STANDARD SHALL BE USED WITH MC-104.01 MOUNTABLE CURB ONLY.

3. CONCRETE APRONS SHALL BE USED WHEN CONCRETE SIDEWALK IS CONSTRUCTED.

PROPERTY LINE

MOUNTABLE CURB

MC-104.01

SCHIEF, DIV. OF CAP. DEV.

NOTE: ALL SUBGRADE, GRASS-CRETE, PAVERS, AND SURFACE HARDSCAPE THAT ARE OUTSIDE OF THE ROADWAY AND ARE INDICATED AS FIRE ACCESS ROUTE TO MEET TERTIARY ROAD LOADING STANDARDS.

10' -0" MINIMUM TO

20'-0" MAXIMUM

CONCRETE DRIVEWAY

SLOPE TO MEET TYPICAL SECTION ELEVATION

2% MINIMUM 10% MAXIMUM

SEE NOTE 3

4. CONCRETE APRONS SHALL BE SEVEN INCH MINIMUM THICKNESS WITH EXPANSION/CONTRACTION JOINTS

6. EXPANSION JOINT MATERIAL SHALL BE 1/2 INCH PREFORMED CORK, TRIMMED AND SEALED WITH NON- STAINING, TWO-COMPONENT POLYSULFIDE OR POLYURETHANE ELASTOMERIC TYPE SEALANT

EXPANSION JOINT (TYP.) -SEE NOTE 4

3" BIT. CONC. BASE COURSE OR 7" CONCRETE (OPTIONAL)

GENERAL NOTES

REFER TO MARYLAND STATE HIGHWAY ADMINISTRATION SPECIFICATIONS FOR MATERIALS AND METHODS OF CONSTRUCTION.

EXPANSION JOINT FOR

STANDARD NO. MC-104.01

TYPICAL WHEN SIDEWALK CONSTRUCTION IS CONCURRENT

RESIDENTIAL-

SIDEWALK

MC-110.01


VARIABLE DRIVEWAY SLOPE


MONTGOMERY COUNTY

TERTIARY DRIVEWAY

WITH APRON CONSTRUCTION


GRASS AREA 0

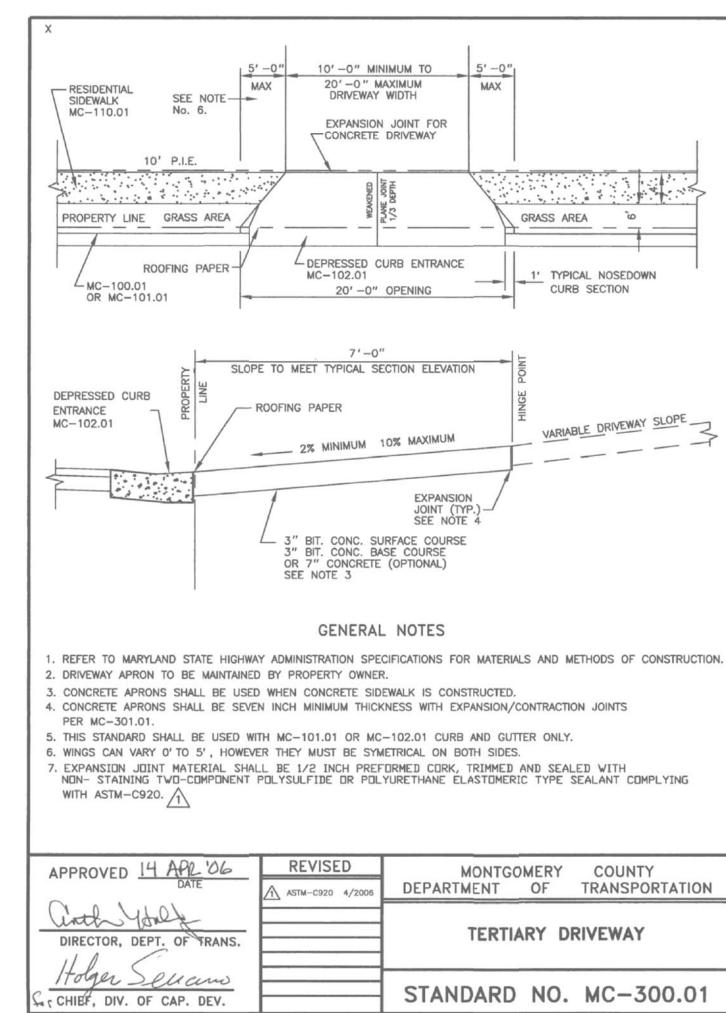

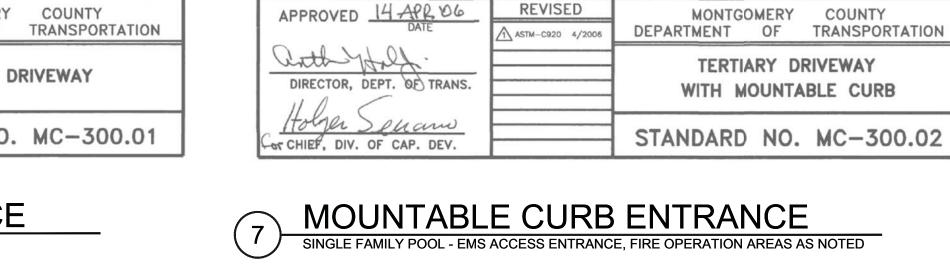


PER MC-301.01.


COMPLYING WITH ASTM-C920.

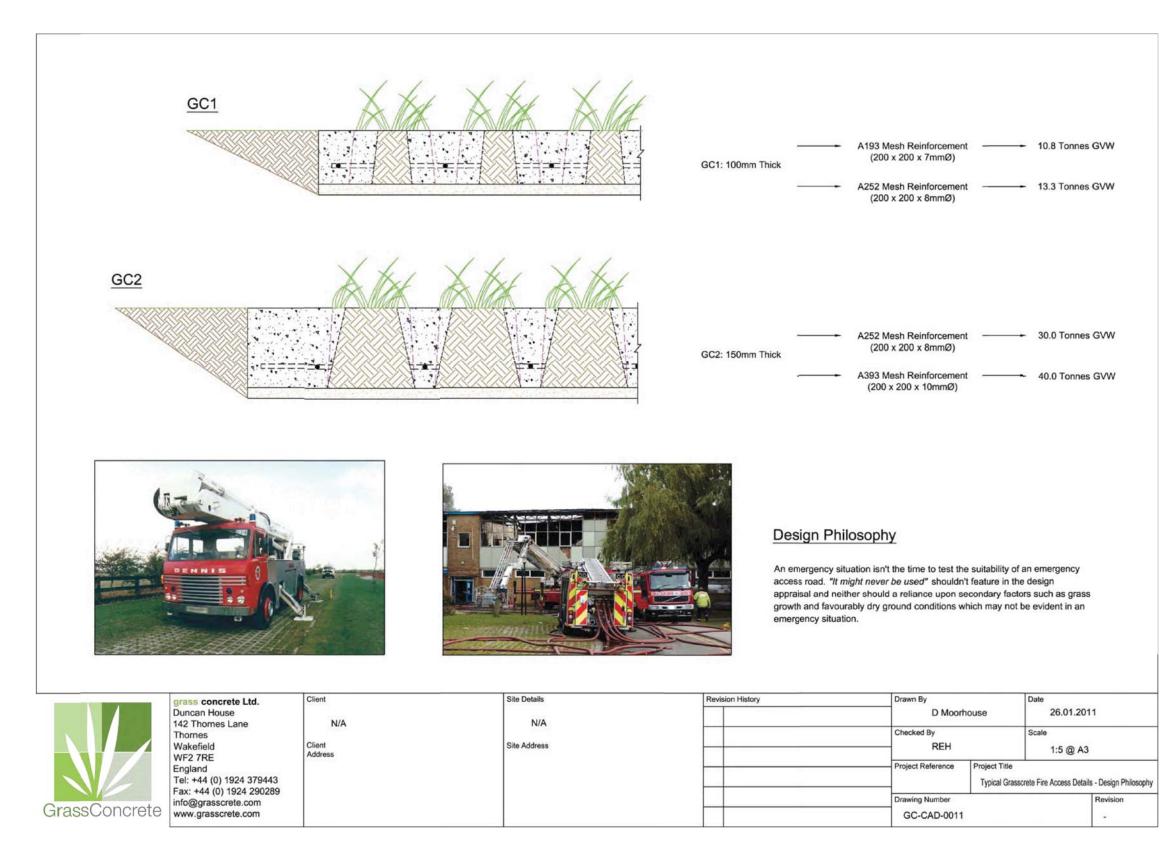



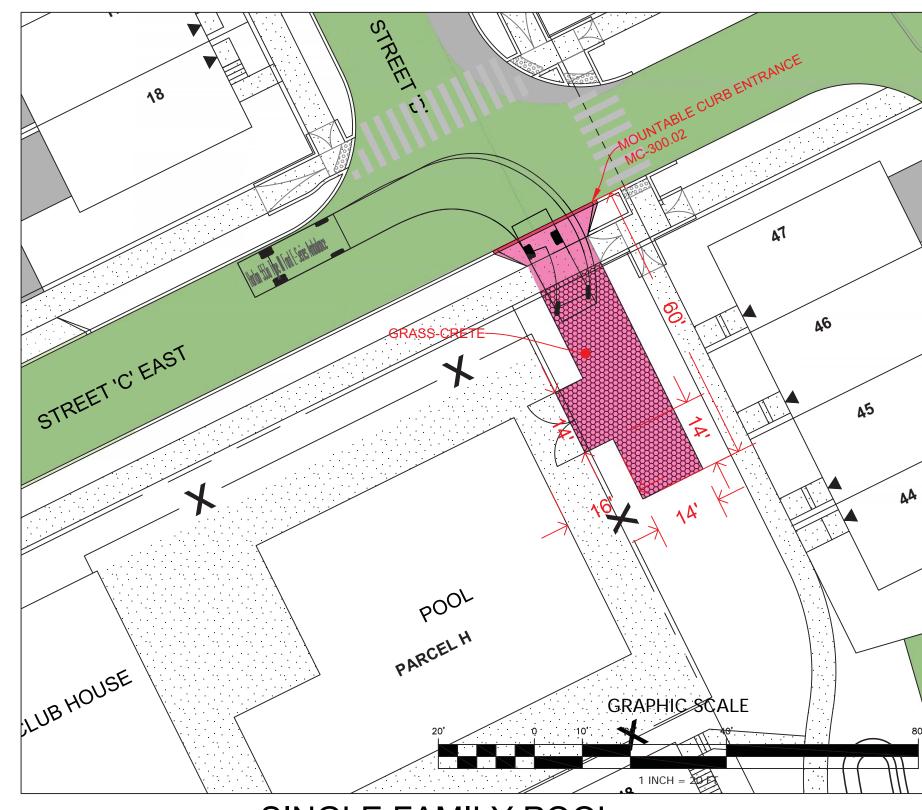

SINGLE FAMILY POOL EMS ACCESS, 1' = 20'

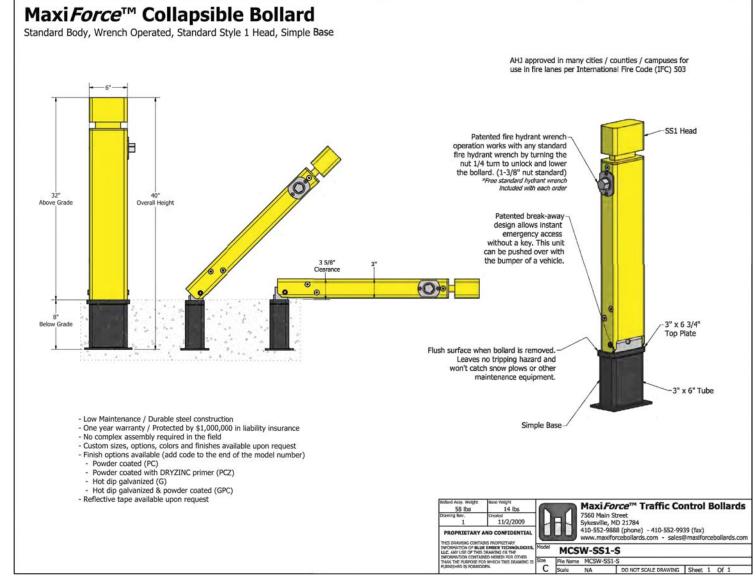

TYP. COLLAPSIBLE BOLLARDS

FIRE CODE ENFORCEMENT Fire Department Access Review Review based only upon information contained on this plan. Does not cover unsatisfactory layout resulting from ommisions, errors or failure to clearly indicate conditions on this plan. Correction of such unsatisfactory layout to afford required access will be required if found upon inspection after installation BY: 5 MC FM: 43 DATE: 3/10/2022 original 6/8/2021

PROFESSIONAL CERTIFICATION "I hereby certify that these documents were prepared or approved by me, and that I am a duly licensed professional engineer under the laws of the State of Maryland,

License No. 42356. Expiration Date: 12/19/22."

3/01/2022

DEPRESSED CURB ENTRANCE MULTIFAMILY POOL - EMS ACCESS ENTRANCE

APPLICANT:

OWNER: THE ELMS AT PSTA, LLC ATTN: KATHRYN KUBIT 1355 BEVERLY ROAD, SUITE 240 ROCKVILLE, MD 20850

PSTA SITE

RODGERS CONSULTING 19847 Century Boulevard, Suite 200, Germantown, Maryland 20874 Ph: 301.948.4700 Fx: 301.948.6256 www.rodgers.com

	BY	DATE	
BASE DATA			
DESIGNED			
DRAWN			
REVIEWED			
RODGERS CO	NTACT:		
RELEASE FOR			
BY	DA1	TE	

SCALE: 0643T MAR. 2022 SHEET No.

REVISION REVISION REVISION MCLEAN, VA 22101 PHONE: (703) 734-9730 EMAIL: kkubit@elmstreetdev.com

MONTGOMERY COUNTY EOB 101 MONROE STREET

PARCEL 850, L.4047 F.003, PARCEL 925, L.3862 F. 772 AND PART A, L.16172 F.223 ELECTION DISTRICT No. 9 MONTGOMERY COUNTY, MARYLAND

FIRE ACCESS PLAN