SEE SHEETS I-01 FOR FULL SHEET INDEX

MONTGOMERY COUNTY DEPARTMENT OF TRANSPORTATION EAST SILVER SPRING NEIGHBORHOOD GREENWAY

	RELA	ATED	REQUIRED PI	ERMITS				
IT IS THE RESPONSIBILITY OF THE PERMITTEE/OWNER OF THIS SITE TO OBTAIN ALL REQUIRED PERMITS PRIOR TO ISSUANCE OF THE SEDMENT CONTROL PERMIT								
TYPE OF PERMIT	REGD	NOT REGD	PERMIT NO.	EXPRIATION DATE	WORK RESTRICTION DATES			
MCOPS Sediment Control	х							
MCDPS Floodplain District		х						
WATERWAY/WETLAND(S)								
a. Corps at Engineers		х						
b. WCE		Х						
c. MDE Water Certification		х						
MDE Dom Safety		Х						
DPS Roodside Tree	x			Approval Date				
Protection Plan	_ ^							
N.P.D.E.S. HOTICE OF INTEM	x							

OWNER'S CERTIFICATION

I HEREBY CERTIFY THAT ALL CLEARING, GRADING, CONSTRUCTION AND/OR DEVELOPMENT WILL BE DONE PURSUANT TO THIS PLAN AND THAT ANY RESPONSIBLE PERSONNEL INVOLVED IN THE CONSTRUCTION PROJECT WILL HAVE A CERTIFICATE OF ATTENDANCE AT A DEPARTMENT OF NATURAL RESOURCES APPROVED TRAINING PROGRAM FOR THE CONTROL OF SEDIMENT AND EROSION BEFORE BEGINNION THE PROJECT.

DATE

JOSE THOMMANA ACTING CHIEF, DIVISION OF TRANSPORTATION ENGINEERING

DESIGN CERTIFICATION

I HEREBY CERTIFY THAT THIS PLAN HAS BEEN PREPARED IN ACCORDANCE WITH THE "1994 MARYLAND STANDARDS AND SPECIFICATIONS FOR SOIL EROSION AND SEDIMENT CONTROL*, MONTGOMERY COUNTY DEPARTMENT OF PERMITTING SERVICES EXECUTIVE REGULATIONS 5-90, 7-02AM AND 36-90, AND MONTGOMERY COUNTY DEPARTMENT OF TRANSPORTATION "STORM DRAIN DESIGN CRITERIA" DATED AUGUST 1988

STEVEN J. ZEENDER, P.E. MD. REGISTRATION NO. 31369

CERTIFICATION OF THE QUANTITIES

I HEREBY CERTIFY THAT THE ESTIMATED TOTAL AMOUNT OF EXCAVATION AND FILL AS SHOWN ON THESE PLANS HAS BEEN COMPUTED TO XXXX. CUBIC YARDS OF EXCAVATION, XXX. CUBIC YARDS OF FILL AND THE TOTAL AREA TO BE DISTURBED AS SHOWN ON THESE PLANS HAS BEEN DETERMINED TO BE 36,565 SQUARE FEET.

STEVEN J. ZEENDER, P.E. MD. REGISTRATION NO. 31369


The following standards are required for this project:

For all standards referred to on the plans the contractor must go to the MDOT SHA Book of Standards or Montgomery County design standards which will have the most current version. The Book of Standards can be accessed at:

http://apps.roads.maryland.gov/businesswithsha/bizStdsSpecs/desManualStdPub/publicationsonline/ ohd/bookstd/index.asp
https://www.montgomerycountymd.gov/dot-dte/common/standards.html

FROM FENTON STREET TO WAYNE AVENUE STATION 10+22 TO STATION 55+96

CIP PROJECT NO. 0501532

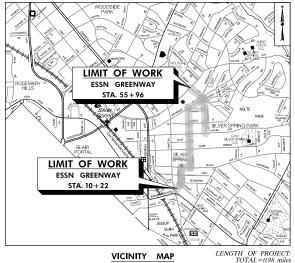

DESIGN TRAFFIC DATA

ROADWAY	GROVE STREET, BONIFANT STREE	WOODBURY DIVE, , CEDAR STREET,	
	HOUSTON	STREET	
CONTROLS / YEARS	2024		
AVERAGE DAILY TRAFFIC (A.D.T.)	N/A		
DESIGN HOURLY VOLUME (D.H.V.)	N/A		
DIRECTIONAL DISTRIBUTION	N/A		
% TRUCKS - A.D.T.	N/A		
% TRUCKS - D.H.V.	N/A		
DESIGN SPEED M.P.H.	20	MPH	
FUNCTIONAL CLASSIFICATION	LOCAL	STREET	
CONTROL OF ACCESS	NO	NE	
INTENSITY OF DEVELOPMENT	URE	BAN	
TERRAIN	ROLLING		
ANTICIPATED POSTED SPEED	20	MPH	

MISS UTILITY

THE CONTRACTOR SHALL CALL "MISS UTILITY" AT 1-800-257-7777, 48 HOURS PRIOR TO THE START OF WORK. THE CONTRACTOR IS RESPONSIBLE FOR ENSURING THAT ALL UNDERGROUND UNTILIES IN THE AREA OF PROPOSED WORK ARE LOCATED PRIOR TO COMMENCING CONSTRUCTION WORK. THE CONTRACTOR IS RESPONSIBLE FOR COMPLIANCE WITH REQUIREMENTS OF CHAPTER 36A OF THE WONTGOMERY COUNTY CODE.

THE CONTRACTOR IS ALSO RESPONSIBLE FOR LOCATING ALL PRIVATE UTILITIES (NOT LOCATED BY MISS UTILITY) MININ HOA PROBERTY AT THER EXPENSE. ALL UTILITIES SHOWN ON THE PLANS ARE PROVIDED FOR INFORMATION ONLY AND SHALL BE CONSIDERED APPROXIMATE. HOA SHALL NOT BE RESPONSIBLE FOR LOCATING UNDERFORMIND TUTLITES. ANY UTILITIES OR OTHER UNDERFORMOND TUTLITES. ANY UTILITIES OR OTHER UNDERFORMOND SHALL BE REPARKED, PREPARED AT THE CONTRACTOR'S SOLE EXPENSE.

NER SE THOMMANA D Edison Park Drive, 4th Floor Ithersburg, MD 20878 0-777-8730 se.thommana@montgomerycount		v		MATT JOHNSON, AICP 100 Edison Park Drive, 4th Gaithersburg, MD 20878 240-777-7237 matt.johnson@montgomery	
REVISION	BY	APP'D	DATE	DESIGNED BY: DHM III	DATE: MAY, 2024
				DRAWN BY: DHM III	DATE: MAY, 2024
				CHECKED BY: SJZ	DATE: MAY, 2024

TI-01 DEPARTMENT OF TRANSPORTATION

	NO.	REVISION	BY	APP'D	DATE	DESIGNED BY: DHM III	DATE: MAY, 2024		
						DRAWN BY: DHM III	DATE: MAY, 2024		
						CHECKED BY: SJZ	DATE: MAY, 2024		
						DRAWING NO.:	DATE:		
						RECOMMENDED FOR APPROVAL			_
						Chief, Design Section		Date	
Ш						_			
И						APPROVED			
-						Chief,	eering	Date	

PROFESSIONAL CERTIFICATION:
IHEREBY CERTIFY THAT THESE DOCUMENTS WERE PREPARED
OR APPROVED BY ME, AND THAT I AM: A DULY LICENSED
PROFESSIONAL ENGINEER UNDER THE LAWS OF THE STATE
OF MARYLAND.
LICENSE NO:
______EXPRATION_DATE:

🕥 Stantec

EAST SILVER SPRING NEIGHBORHOOD GREENWAY TITLE SHEET

DIVISION OF TRANSPORTATION ENGINEERING MONTGOMERY COUNTY, MARYLAND

SCALE: AS SHOWN

SHEET OOI of II3

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081	-	
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	LT-06	STREETLIGHT PLAN
084	LT-07	STREETLIGHT PLAN
085	LT-08	STREETLIGHT PLAN
086	LT-09	STREETLIGHT PLAN
087	LT-10	STREETLIGHT PLAN
880	LT-11	STREETLIGHT PLAN
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090	LT-13	STREETLIGHT PHOTOMETRIC ANAYSIS
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093	LT-16	STREETLIGHT PHOTOMETRIC ANAYSIS
094	LT-17	STREETLIGHT PHOTOMETRIC ANAYSIS
095	LT-18	STREETLIGHT PHOTOMETRIC ANAYSIS
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105	UT-02	UTILITY PLAN
106	UT-03	UTILITY PLAN
107	UT-04	UTILITY PLAN
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109	UT-06	UTILITY PLAN
110	UT-07	UTILITY PLAN
111	UT-08	UTILITY PLAN
112	UT-09	UTILITY PLAN
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Stantec

	NO.	REVISION	BY	APP'D	DATE	DESIGNED BY: DHM III	DATE: MAY, 2024	
						DRAWN BY: DHM III	DATE: MAY, 2024	
						CHECKED BY: SJZ	DATE: MAY, 2024	
						DRAWING NO.:	DATE:	
						RECOMMENDED FOR APPROVAL		
						Chief, Design Section		Date
						· ·		
						APPROVED		
1						Chief, Division of Transportation Engir	eering	Date

DEPARTMENT OF TRANSPORTATION DIVISION OF TRANSPORTATION ENGINEERING MONTGOMERY COUNTY, MARYLAND

> EAST SILVER SPRING NEIGHBORHOOD GREENWAY INDEX OF SHEETS

SHEET_002_of_II3

A.A.S.H.T.O American Association of State Highway	H.D.PHigh Density Polyetheylene	R Radlus
Transportation Officials	HDWL Headwall	REINFReInforcement
ABUT,Abutment	H.E.R.C.P Horizontal Elliptical Reinforced	REQ'DRequired
ADTAverage Daily Traffic	Concrete Pipe	R.FRock Fragments
AHD Ahead	H.PHigh Point	RTRight
APPROX Approximate	H.S.DHeadlight Sight Distance	ROW or RW Right of Way
B or B4LBaseline	INInch	RWRETAINING WALL
BKBack /Book	I.S.TInlet Sediment Trap	R.C.P. Reinforced Cement Pipe
BIT. Bituminous	INVInvert	R.C.C.PReinforced Cement Concrete Pipe
B.C. Bituminous Concrete	J.BJunction Box	R.Q.D. Rock Quality Desgnation
B.M. Bench Mark	KK Inlet	R.MRootmat
B.O.F. Bottom of Footing	L Length	S South
BOTBottom	L.FLinear Feet	SANSanitary Sewer
BRGBearing	L.LLiquid Limit	SBSouthbound
C.CCenter of Curve	LODLimit of Disturbance	S.DStorm Drain
CATV Cable Television	LONGLongitudinal	S.D.DSurface Drain Ditch
C.B.R. California Bearing Ratio	L.PLight Pole	SESuper Elevation
C.JContraction Joint	LTLeft	SFSilt Fence
© or CL Centerline	MACMacadam	S.F. Square Feet
CLClass or Clear	MCMolsture Content	SHLDRShoulder
CLF	MAX	
CMP	MDD	SHAState Highway Administration
		SHTSheet
C.OCleanout	MOD Modified	S.P.PStructural Plate Pipe
COMB Combination	MINMinimum	S.P.TStandard Penetration Testing
CONC Concrete	MN	S.SStainless Steel
CONSTR Construction	M.S.E Mechanically Stablilized Earth	SSDStopping Sight Distance
CORCorner	N North	SSFSuper Silt Fence
CORRCorrection	NBNorthbound	STDStandard
C.YCubic Yard	NE Northeast	STAStation
DC Degree of Curve	NONumber	STIFFStiffener
D.H.V Design Hourly Volume	NPNon-Plastic	SOSingle Opening
D.IDrop Inlet	N.T.SNot To Scale	
DIADiameter	O.COn Center	S.YSquare Yards
	O.COff Certier	SWMStormwater Management
D.O Double Opening	OHOverhead	TTangent
D.SDesign Speed	OMCOptimum Moisture	TTelephone
DWG Drawing	PAV'TPavement	TBRTo Be Removed
EEast	PCPoint of Curvature	T.CTop of Cover
EElectric	PCCPoint of Compound Curvature	TEMP Temporary
eExternal Distance	P/CPoint of Crown	TCETemporary Construction Easement
EAEach	P/GEProfile Grade Elevation	T.GTop of Grate
EBEastbound	P.G.L. Profile Grade Line	T or TLTraverse Line
E.JExpansion Joint	P.GL Profile Ground Line	T.MTop of Manhole
EL. or ELEV Elevation	PPlate	T.O.FTop of Footing
E.R.C.C.P. Elliptical Reinforced Cement	P/RPoint of Rotation	TRAVTraverse
Concrete Pipe	P.I. Plasticity Index	
	P.I	TSTemporary Swale
ESEnd Section	P.IPoint of intersection	T.STop of Slab
EX. or EXIST Existing	POCPoint On Curve	T.STopsoll
FTFeet	POT Point On Tangent	TYPTypical
F or FL Flowline	PRProposed	U.DUnder Drain
F.B.DFlat Bottom Ditch	PR. ROW Proposed Right of Way	U.GUnderground
F.HFire Hydrant	PROPProposed	U.O.N Unless Otherwise Noted
F.OFiber Optic	PRCPoint of Reverse Curve	U.PUtility Pole
F.O.C. Face of Curb	PTPoint	USCUnified Soil Classification
F.S. Full Super Elevation	PTPoint of Tangency	USDA United States Department of Agricultu
FWD. Forward	PVCPoint of Vertical Curve	
		VCLVertical Clearance
GGas	P.V.CPolyvinyl Chloride	V.C.LVertical Curve Length
GLGutterline	PVIPoint of Vertical Intersection	W
GPGeneral Purpose Roadway	PVRCPoint of Vertical Reverse Curve	W
G.VGas Valve	PVTPoint of Vertical Tangency	WBWestbound
H.BHandbox		W.MWater Meter
		W.S. Wrapped Steel

ABBREVIATIONS

EXISTING RIGHT OF WAY LINE ... CUT SLOPE .. PROPOSED RIGHT OF WAY LINE FILL SLOPE .. PROPOSED TRAFFIC BARRIER EXISTING TRAFFIC BARRIER. SILT FENCE . EXISTING WOOD FENCE LINE. SUPER SILT FENCE EXISTING CHAIN LINK FENCE LINE DIVERSION FENCE... BASE OR SURVEY LINE STONE CHECK DAM ... EXISTING FIRE HYDRANT. TEMPORARY STONE OUTLET STRUCTURE TSOS TEMPORARY GABION OUTLET STRUCTURE PROPOSED STORM DRAIN EXISTING STORM DRAIN.... AT-GRADE INLET PROTECTION ... EXISTING INLET.... CURB INLET PROTECTION ... CIP COIP EXISTING UTILITY POLE. COMBINATION INLET PROTECTION. Ö. EXISTING TREE MEDIAN INLET PROTECTION... EXISTING TREE LINE ... STANDARD INLET PROTECTION... TEST HOLE LOCATION EXISTING TREE TO BE REMOVED STABILIZED CONSTRUCTION ENTRANCE... PROPOSED TREE

SYMBOLS

AB-01

Stantec



	NO.	REVISION	BY	APP'D	DATE	DESIGNED BY: DHM III	DATE: MAY, 2024	
						DRAWN BY: DHM III	DATE: MAY, 2024	
						CHECKED BY: SJZ	DATE: MAY, 2024	
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						RECOMMENDED FOR APPROVAL		
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М						Chief, Design Section		Date
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N						APPROVED		
	_							
38						Chief,		Date
_						Division of Transportation Engir	eering	

DEPARTMENT OF TRANSPORTATION DIVISION OF TRANSPORTATION ENGINEERING MONTGOMERY COUNTY, MARYLAND

EAST SILVER SPRING NEIGHBORHOOD GREENWAY ABBREVIATIONS AND SYMBOLS

SHEET_004_ of_ II3_ SCALE: NONE

THE SPECIFICATIONS FOR THIS CONTRACT WILL BE THOSE OF THE MARYLAND STATE HIGHWAY ADMINISTRATION DATED JULY 2023, ALL ERRATA AND ADDENDA THERETO, AND. THE MARYLAND

STATE HIGHWAY ADMINISTRATION BOOK OF STANDARDS FOR HIGHWAY AND INCIDENTAL STRUCTURES.

- 2. FOR CONSTRUCTION, HORIZONTAL SHALL BE BASED ON NAD 83/91DATUM AND VERTICAL SHALL BE BASED ON NAVD 1988 DATUM.
- INFORMATION CONCERNING UNDERGROUND UTILITIES WAS OBTAINED FROM AVAILABLE RECORDS, BUT THE CONTRACTOR MUST DETERMINE THE EXACT LOCATION AND ELEVATIONS OF THE UNDERGROUND UTILITIES BY DIGGING TEST HOLES BY HAND AT ALL UTILITY CROSSINGS WELL IN ADVANCE OF TRENCHING. IF CLEARANCE IS LESS THAN SHOWN OR SIX (6) INCHES, WHICHEVER IS LESS, CONTACT MONTGOMERY COUNTY DEPARTMENT OF TRANSPORTATION PROJECT INSPECTOR AND THE MDOT SHA UTILITY INSPECTOR BEFORE PROCEEDING WITH CONSTRUCTION.
- 4. REPAIRS TO UTILITIES OR PROPERTY DAMAGE AS A RESULT OF THE CONTRACTOR'S NEGLIGENCE OR METHOD OF OPERATION MUST BE MADE AT THE CONTRACTOR'S EXPENSE BEFORE PROCEEDING
- 5. CALL "MISS UTILITY" AT I-800-257-7777 FORTY-EIGHT (48) HOURS PRIOR TO BEGINNING EXCAVATION TO DETERMINE THE EXACT LOCATION OF EXISTING UTILITIES.
- 6. CLEARING IS TO BE LIMITED TO THE "LIMIT OF DISTURBANCE" AS SHOWN ON THE PLANS.
- 7. ALL GRADING SHALL BE DONE IN SUCH A MANNER AS TO PROVIDE POSITIVE DRAINAGE.
- THE CONTRACTOR SHALL OBTAIN A ROADSIDE TREE PERMIT FOR ANY MAINTENANCE, TREATMENT. PLANTING, REMOVAL, OR ROOT CUTTING ON TREES WITHIN MDOT SHA RIGHT OF WAY. PERMIT REQUIREMENTS MAY BE OBTAINED FROM THE DEPARTMENT OF NATURAL RESOURCES. MARYLAND FOREST, PARK AND WILDLIFE SERVICE, TELEPHONE 301-854-6060.
- THE LOCATION OF RIGHT-OF-WAY AND EASEMENT LINES SHOWN ON THE PLANS ARE FOR INFORMATION AND GUIDANCE ONLY, NO GUARANTEE IS MADE AS TO THE ACCURACY OF SAID LOCATIONS, PLEASE REFER TO THE APPROPRIATE RIGHT-DE-WAY PLATS.
- THE CONTRACTOR SHALL INSTALL PEDESTRIAN DETECTABLE WARNING SURFACES AT ALL SIDEWALK & PEDESTRIAN CROSSING LOCATIONS AS DIRECTED BY THE ENGINEER AS PER ADA SPECIFICATION. THE WARNING SURFACES SHALL BE IN CONFORMANCE WITH ADA REQUIREMENTS AND THE PROJECT
- THE DESIGN FOR THIS PROJECT HAS INCORPORATED FACILITIES FOR THE ELDERLY AND HANDICAPPED IN COMPLIANCE WITH STATE AND FEDERAL LEGISLATION.
- 12. ALL PROPOSED BUS STOPS SHALL BE ADA COMPLIANT.

GENERAL NOTES

HORIZONTAL DATUM: MARYLAND STATE PLANE COORDINATE SYSTEM

NAD 83/91 VERTICAL DATUM: NAVD 1988 SURVEY UNIT:

MARCH 2020, SUPPLEMENTED MAY 2023 DATE OF SURVEY:

SURVEY PERFORMED BY: MERCADO CONSULTANTS INC. 17830 NEW HAMPSHIRE AVE. SUITE 200

ASHTON, MD 2086I PHONE: 301-260-0090 FAX: 301-260-0018

ALL DIMENSIONS, STATIONS, AND ELEVATIONS ARE IN SURVEY FEET UNLESS OTHERWISE

THE CONTRACTOR IS RESPONSIBLE FOR VERIFYING EXISTING TOPOGRAPHIC FEATURES. AND ELEVATIONS, ABOVE AND BELOW GROUND, PRIOR TO BEGINNING CONSTRUCTION

THE CONTRACTOR SHALL BRING TO THE NOTICE OF THE ENGINEER ANY DISCREPANCY BETWEEN THE PLANS AND ACTUAL FIELD CONDITIONS.

A BOUNDARY SURVEY WAS PERFORMED, IF ANY DISPUTE ARISES AS TO THE LOCATION OF RIGHT-OF-WAY LINES, PROPERTY LINES, OWNERSHIP, ETC., ADDITIONAL CONSULTATION WITH A MARYLAND-LICENSED SURVEYOR IS ADVISED.

DATE OF INVESTIGATION: JUNE 2023 UTILITY INVESTIGATION QL/D

PERFORMED BY: STANTEC CONSULTING SERVICES, INC.

810 GLEN EAGLES CT., SUITE 300 BALTIMORE, MD 21286

PHONE: (4I0) 583-6700 FAX: (4I0) 583-6704

UTILITY MAPPING (QUALITY LEVEL D) WAS PREPARED BASED ON RECORDS PROVIDED BY UTILITY OWNERS FOR THIS PROJECT.

- THE CONTRACTOR SHALL NOTIFY MISS UTILITY ONE CALL (8II OR 800-257-7777) 48 HOURS BUT NOT MORE THAN IO DAYS PRIOR TO ANY EXCAVATION WORK.
- IT IS THE CONTRACTOR'S RESPONSIBILITY TO LOCATE ALL LITHLITIES PRIOR TO REGINNING
- THE FOLLOWING UTILITY COMPANIES SHALL ALSO BE SPECIFICALLY NOTIFIED SIX WEEKS PRIOR TO THE BEGINNING OF CONSTRUCTION:

PEPCO. TOLU TANI-OLU. 30I-22I-82I7 FIBERLIGHT, MATT TRACEY, 703-395-4138 WASHINGTON GAS LIGHT COMPANY, COLIN BURKE, 703-750-5541 COMCAST, DWAYNE DOUTY, 301-762-7863 WASHINGTON SUBURBAN SANITARY COMMISSION, KEVIN LETHBRIDGE, 301-206-7339 VERIZON, JON BOBEL, 301-282-2942 VERIZON BUSINESS, ADAM RICE, 571-220-8978

- 5. NO MECHANIZED EQUIPMENT SHALL BE USED FOR EXCAVATION IN CLOSE PROXIMITY TO UTILITIES.
- 6. THE CONTRACTOR SHALL LISE HAND EXCAVATION METHODS WHEN EXCAVATION OCCURS WITHIN 24"
- 7. THE CONTRACTOR IS RESPONSIBLE FOR SUPPORTING AND PROTECTING EXISTING UTILITIES AS DIRECTED BY THE ENGINEER AND UTILITY OWNER, THE CONTRACTOR IS RESPONSIBLE FOR ANY DAMAGES TO EXISTING UTILITIES DUE TO NEGLIGENCE.

GN-OL DEPARTMENT OF TRANSPORTATION

🕥 Stantec 🛭



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Priority Areas	Γ
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REVISION

DATE: MAY, 2024 DRAWN BY: DHM III DATE: MAY, 2024 HECKED BY: SJZ DRAWING NO.: DATE: RECOMMENDED FOR APPROVAL Chief, Design Section Date APPROVED Chief, Division of Transportation Engineering

APP'D DATE

DESIGNED BY: DHM I

DATE: MAY, 2024

DIVISION OF TRANSPORTATION ENGINEERING MONTGOMERY COUNTY, MARYLAND

EAST SILVER SPRING NEIGHBORHOOD GREENWAY GENEAL NOTES

SHEET 003 of II3 SCALE: NONE

EXPIRATION DATE:


Attachment A: Corridor Engineering Drawings BASELINE DATA 10+00,00 481284,1424 1305660,2650 N 40° 04' 35,0946' E 12+31.98 N 2" 10' 20,3092" E 17+76.51 20+00.00 482008.5796 1305760.9812 S 87* 41' 27.5077' E TRAVERSE POINTS TRAV PT MER 134 TRAV PT MER 135 482068-4862 1305494,3858 349,7700 TRAV PT MER 136 348,2700 TRAV PT MER 137 481237,3234 344,0400 PT_20+00.00 TRAV PT MER 205 317,5200 TRAV PT MER 206 482303.5058 1306119.4035 336.6400 TRAV PT MER 207 482013.6038 344,4900 TRAV PT MER 208 347.9400 WOODBURY DRIVE TRAV PT MER 210 482035.0108 1305813.6975 349,0400 TRAV PT MER 211 14+00 481764.0218 345.1100 TRAV PT MER 212 481474.2876 1305768.1224 338,9000 WOODBURY DRIVE TRAV PT MER 251 338.5700 TRAV PT MER 253 349.6200 TRAV PT MER 254 346.3500 TRAV PT MER 255 481779,2393 1305777,184 345,4200 TRAV PT MER 256 481297,2477 1305648,0141 343,7800 TRAV PT MER 257 482017,7331 345,0200 TRAV PT MER 258 482037.1272 346.8800 TRAV PT MER 309 334.2900 N 4881470 E 1306070 105+00 103+00 GROVE STREET STA, 23 + 62,16 -STA, 100 + 00,00 PT 24+13.51 DEPARTMENT OF TRANSPORTATION DRAWN BY: DHM III DATE: MAY, 2024 DIVISION OF TRANSPORTATION ENGINEERING MONTGOMERY COUNTY, MARYLAND CHECKED BY: SJZ DATE: MAY, 2024 DRAWING NO.: RECOMMENDED FOR APPROVAL **Stantec**

PROFESSIONAL CERTIFICATION: IHEREBY CERTIFY THAT THESE DOCUMENTS WERE PREPARED OR APPROVED BY ME, AND THAT I AM A DULY LICENSED PROFESSIONAL ENGINEER UNDER THE LAWS OF THE STATE OF MARYLAND.


Date Chief, Design Section Chief, Division of Transportation Engineering

EAST SILVER SPRING NEIGHBORHOOD GREENWAY GEOMETIC LAYOUT

SCALE: 1"=50" SHEET_005_ of _______113_ **Attachment A: Corridor Engineering Drawings** GL-01 E 1305910 | SHEET MER 201 TRAV PT -MER 203 - TRAV PT MER 307 STA. 119 + 10.65 = STA. 42 + 01.26 STA, 106+50 109+00 110+00 112+00 +50 113+00 +50 115+00 118+00 +50 119+00 GROVE STREET GROVE STREET GROVE STREET BONIEANT STREET MATCH LINE STA. 44+50 - SEE SHEET GL-03 TRAVERSE POINTS TRAV PT 69PN 1305412.8845 347.1000 TRAV PT MER 130 1305447.6030 334.6500 E 1306300 342.6900 TRAV PT MER 202 483668.622 1306045.7174 337.9000 TRAV PT MER 202 483404,0786 1306053,1736 321,2800 TRAV PT MER 204 483055,9231 1306092,4568 311.3200 TRAV PT MER 250 308,6100 TRAV PT MER 252 483431.9141 1306076.3314 322.4900 TRAV PT MER 30 TRAV PT MER 308 482697 9296 1306109.8886 314,3100 BASELINE DATA TRAV PT MER 353 483571.2625 1306072.1508 332,5000 POINT NO. 119+10.65 483903,0667 1306045,4865 N 2° 19′ 14.1772° W 483797,0167 1305874.4339 N 58° 12' 06,0880° E DATE: MAY, 2024 REVISION APP'D DATE DEPARTMENT OF TRANSPORTATION DRAWN BY: DHM III DATE: MAY, 2024 DIVISION OF TRANSPORTATION ENGINEERING MONTGOMERY COUNTY, MARYLAND CHECKED BY: SJZ DATE: MAY, 2024 DRAWING NO.: DATE RECOMMENDED FOR APPROVAL **Stantec** EAST SILVER SPRING Chief, Design Section NEIGHBORHOOD GREENWAY GEOMETIC LAYOUT Chief, Division of Transportation Engineering SCALE: 1"=50"

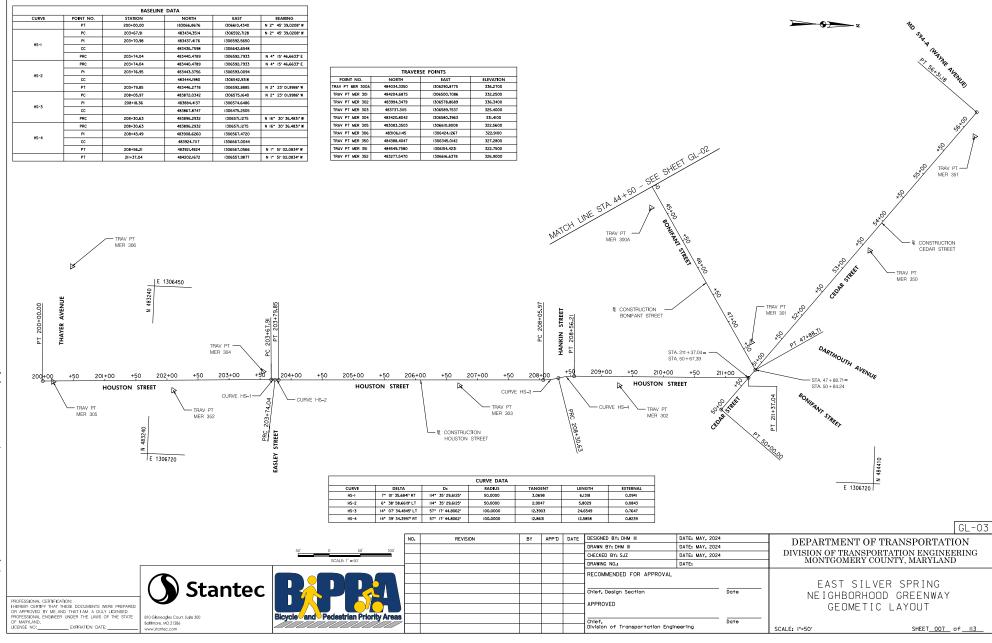

/2024 1527-f0l\shared_pro]ects\20262|3|22\700_CADD\700_Sheet\pG

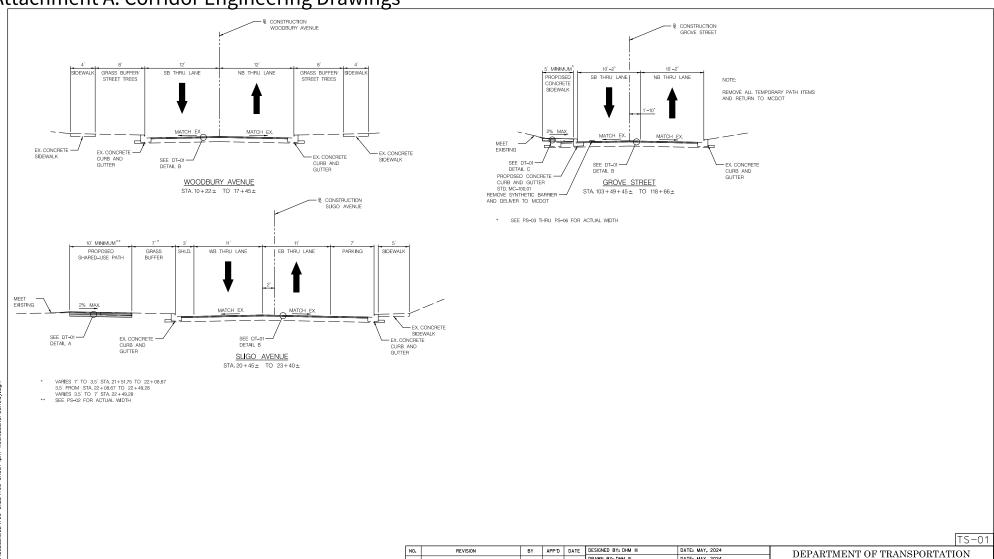

PROFESSIONAL CERTIFICATION:
HERBEY CERTIFY THAT THESE DOCUMENTS WERE PREPARED
OR APPROVED BY ME, AND THAT I AM A DUXY LICENSED
OF MARTINATO,
LICENSE NO:
EXPRAITION DATE:

EXPRAITION DATE:


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LETT = 5


DIVISION OF TRANSPORTATION ENGINEERING MONTGOMERY COUNTY, MARYLAND


EAST SILVER SPRING NEIGHBORHOOD GREENWAY TYPICAL SECTIONS

SCALE: 1'=5' SHEET_008_ of __113

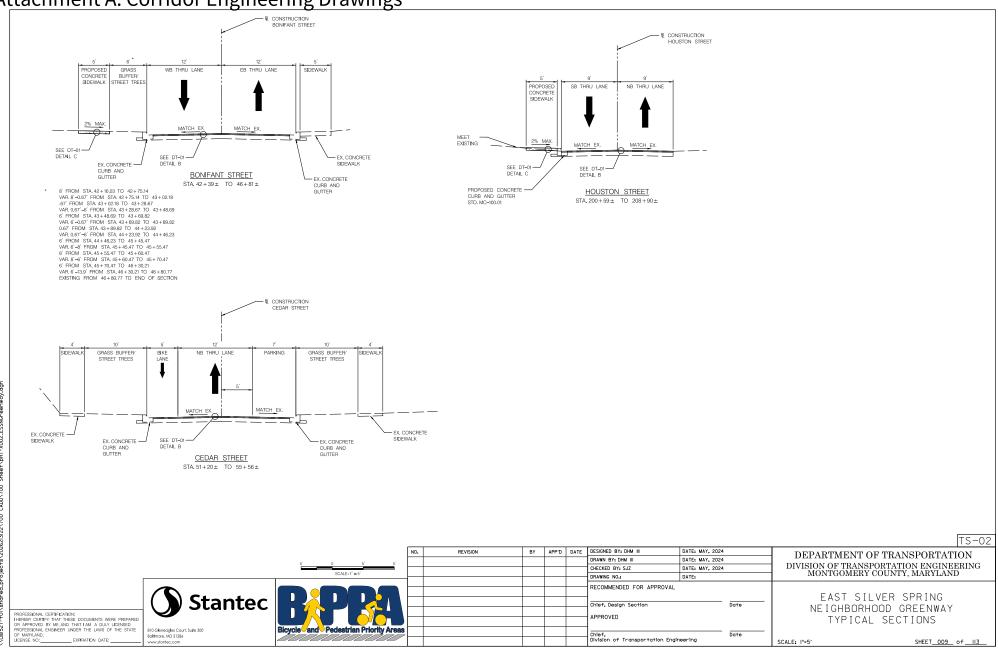

5/22/2024

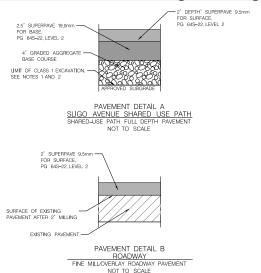

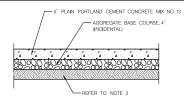

REVISION

PAVEMENT DETAIL C

NOTES:
SUBGRADE PREPARATION SHALL BE AS PER SPECIFICATIONS; PHIOR TO PLACEMENT
OF PROPOSED BASE COURSE, SUBGRADE SHALL BE PROFF-ROLLED.
UNDEROUT FOR REMOVAL OF SOFT ANDOR UNSUITABLE MATERIALS SHALL BE AS
DIRECTED BY THE ENGINEER.
WHEN THE SUBBASE MATERIAL IS DETERMINED TO BE UNSUITABLE BY THE ENGINEER.
CURRICT TURN MATERIAL WITH A URPRATIVE COMPACCION OF MAYOR INSUITABLE. COMPACT THE MATERIAL WITH A VIBRATORY COMPACTOR OR REMOVE UNSUTTABLE
MATERIAL AND REFILL WITH COMPACTED GRADED AGGREGATE BASE IN LIFTS NO GREATER
THAN 4 INCHES IN DEPTH AS DIRECTED BY THE ENGINEER
ALL FULL DEPTH ROADWAY PAVEMENT WIDENING SHALL BE A MINIMUM UP 4' WIDE.

DT-0I

Stantec



CHECKED BY: SJZ DATE: MAY, 2024 DRAWING NO.: DATE: RECOMMENDED FOR APPROVAL Date Chief, Design Section APPROVED Chief, Division of Transportation Engineering

DATE: MAY, 2024

DESIGNED BY: DHM III

DRAWN BY: DHM III

APP'D DATE

EAST SILVER SPRING NEIGHBORHOOD GREENWAY PAVEMENT DETAILS

DEPARTMENT OF TRANSPORTATION

DIVISION OF TRANSPORTATION ENGINEERING MONTGOMERY COUNTY, MARYLAND

SCALE: NTS SHEET_010_ of __113_

STRUCTURE TOP INVERT DIRECT DIRECT DIRECT DIRECT DIRECT DIRECT DIVERS DIRECT DI	TICN	DIRECT	INVEST	TOP	STRUCTURE
001 338.67 330.99 NE 330.99 NE 330.99 SE 330.9		Dinec	044400	ELEVATION	D NUMBER
330.92 SE 330.95 SW 330.95 SW 002 328.93 32.56 NE 331.79 E 331.79 E 331.79 E 331.81 SW 004 346.17 335.64 E 335.46 SW 336.45 W 005 348.09 339.13 SE 006 342.46 333.22 NW 007 339.94 323.32 NW 033.43 NE 008 337.96 323.32 NW 323.15 SE 009 338.03 BOLTED SHUT 010 337.35 BOLTED SHUT 011 332.37 322.10 N 021 317.41 301.40 SE 304.45 SW 301.49 NE 012 317.41 301.40 SE 304.45 SW 014 308.93 296.91 N/A 015 317.16 296.91 N/A 015 317.16 296.91 N/A 015 317.16 296.91 N/A 016 311.47 CANNOT OPEN 017 311.48 303.45 SW 033.45 SE 018 317.50 308.89 N/A 019 311.75 308.88 N/A 019 311.75 308.88 N/A				338.60	001
002 328.93° 330.95° 5W 003 339.87° 332.26° NE 331.83° 5W 004 346.17° 335.64° E 335.40° 5W 005 348.09° 339.13° 5E 006 342.46° 333.22° NW 007 339.94° 323.32° NW 323.68° NW 323.26° NW 323.27° SE 010 337.33° BOLTED SHUT 011 332.30° 322.10° NS 014 308.93° 325.10° SE 012 317.41° 301.40° SE 013 324.28° 314.77° N/A 014 308.93° 296.91° N/A 015 317.16° 299.32° 5W 016 311.72° A03.45° NS 016 311.72° A03.45° NS		SE	220.021		
003 339.87 332.36 NE 331.79 E 331.79 E 331.87 SW 631.87 SW 635.46 E 335.46 SW 636.45 W 636.45		SW	330.95		
331.75 E 331.75 E 331.75 E 331.75 E 331.75 E 331.87 SW 336.45 SW 336.45 W 336.45 W 336.45 W 336.45 W 337.46 333.22 NW 337.46 333.22 NW 337.47 NP 3		N/A	320.92	328.93	002
331.75 E 331.75 E 331.75 E 331.75 E 331.75 E 331.87 SW 336.45 SW 336.45 W 336.45 W 336.45 W 336.45 W 337.46 333.22 NW 337.46 333.22 NW 337.47 NP 3		NE	222.261	220.07	002
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004 346.17 335.64 E 335.66 SW 336.45 W 36.45 W 306.45 W 3					
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333.43° NE 337.96° 323.27 W 323.08° NW 323.15° SE 009 338.03° BOLTED SHUT 010 337.33° BOLTED SHUT 011 332.30° 322.10° NE 012 317.41° 301.40° SE 309.44° SW 301.49° NE 013 324.28° 314.77° N/A 014 308.93° 296.91° N/A 015 317.16° 299.32° SW 298.61° N 298.60° E 016 311.72° A03.45° SW 018 317.50° 308.89° N/A 018 317.50° 308.89° N/A 019 311.72° 303.56° SW		NW	323.34	339.94°	007
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015 317.16 299.32 5W 286.61 N 298.60 E 016 311.47 CANNOT OPEN 017 311.48 303.45 5W 303.41 SE 018 317.50 308.89 N/A 019 311.72 303.56 5W		N/A	314.77	324.28	013
016 311.47 CANNOT OPEN 017 311.48' 303.45' SW 903.41' SE 018 317.50' 308.89' N/A 019 311.72' 303.56' SW		N/A	296.91	308.93"	014
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016 311.47 CANNOT OPEN 017 311.48' 303.45' SW 903.41' SE 018 317.50' 308.89' N/A 019 311.72' 303.56' SW		N	298.61		
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017 311.48' 303.45' SW 303.41' SE 018 317.50' 308.89' N/A 019 311.72' 303.56' SW		OPEN	CANNOT	311.47	016
303.41' SE 018 317.50' 308.89' N/A 019 311.72' 303.56' SW					
018 317.50' 308.89' N/A 019 311.72' 303.56' SW		SW	303.45	311.48	017
019 311.72' 303.56' SW		SE	303.41		
019 311.72' 303.56' SW		N/A	308.89	317.50	018
202.041 ME		SW	303.56	311.72	019
303.84 INE		NE	303.84"		
				224 555	000
020 321.56' 309.03' 5 309.06' SW		CIAL	309.03	321.30	020
309.06' SW		5W	309.06		
310.13° NW		NW	310.13		
021 323.62' 314.35' N/A		N/A	314.35	323.62"	021

STRUCTURE ID NUMBER	ELEVATION	INVERT	DIRECTION
022	321.66	313.42	NW
		314.55	NE
		312.25	SE
023	343.34	336.50	N/A
024	345.71	337.37	N/A
025	337.89	327.71	
026	345.35	333.51	
027	337.32	326.87	NE
		327.15	SW
028	334.69	324.92	NE
		324.94	SW
029	330.64	BOLTED S	HUT
030	327.53	318.20	NW
		318.34	SE
031	323.56	CANNOT	ORTH
031			
032	322.52	316.23	
		316.19	w
033	335.49	BOLTED S	нит
034	331.70'	318.35"	NW
		210.24	SE
		318.58	W
035	333.83	220.25	NW
033	333.43	320.29	
		320.36	SW
036	337.30	328.11	N/A
037	343.34	333.66	NE
		333,97	SW
038	338.60	ASPHALT	
039	328.76	322.97	N/A
040	344.14	340.66° 340.74°	NW
		340.74	SW
041	343.96	340.16	w
		340.06	NE
			SE
042	343.96	340.15	w
UNZ	343.70	340.15	NW
		340.08	SW
			N
043	342.69	338.81"	
043	342.69	220.00	er
043	342.69	339.44° 338.83°	SE W
		339.44° 338.83°	SE W
043	342.69' 342.52'	220.00	SE W

STRUCTURE	TOP		
ID NUMBER	ELEVATION	INVERT	DIFECTION
045	342.14	338 42	N
		338.48	SE
		338.48' 338.35'	W
046	341.78	332.61	
		338.14	S
4	200.00	***	NW
047	337.40	325.41° 325.21°	E
		331.45	S
		332.43	3
048	336.69	324.89	W
		321.12	NW
049	317.36	307,54	SE1
		308.06	SEZ
050	316.93	307.39	
		307.45	NW
	244.004	200.00	NW
051	316.92	306.86	
		307,19	5W
052	316.82	306.32	NIW
032	310.00	306.39	
053	314.64	304.29	N
		304.51	5
054	309.42	302.90	NE
		303.08	SE
055	308.60	299.55	NE
		302.19	SW
		299.55' 302.19' 300.89' 300.87'	NW1 NW2
		300.67	INNIZ
056	N/A	304.49	SW
	14.1	304.41	E
057	N/A	307.20	N/A
058	300.40	293.81	N/A
059	308.35'	303.94	N/A
060	308.31	303.85	N/A
060	308.31	303.85	N/A
061	312.08	306.76	N
202	312.00	307.67	NE
		303.49	SE
062	312.16	308.17	NE
		308.041	SW
063	315.21	311.50	N/A
064	313.18	309.49	SW
		309.42	SE
OCE	214.10	CANINOV	COREM
065	314.19	CANNOT	OPEN

STRUCTURE ID NUMBER		INVERT	DIRECTION
067	322.10	312,14	NW
		316.47	NE
		311.43	5
068	321.92	313.78	sw
		312.99	SE
		315.83	S
069	321.74	316,36	N/A
070	322.54	316.21	N/A
071	322.14	317.11	N/A
072	N/A	323.34	N/A
073	N/A	321,77	N/A
074	323.52	321.05	N/A
075	323.83	320.58	NW
		320.77	SE
076	324.85	322.07	N/A
077	N/A	N/A	N/A
078	314.99'	CANNOT	OPEN

Stantec


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		П
	Bicycle and Pedestrian Priority Areas	

	NO.	REVISION	BY	APP'D	DATE	DESIGNED BY: DHM III	DATE: MAY, 2024	
						DRAWN BY: DHM III DATE: MAY, 2024		
						CHECKED BY: SJZ DATE: MAY, 2024		
						DRAWING NO.:	DATE:	
						RECOMMENDED FOR APPROVAL		
М								
М						Chief, Design Section Date		Date
М								
М						APPROVED		
98	_							
=						Chief, Date Division of Transportation Engineering		
						bivision of manaportation Engin	ee ng	

DEPARTMENT OF TRANSPORTATION DIVISION OF TRANSPORTATION ENGINEERING MONTGOMERY COUNTY, MARYLAND

> EAST SILVER SPRING NEIGHBORHOOD GREENWAY EXISTING MANHOLE AND PIPE INVERTS

SHEET_OII_of_II3 SCALE: NONE

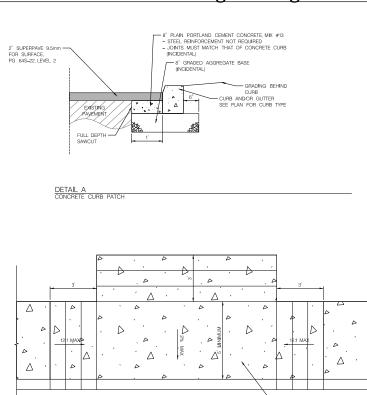

SUSTING

PAYEMENT

FULL DEPTH SAWCUT,

SEE DETAIL. A

THIS SHEET

DETAIL C

<u>EGEND</u>

- 1) 8 INCH GRADED AGGREGATE BASE, TWO EQUAL LAYERS
- 2 STANDARD TYPE 'C' CURB AND GUTTER, MDOT SHA STD. NO. 620.02-01
- (3) 12" LONGITUDINAL TIE DEVICE, 8" LENGTH 36" O.C. "
- (4) 11 INCH STAMPED CONCRETE TRAFFIC BEARING PORTLAND CEMENT MIX; PATTERN: AS DIRECTED BY THE ENGINEER

MCDOT DEPRESSED CONCRETE CURB AND GUTTER AT DRIVEWAY APRONS

DETAIL B

CONCRETE DRIVEWAY APRON

DT-03

DESIGNED BY: DHM III REVISION APP'D DATE DEPARTMENT OF TRANSPORTATION DRAWN BY: DHM III DATE: MAY, 2024 DIVISION OF TRANSPORTATION ENGINEERING MONTGOMERY COUNTY, MARYLAND CHECKED BY: SJZ DATE: MAY, 2024 DRAWING NO.: DATE: RECOMMENDED FOR APPROVAL **Stantec** EAST SILVER SPRING Date Chief, Design Section NEIGHBORHOOD GREENWAY APPROVED ROADWAY DETAILS Chief, Division of Transportation Engineering SCALE: NTS SHEET_012_ of __113_

527-fol\shared_projects\2026213122\700 CADD\700 Sheet\pHD-D003_ESSNGreenway.dgn

Attachment A: Corridor Engineering Drawings FENTON STREET PS-01 PS-05 PS-06 PS-10 DRAWN BY: DHM III DATE: MAY, 2024 DIVISION OF TRANSPORTATION ENGINEERING MONTGOMERY COUNTY, MARYLAND CHECKED BY: SJZ DATE: MAY, 2024 DRAWING NO.: RECOMMENDED FOR APPROVAL **Stantec** EAST SILVER SPRING NEIGHBORHOOD GREENWAY ROADWAY PLAN KEY Chief, Division of Transportation Engineering SCALE: 1"=200" SHEET_0I3_ of __II3_

Attachment A: Corridor Engineering Drawings E 1305630 CIP 0501532 ESSN GREENWAY |E 1305630 STA. 10 + 22 7902 WOODBURY DR. L.41715 F.0282 TAX ID 00988702 PLAT 267 DANIEL W. SMITH & HERWOOD R. ROBERSON 7904 WOODBURY DR. L.7094 F.0467 TAX ID 00989661 RUSH HI SEALE & KATIE A. SHEKETOFF 908 GIST AVE. L.40857 F.0349 TAX ID 00987833 PLAT 626 FAUSTO PETRONE & ANNA PETRONE 7906 WOODBURY DR-L.5546 F.0240 TAX 1D 00988985 PLAT 267 CONSTRUCTION T/MOTHY A. SPROCK & MARGARET S. JOHNSTON/7908_WOODBURY DR. MICHAEL J. BARROW & CAT THY HUYNH PHAM 7901 WOODBURY DR. L.57534 F.0107 TAX/ID 00987467 PLAT 267 REX M. BUTLER & EMIKO BUTLER 7918 WOODBURY DR. L.6901 F.0615 TAX ID 00993047 PLAT 267 L.65485 F.0391 TAX ID 00989422 PLAT 229 KATHRYN A. HIGGINS & JAMES J. HIGGINS 7940 WOODBURY DR. LJ45717 F.0134 TAX ID 0D989546 PLAT 267 THEODORE NORTHROP & JULIA NORTHROP 7912 WOODBURY DR. L.61109 F.0362 TAX ID 00988074 PLAT 267 MANUEL J. LOPES & ROSA LOPES 7914 WOODBURY DR. L.6294 F.0789 TAX ID 00991733 PLAT 267 TO SLIGO AVENUE SHERRI J. NORRIS 8000 WOODBURY DR. 1.22542 F.0255 TAX 1D 00987822 PLAT 626 PS-02 SHEET EX-MH) 16 L.58332 F.0425 TAX ID 00990124 PLAT 229 RODNEY B. WALLACE & LISA A. WALLACE 7907 WOODBURY DR. L.15694 F.01/16 TAX ID 00988495 PLAT 229 +50 WOODBURY DRIVE WOODBURY DRINE STA. MTCH ALEXANDER E. LOBKOVSKY MEITIV & DANIELLE J. LUTTENBERG MEITIV 7911 WOODBURY DR. L.34749 F.0677 MARK E. FOSTER 7915 WOODBURY DR. L.21332 F.0053 TAX ID 00987365 PLAT 229 HOLLAND G. MCKENNA 8001 WOODBURY DR. L.10320 F.0501 TAX ID 00988438 PLAT 229 213122\700 CADD\700 Sheet\pHD-POOL_ESSNGr € CONSTRUCTION - WOODBURY DRIVE 0243458 E 1305920 PROP. DETECTABLE WARNING SURFACE PROP. SHARED USE PATH PAVEMENT PROP. CONCRETE PAVEMENT REMOVAL PS-01 PROP, STAMPED CONCRETE DESIGNED BY: DHM II PROP. ROADWAY FINE MILL & OVERLAY DEPARTMENT OF TRANSPORTATION PROP. ROADWAY PAVEMENT DRAWN BY: DHM III DATE: MAY, 2024 DIVISION OF TRANSPORTATION ENGINEERING MONTGOMERY COUNTY, MARYLAND CHECKED BY: SJZ DATE: MAY, 2024 DRAWING NO.: DATE RECOMMENDED FOR APPROVAL Stantec EAST SILVER SPRING Chief, Design Section NEIGHBORHOOD GREENWAY PROFESSIONAL CERTIFICATION:
HEREBY CERTIFY THAT THESE DOCUMENTS WERE PREPARED
OR APPROVED BY ME, AND THAT I AM A DULY LICENSED
PROFESSIONAL ENGINEER UNDER THE LAWS OF THE STATE
OF MARYLAND.
DEPRATION DATE: APPROVED ROADWAY PLAN Chief, Division of Transportation Engineering SHEET_014_ of __113_ SCALE: 1"=20"

Attachment A: Corridor Engineering Drawings N 482140 MATCH LINE STA. 101+00 - SEE SHEET PS-03 WOODMONT SILVER
SPRING ACADEMY LLC
811 SLIGO AVE.
L.58836 F.0057
TAX ID 03381461
——PLAT 22273 JENNIFER ANGARITA 8004 GROVE ST L.63788 F.0390 TAX ID 03833098 PLAT 25517 CHIJIOKE DOZIE & NWANDU IFUNANYA MONTGOMERY COLINTY 801 SLIGO AVE. L. F. TAX ID 03833112 PLAT 25517 TO FENTON STREET ASPHALT PAVEMENT SLIGO AVENUE SLIGO AVENUE SLIGO AVENUE Q. PT 17+76.51 GRASS B CONSTRUCTION #828 LISA RENEE LEE BUCHANAN, TRUSTEE
| EDGEFIELD LEGACY | IRREVOCABLE TRUST | 838 SLIGO AVE. | 8 SLIGO AVE. | 4 CL. 66763 F. 0048 | TAX ID 02893312 | PLAT 17975 | BROCK ID WILLIAM F. GRIFFITHS JOSEPH P. FITZGERALD 3 JEAN HILL FITZGERALD 828 SLIGO AVE. L.5263 F.0223 TAX ID 00992373 *832 RISTOPHER J. SCHWA & LUCY GILLERS 832 SLIGO AVE. L.45505 F.0026 TAX ID 00989262 & JANET C. DUNN 834 SLIGO AVE. L.7457 F.0765 TAX ID 00988017 PLAT 285 JESSICA SHANNON & ANDREW BAUMANN IRA J. SHERTZER & EMILY C. EMRICK 836 SLIGO AVE. _____30725 F.0213 BEKELE DEBELE NAGEWO & MIMI GELETA 844 SLIGO AVE. L.45524 F.0029 TAX ID 00992522 ALINA M. PTASZYNSKI &
MATTHEW R. PTASZNSKI
8005 WOODBURRY DR.
L.53321 F.0080
TAX 10 00992043
PLAT 285 WOOD FENCE O MH N 481890 ₿ CONSTRUCTION N 481890 MATCH LINE STA. 16+25 - SEE SHEET PS-01 PROP. DETECTABLE WARNING SURFACE PROP. SHARED USE PATH PAVEMENT PROP. CONCRETE PS-02 PROP, STAMPED CONCRETE PROP. ROADWAY FINE MILL & OVERLAY DESIGNED BY: DHM III APP'D DATE DEPARTMENT OF TRANSPORTATION PROP. ROADWAY PAVEMENT DRAWN BY: DHM III DATE: MAY, 2024 DIVISION OF TRANSPORTATION ENGINEERING MONTGOMERY COUNTY, MARYLAND CHECKED BY: SJZ DATE: MAY, 2024 DRAWING NO.: DATE: RECOMMENDED FOR APPROVAL Stantec EAST SILVER SPRING Chief, Design Section NEIGHBORHOOD GREENWAY APPROVED ROADWAY PLAN Chief, Division of Transportation Engineering SCALE: 1"=20" SHEET_0I5_of_II3

Attachment A: Corridor Engineering Drawings TOWNS ON GROVE HOA GROVE STREET L.63540 F.0450 TAX ID 03832983 PLAT 25517 E 1305990 E 1305990 010 JAMES A. MILNE & CAROLINE R. MILNE 2 SILVER SPRING AVE. L.50663 F.0249 RAX ID 01045082 PLAT 54 DAHNA GOLDSTEIN & SARAH A. ALTSCHULLER 8803 SILVER SPRING AVE L.49999 F.0324 TAX ID 01041186 PLAT 54 ĒO GRAS STONE STONE WOOD FENCE GARY A RUMAAIN ET AL 8112 GROVE ST 16 / STEVAN LIBERMAN 800 SILVER SPRING AVE. L.58225 F.0117 TAX ID 01042738 PLAT 54 PR. · PS 5 STA. 8 WOOD FEN STA. WOOD HOLLOW HOA
TWIN HOLL CANE
L. F. WOOD FENCE
TAX ID 02390276
PLAT 14745 GRASS CONSTRUCTION GROVE STREET SEE NOTE 1-/EX-MH MATCH ## 361 SILVER SPRING ASSC LLP 761 SILVER SPRING AVE. - PR. L.14775 F.0020 TOE TAX ID 01047081 PLAT 54 CHRISTOPHER S PETERSON REBECCA DEARDEN ADDIS ALEMAYCHOU 727 TWIN HOLLY LN. L.17286 F.0324 TAX ID 02390298 PLAT 14745 RALPH E. WATKINS 8113 GROVE ST. L.11378 F.0360 TAX ID 01045628 PLAT 54 DLIVER DEARDEN B111 GROVE ST. L.57401 F.0005 TAX ID 01045878 PLAT 54 JOAQUIN MARTINEZ & JAMILLAH J. ECHEVERRIA 759 SILVER SPRING AVE. ISABELLE WILLIAMS
T60 SILVER SPRING AVE.
L.36260 F.0237
TAX ID 01042408
PLAT 54 L.42993 F.0346 TAX ID 01041302 ALL TEMPORARY MEDIANS AND FLEXPOSTS PROP. DETECTABLE WARNING SURFACE PROP. SHARED USE PATH PAVEMENT PROP. CONCRETE PS-03 PROP, STAMPED CONCRETE DESIGNED BY: DHM II DATE: MAY, 2024 PROP. ROADWAY FINE MILL & OVERLAY REVISION APP'D DATE DEPARTMENT OF TRANSPORTATION PROP. ROADWAY PAVEMENT DRAWN BY: DHM III DATE: MAY, 2024 DIVISION OF TRANSPORTATION ENGINEERING MONTGOMERY COUNTY, MARYLAND CHECKED BY: SJZ DATE: MAY, 2024 DRAWING NO.: DATE RECOMMENDED FOR APPROVAL **Stantec** EAST SILVER SPRING Chief, Design Section Date NEIGHBORHOOD GREENWAY APPROVED ROADWAY PLAN Chief, Division of Transportation Engineering SHEET_016_ of _______113_ SCALE: 1"=20"

Attachment A: Corridor Engineering Drawings WOOD FENCE ALBERT NUNEZ & 9E 1306000 E 1306000 5O ALOK BHARGAVA & LUISA FRANZINI = 8210 GROVE ST. L.49789 F.0397 TAX ID 01041951 PLAT 54 3 JERRY A. McCOY & NAN E. McCOY 800 THAYER AVE. L.10985 F.0254 TAX ID 01047057 PLAT 54 SHEET TEMIM H. NUSRATY (TO BONIFANT STREET SHEET GROVE STREET GROVÉ STREET GROVE STREET 112+ STA. _DAVID S. SCHNEIDER _& RHONA CAMPBELL _749 THAYER AVE. L.26111 F.0396 TAX ID 01040307 PLAT 68 MIGUEL LUKE JONES & KELLY T. DOORDAN 750 THAYER AVE. L.46312 F.0253 TAX ID 01040706 PLAT 54 SETH R. GITTER & MARIE K. MAPES 8211 GROVE ST. L.43008 F.0091 TAX ID 01041370 PLAT 1136 JOHN M. GIPSON 8209 GROVE ST. L.06974 F.0013 TAX ID 01038862 PLAT 1136 & CONSTRUCTION -GROVE STREET EX-MH 14 N 482830 BEKELE DEBELE NEGEWO & MIMI A. GELETA 748 THAYER AVE. L.54985 F.0463 TAX ID 01040967 PLAT 54 MICHAEL BREWER & MARY TRUCHLY 747 THAYER AVE. L.22945 F.0075 TAX ID 01042215 PLAT 68 E 1306180 ALL TEMPORARY MEDIANS AND FLEXPOSTS SHALL BE REMOVED AND RETURNED TO PROP. DETECTABLE WARNING SURFACE PROP. SHARED USE PATH PAVEMENT DECK CONC PROP. CONCRETE PAVEMENT REMOVAL PS-04 PROP, STAMPED CONCRETE PROP. ROADWAY FINE MILL & OVERLAY DESIGNED BY: DHM II APP'D DATE DEPARTMENT OF TRANSPORTATION PROP. ROADWAY PAVEMENT DRAWN BY: DHM III DATE: MAY, 2024 DIVISION OF TRANSPORTATION ENGINEERING MONTGOMERY COUNTY, MARYLAND CHECKED BY: SJZ DATE: MAY, 2024 DRAWING NO.: DATE: RECOMMENDED FOR APPROVAL **Stantec** EAST SILVER SPRING Chief, Design Section Date NEIGHBORHOOD GREENWAY PROFESSIONAL CERTIFICATION:
IHEREBY CERTIFY THAT THESE DOCUMENTS WERE PREPARED
OR APPROVED BY ME, AND THAT I AM A DULY LICENSED
PROFESSIONAL ENGINEER UNDER THE LAWS OF THE STATE
OF MATYLAND.

EXPRATION DATE:

EXPRATION DATE: APPROVED ROADWAY PLAN Chief, Division of Transportation Engineering SCALE: 1"=20" SHEET_017_ of __113_

Attachment A: Corridor Engineering Drawings € ₌0 EASLY & LINDA CHANG & LINDA CHANG 802 EASLEY ST. L.61591 F.0279 TAX ID 01041005 PLAT 99 MARISOL C. HERNANDEZ, JORGE PEREZ, & DIANA E. PEREZ 803 EASLEY ST. L.16586 F.0263 TAX ID 01046508 PLAT 68 ₿ CONSTRUCTION TO BONIFANT STREET SHEET SHEET PR. TCE SEE EX. ROW STA. 1 GROVE STREET SEE NOTE 1—

GRASCHARLES W. KOINERASS
& LYNN F. KOINER

737 EASLEY ST. MULCH_ SEE NOTE 1 MATCH JASON EDWARD BROEHM & SONIA NIREN NAGDA 8409 GROVE ST. L.67213 F.0067 TAX ID 01043232 PLAT 68 ELAINE L. REILLY & F. BOYD REILLY 8411 GROVE ST. L.11012 F.0267 TAX ID 01047662 PLAT 68 RINA HAKIMIAN 8300 GROVE ST. L.56142 F.0084 TAX ID 01042556 PLAT 68 O4" CONC WALL DECK E 1306140 TAX ID 01039354 PLAT 68 NOTE: ALL TEMPORARY MEDIANS AND FLEXPOSTS SHALL BE REMOVED AND RETURNED TO MCDOT. PROP. DETECTABLE WARNING SURFACE PROP. SHARED USE PATH PAVEMENT PROP. CONCRETE PAVEMENT REMOVAL PS-05 PROP. STAMPED CONCRETE PROP. ROADWAY FINE MILL & OVERLAY DESIGNED BY: DHM III REVISION APP'D DATE DEPARTMENT OF TRANSPORTATION PROP. ROADWAY PAVEMENT DRAWN BY: DHM III DATE: MAY, 2024 DIVISION OF TRANSPORTATION ENGINEERING MONTGOMERY COUNTY, MARYLAND CHECKED BY: SJZ DATE: MAY, 2024 DRAWING NO.: DATE RECOMMENDED FOR APPROVAL **Stantec** EAST SILVER SPRING Chief, Design Section Date NEIGHBORHOOD GREENWAY APPROVED ROADWAY PLAN Chief, Division of Transportation Engineering SCALE: 1"=20" SHEET_018_ of __113

Attachment A: Corridor Engineering Drawings MICHAEL DORSEY & ALYSSA ROGERSON 821 BONIFANT ST. L.65950 F.0146 TAX ID 01042660 PLAT 301 TO FENTON STREET AMBER NEWSUM & LYNN SICADE 819 BONIFANT ST. L.61266 F.0411 TAX ID 01044921 PLAT 301 MEA QUEMI RHEE 815 BONIFANT ST-L.57638 F.0370 TAX ID 01044852 PLAT 301 BRANDY BLAIR 813 BONIFANT ST. L.64277 F.0452 TAX ID 01044668 PLAT 301 ALICE M. KOETHE 805 BONIFANT ST. L.62439 F.0439 TAX ID 01040843 PLAT 803 MARK WILLIAM WEISS & BARBARA LANCASTER WEISS 817 BONIFANT ST. BARRY KUNZ & DAWN NASER 803 BONIFANT ST. 1.32610 F.0365 TAX ID 01043744 PLAT 803 JOHN P. HASLINGER & ELIZABETH A. MEWSHAW 809 BONIFANT ST. L.48765 F.0199 TAX 1D 01041858 1.58590 F.0466 BONIFANT STREET ID 01044841 +50 45+00 Q, GRASS CONSTRUCTION -DEBRA J. LIPSON & ALFRED SUESCUM 818 BONIFANT ST. L.26464 F.0561 TAX ID 02890504 PLAT 17942 Jects/2026213122/700 CADD/700 Sheet\pHD-P006_ESSNG CONSTRUCTION BONIFANT STREET RHODA SCHULZINGER & ROCHELLE F. GRANAT 705 HANKIN ST. L.51147 F.0253 TAX ID 2890526 PLAT 17942 SHANNON SCOTT 707 HANKIN ST. L.29063 F.0206 TAX ID 2890515 PLAT 17942 JEROME F. GROSS
JOYCE MARIE GROSS
8413 GROVE ST.
L.09167 F.0514
TAX ID 01041734
RLAT 68
-SEE NOTE 1 303 PASTER FAMILY TRUS 703 HANKIN ST. L.56012 F.0407 TAX 10 2890537 PLAT 17942 PROP. DETECTABLE WARNING SURFACE PROP. SHARED USE PATH PAVEMENT ALL TEMPORARY MEDIANS AND FLEXPOSTS PROP. CONCRETE SHALL BE REMOVED AND RETURNED TO PS-06 PROP, STAMPED CONCRETE PROP. ROADWAY FINE MILL & OVERLAY DESIGNED BY: DHM II REVISION APP'D DATE DEPARTMENT OF TRANSPORTATION PROP. ROADWAY PAVEMENT DRAWN BY: DHM III DATE: MAY, 2024 DIVISION OF TRANSPORTATION ENGINEERING MONTGOMERY COUNTY, MARYLAND CHECKED BY: SJZ DATE: MAY, 2024 DRAWING NO.: DATE RECOMMENDED FOR APPROVAL Stantec EAST SILVER SPRING Chief, Design Section NEIGHBORHOOD GREENWAY PROFESSIONAL CERTIFICATION:
IHEREBY CERTIFY THAT THESE DOCUMENTS WERE PREPARED
OR APPROVED BY ME, AND THAT I AM A DULY LICENSED
PROFESSIONAL ENGINEER UNDER THE LAWS OF THE STATE
OF MATYLAND.

EXPRATION DATE:

EXPRATION DATE: APPROVED ROADWAY PLAN Chief, Division of Transportation Engineering SCALE: 1"=20" SHEET_019_ of __113_

Attachment A: Corridor Engineering Drawings NOAM C. UNGER & CAROLINE P. WADHAMS 8504 HOUSTON ST. L.34789 F.0358 TAX ID 01039571 PLAT 369 - SEE SHEET PS-06 EX. ROW PETER J. CARNES & R.D. CARNES 8400 CEDAR ST. L.11606 F.0674 TAX ID 01045151 PLAT 803 MARIA MCFARLAND & MARTA MCFARLAND &
PHELIM BRUCE JOHN KYNE
8402 CEDAR ST.
L-62156 F-0144
TAX ID 01048074
PLAT 803 THE MARYLAND NATIONAL CAPITAL
PARK & PLANNING COMMISSION
HOUSTON STREET
L.9913 F.0335
TAX ID 01731912
PLAT 68 BONIFANT STREET **₽** CONSTRUCTION SHEET CEDAR STREET CEDAR STREET 8 6 DWAN S. JENKIN & DANIEL JENKIN 714 BONIFANT ST. L.33018 F.0186 TAX ID 01028101 PLAT 504 ANDREW GLOVER & MARY CLARE GLOVER 8401 CEDAR ST. L.62624 F.0258 TAX ID 01047172 PLAT 350 MARK CAMILLO &
MAGDALENA CAMILLO
8403 CEDAR ST.
L.46121 F.0288
TAX ID 01043094
PLAT 330 PROP. DETECTABLE WARNING SURFACE PROP. SHARED USE PATH PAVEMENT PROP. CONCRETE PAVEMENT REMOVAL PS-07 PROP. STAMPED CONCRETE PROP. ROADWAY FINE MILL & OVERLAY DESIGNED BY: DHM III NO. REVISION APP'D DATE DEPARTMENT OF TRANSPORTATION PROP. ROADWAY PAVEMENT DRAWN BY: DHM III DATE: MAY, 2024 DIVISION OF TRANSPORTATION ENGINEERING MONTGOMERY COUNTY, MARYLAND CHECKED BY: SJZ DATE: MAY, 2024 DRAWING NO.: DATE RECOMMENDED FOR APPROVAL **Stantec** EAST SILVER SPRING Chief, Design Section NEIGHBORHOOD GREENWAY

APPROVED

Chief, Division of Transportation Engineering ROADWAY PLAN

SCALE: 1"=20"

SHEET_020_ of __II3

Attachment A: Corridor Engineering Drawings WILLIAM J. SEARS & SARAH M. ROSE 8410 CEDAR ST. L.56355 F.0126— TAX ID 01044681 PLAT 301 RONALD BOUCHER & LINDA-LOMBARDI-8408 CEDAR ST. L.12924 F.0016 TAX ID 01047343 FLAT 301 TVAN CHARNER & K. CHARNER 8406 CEDAR ST. L.4795 F.0095 TAX ID 01039970 PLAT 803 19 BRIAN C. JOHNSTON CONSTRUCTED BY TO BONIFANT STREET CEDAR STREET ď CEDAR STREET STA LIMIT OF WORK CIP 0501532 ESSN GREENWAY EX-MH 18 STA. 55 + 96 - B CONSTRUCTION DAVID M. MCHERSON REVOCABLE TRUST & GAIL LOUISE GUGEL REVOCABLE TRUST 8407 CEDAR ST. L. 48029 F.0059 TAX ID 01045947 PLAT 330 ISAAC K. KUNNYRICKAL 712/WAYNE AVE. L.54379 F.0132 TAX ID 01089742 PLAT 380 STEVEN H. ROSENBAUM 8409 CEDAR ST. L.38962 F.0353 TAX ID 01038953 PLAT 330 SOON WHA KAO 8405 CEDAR ST. L.43306 F.0147 TAX ID 01041368-PLAT 330 PROP. DETECTABLE WARNING SURFACE PROP. SHARED USE PATH PAVEMENT PROP. CONCRETE PAVEMENT REMOVAL PROP, STAMPED CONCRETE PROP. ROADWAY FINE MILL & OVERLAY DEPARTMENT OF TRANSPORTATION PROP. ROADWAY PAVEMENT DRAWN BY: DHM III DATE: MAY, 2024 DIVISION OF TRANSPORTATION ENGINEERING MONTGOMERY COUNTY, MARYLAND CHECKED BY: SJZ DATE: MAY, 2024 DRAWING NO.: DATE RECOMMENDED FOR APPROVAL **Stantec** EAST SILVER SPRING Chief, Design Section NEIGHBORHOOD GREENWAY APPROVED ROADWAY PLAN Chief, Division of Transportation Engineering SHEET_021_ of_ II3_ SCALE: 1"=20"

Attachment A: Corridor Engineering Drawings STREET | E 1306500 E 1306500 EASLEY JAMES T. HUTCHINS & SHELLEY HUTCHINS 8 402 HOUSTON ST. L.19613 F.0285 TAX ID 01041027 PLAT 1331 BRIAN W. KAPLAN 8404 HOUSTON ST. L.66483 F.0141 TAX ID 01039560 PLAT 1331 PS SHEET THINH V. NGUYEN & BEHAI T. DANG 731 THAYER AVE. L.7894 F.0657 TAX ID 01042385 PLAT 68 DOUGLAS O. CHASE & INGRID CHASE 8308 HOUSTON ST. 1.20607 F.0267 TAX ID 01045993 PLAT 68 PC 203+67.91 CHAMBERS IAYER AVE. 26 F.0268 01040648 AT 54 RETAINING WALL 204+00 IA CALLIS ON CALLIS AYER AVE. 27 F.0122 01042410 AT 54 HOUSTON STREET HOUSTON STREET THE MARY GIPE SPRAGUE LIVING TRUST & MARY G. SPRAGUE TRUSTEE TO EASLEY ST. L.65816 F.0009 TAX ID 01039593 PLAT 68 € CONSTRUCTION HOUSTON STREET B CONSTRUCTION RUTH A. STOLTZFUS 8303 HOUSTON ST. L.16995 F.0051 TAX ID 01045787 PLAT 68 E 1306650 MARYLAND NATIONAL CAPITAL PARK & PLANNING COMMISSION HOUSTON STREET L.9913 F.0335 TAX ID 01731912 PLAT 68 PROP. DETECTABLE WARNING SURFACE PROP. SHARED USE PATH PAVEMENT PROP. CONCRETE PAVEMENT REMOVAL PS-09 PROP. STAMPED CONCRETE PROP. ROADWAY FINE MILL & OVERLAY DESIGNED BY: DHM II APP'D DATE DEPARTMENT OF TRANSPORTATION PROP. ROADWAY PAVEMENT DRAWN BY: DHM III DATE: MAY, 2024 DIVISION OF TRANSPORTATION ENGINEERING MONTGOMERY COUNTY, MARYLAND CHECKED BY: SJZ DATE: MAY, 2024 DRAWING NO.: DATE RECOMMENDED FOR APPROVAL **Stantec** EAST SILVER SPRING Chief, Design Section Date NEIGHBORHOOD GREENWAY APPROVED ROADWAY PLAN Chief, Division of Transportation Engineering SCALE: 1"=20" SHEET_022_ of ______113_

Attachment A: Corridor Engineering Drawings | E 1306450 E 13064509 BROOKE C. DERENZIS & JOSEPH J. MAURO III 8406 HOUSTON ST. L.54890 F.0205 TAX ID 01045606 PLAT 1331 1 8 KATHLEEN W. WARRINER & ROBERT C. WARRINER 8502 HOUSTON ST. L.22282 F10416 TAX ID 01042204 PLAT 369 DANIEL FARROW 8500 HOUSTON ST. L.49329 F.0131 TAX ID 01039582 / PLAT 369 TEPHEN P. MUNRO & LANE C. TAPLEY 8410 HOUSTON ST. L.8179 F.0727 SRINIVAS NANDKUMAR & KARIN CHAMBLESS 700 HANKIN ST. L.18718 F.0650 TAX ID 01040227 PLAT 3745 & LANE C. TAPLEY 8408 HOUSTON ST. L.50457 F.0146 TAX ID 02724568 PLAT 16603 PS-07 PLAT 16603 TO SLIGO AVENUE SHEET + 50 206+00 HOUSTON STREET HOUSTON STREET STA. MARYLAND NATIONAL CAPITAL PARK & PLANNING COMMISSION HOUSTON STREET L.9913 F.0335 TAX ID 01731912 PLAT 68 € CONSTRUCTION HOUSTON STREET HOUSTON STREET MARYLAND NATIONAL CAPITAL PARK & PLANNING COMMISSION HOUSTON STREET L.9913 F.0335 TAX ID 01731912 PLAT 68 E 1306650 PROP. DETECTABLE WARNING SURFACE PROP. SHARED USE PATH PAVEMENT PROP. CONCRETE PS-I0 PROP. STAMPED CONCRETE PROP. ROADWAY FINE MILL & OVERLAY DESIGNED BY: DHM III REVISION APP'D DATE NO. DEPARTMENT OF TRANSPORTATION PROP. ROADWAY PAVEMENT DRAWN BY: DHM III DATE: MAY, 2024 DIVISION OF TRANSPORTATION ENGINEERING MONTGOMERY COUNTY, MARYLAND CHECKED BY: SJZ DATE: MAY, 2024 DRAWING NO.: DATE: RECOMMENDED FOR APPROVAL **Stantec** EAST SILVER SPRING Date Chief, Design Section NEIGHBORHOOD GREENWAY APPROVED ROADWAY PLAN Chief, Division of Transportation Engineering SHEET_023_ of_ II3_ SCALE: 1"=20"

	DRAINAGE STRUCTURE SCHEDULES						
STRUCTURE	STATION	OFFSET	TYPE	TOP ELEV.	INV. OUT	STANDARD	REMARKS
MH-6	11+66,93	54.I5' RT	MCDOT TYPE A MANHOLE	338.00	331.23	MC-510.01	60' MANHOLE
1-12	12+24.21	45.33' RT	MCDOT TYPE B INLET	337.95	331.60	MC-502.0I	10' THROAT OPENING
1-9	22+73.09	16.00' LT	MCDOT TYPE B INLET	1-9	340.11	MC-502.01	10' THROAT OPENING
MH-3	22+78,77	4.22' LT	MCDOT TYPE A MANHOLE	MH-3	335.36	MC-510.01	48" MANHOLE
1-10	23+15.87	16.00' RT	MCDOT TYPE B INLET	1-10	340.20	MC-502.0I	10' THROAT OPENING
MH-4	23+19.22	4.4I' LT	MCDOT TYPE A MANHOLE	345.25	331.00	MC-510.01	48" MANHOLE
MH-5	100+04.60	7.63' RT	MCDOT TYPE A MANHOLE	344.50	330.22	MC-510.01	48" MANHOLE
1-14	103+05.46	II.90' LT	MCDOT TYPE B INLET	1-14	325.10	MC-502.01	10' THROAT OPENING
1-15	105+77.69	38.02' LT	MCDOT TYPE B INLET	1-15	308.50	MC-502.01	15' THROAT OPENING
1-16	106+84.59	8.32' LT	MCDOT TYPE B INLET	1-16	304.50	MC-502.0I	15' THROAT OPENING
1-1	108+63.62	8.33' LT	MCDOT TYPE A INLET	308.31	303.15	MC-501.01	20' THROAT OPENING
1-4	110+65.31	87.73' RT	MCDOT TYPE A INLET	1-4	309.65	MC-501.01	5' THROAT OPENING
MH-I	110+96.33	84.91' RT	MCDOT TYPE A MANHOLE	MH-I	309.40	MC-510.01	48" MANHOLE
I-5	110+94.87	43.82' RT	MCDOT TYPE B INLET	1-5	308.31	MC-502.0I	10' THROAT OPENING
1-2	110+99.54	43.66' LT	MCDOT TYPE B INLET- MODIFIED	313.18	309.42	MODIFIED MC-502.01	20' THROAT OPENING
1-3	111+23.48	8.33' LT	MCDOT TYPE A INLET	313.12	309.66	MC-501.01	10' THROAT OPENING
1-13	113+24.87	8.33' LT	MCDOT TYPE B INLET	321.74	316.36	MC-502.01	10' THROAT OPENING
1-6	55+43.76	12.00' RT	MCDOT TYPE B INLET	1-6	I-6	MC-502.0I	15' THROAT OPENING
I-8	206+67.13	9.00' LT	PRECAST OR CIP COS OPENING	325.70	325.00	MD-374.68	10' THROAT OPENING
1-7	206+69.26	21.09' LT	MCDOT TYPE E INLET	324.96	322.29	MC-504.0I	E YARD INLET
MH-7	206+66.8	13.9' RT	MCDOT TYPE A MANHOLE	325.06	322.04	MC-510.01	60' MANHOLE
MH-8	113+25.88	0.31' RT	MCDOT TYPE A MANHOLE	319.06	310,25	MC-510.01	72" MANHOLE

GENERAL NOTES

I. STATION AND OFFSETS FOR MANHOLES IS GIVEN TO THE GEOMETRIC CENTER OF THE MANHOLE AND THE TOP ELEVATION IS GIVEN TO THE TOP OF MANHOLE COVER.

2. STATIONS FOR COG INLETS IS GIVEN TO THE GEOMETRIC CENTER OF THE BASE UNIT STRUCTURE, THE OFFSET IS GIVEN TO THE FACE OF CURB AT CENTER OF TROUGH AND THE TOP ELEVATION IS GIVEN TO THE TOP OF CURB.

3.STATION AND OFFSETS FOR TYPE 'S' INLETS AND YARD INLETS ARE GIVEN TO THE GEOMETRIC CENTER OF THE INLET AND THE TOP ELEVATION IS GIVEN TO THE TOP OF GRATE.

4.INLET I-2 TO HAVE MODIFIED BASE UNIT THAT WILL BE BUILT OVER EXISTING PIPE. IT WILL EXTEND 8' TO THE BACK.

5.CONTRACTOR TO VERIFY ALL EXISTING STORM DRAIN INVERTS PRIOR TO ORDERING AND FABRICATION ALL PROPOSED INLETS AND MANHOLES.

PIPE SCHEDULES						
UPSTREAM STRUCTURE	DOWNSTREAM STRUCTURE	SIZE	TYPE	LENGTH (FT)		
I-12 I-9 MH-3 I-10 MH-4 MH-5 I-15 I-16 I-4	MH-6 MH-3 MH-4 MH-4 MH-5 EX-MH-12 EX-MH-11 EX-MH-1 MH-1	15" 18" 15" 18" 18" 15" 15"	RCP, CL IV RCP, CL IV	53 II 36 20 46 299 39 IO 28		
I-13 I-6	MH-8 EX-MH-18	15" 15"	RCP, CL IV RCP, CL IV	6 40		
I-7	MH-7	14" BY 23"	HERCP, CL IV	30		

REMOVE EXIS	TING DRAINAG	E STRUCTURE	SCHEDULE **
STRUCTURE	STATION	OFFSET	TYPE
EX-II EX-I3	108+59.28	14.2' LT 13.73' LT	INLET INLET
EX-16	55+60.96	21.27' RT	INLET

**REMOVE AND DISPOSE OF ALL EXISTING STORM DRAIN STRUCTURES THAT ARE IN CONFLICT WITH PROPOSED UTILITIES AND PROPOSED CONSTRUCTION TO BE PAID FOR AS REMOVAL OF EXISTING MASONRY - CAT. CODE 210030.

BEFORE BEGINNING CONSTRUCTION CONTACT

"MISS UTILITY"

AT

I-800-257-7777

AT LEAST 48 HOURS
PHOR TO EXCAVATION

REVISION BY APPD DATE DESIGNED BY: SMH DATE: MAY, 2024
DRAWN BY: SMH DATE: MAY, 2024
CHECKED BY: SJZ DATE: MAY, 2024
DRAWNG NO.: DATE: MAY, 2024
DRAWNG NO.: DATE: MAY, 2024
MONTGOMERY COUNTY, MARYLAND

Stantec

Gleneagles Court, Suite 300 Imore, MD 21286

	Blcycle and Pedestrian Priority Are	88
- 1-		

RECOMMENDED FOR APPROVAL

Chlef, Design Section

APPROVED

Chlef,
Division of Transportation Engineering

Control Transportation Engineering

EAST SILVER SPRING NEIGHBORHOOD GREENWAY DRAINAGE SCHEDULES

DD-01


SCALE: NONE SHEET 024 of 113

5/22/2024

Attachment A: Corridor Engineering Drawings DA-01 DA-08 DA-02 DA-03 DA-10 DA-05 DA-12 DRAWN BY: DHM III DATE: MAY, 2024 DIVISION OF TRANSPORTATION ENGINEERING MONTGOMERY COUNTY, MARYLAND CHECKED BY: SJZ DATE: MAY, 2024 DRAWING NO.: RECOMMENDED FOR APPROVAL **Stantec** EAST SILVER SPRING NEIGHBORHOOD GREENWAY DRAINAGE AREA MAP KEY Chief, Division of Transportation Engineering SHEET_025_ of __II3


Attachment A: Corridor Engineering Drawings LEGEND LAND USE, OPEN SPACE HYDROLOGIC SOIL BOUNDARY EXISTING DRAINAGE AREA SUMMARY TABLE 4.84 5.06 6.34 0.81 0.46 0.17 0.48 0.06 0.62 0.10 E 1305410 E 13054101 FENTON STREET SEE WOODBURY DRIVE DA-OI DEPARTMENT OF TRANSPORTATION MATCH LINE - SEE SHEET DA-07 DRAWN BY: SMH DATE: MAY, 2024 DIVISION OF TRANSPORTATION ENGINEERING MONTGOMERY COUNTY, MARYLAND CHECKED BY: SJZ DATE: MAY, 2024 DRAWING NO.: RECOMMENDED FOR APPROVAL EAST SILVER SPRING **Stantec** NEIGHBORHOOD GREENWAY Date Chief, Design Section EXISTING CONDITIONS APPROVED DRAINAGE AREA MAP Chief, Division of Transportation Engineering SHEET 026 of 026 SCALE: 1"=40"


Attachment A: Corridor Engineering Drawings LEGEND FENTON STREET DRAINAGE AREA LAND USE, IMPERMOUS HYDROLOGIC SOIL BOUNDARY HYDROLOGIC SOIL TYPE EXISTING DRAINAGE AREA SUMMARPY TABLE
POI AREA (KOFE)
1 24.00
2 4.06
3 6.06
4 6.34
5 0.46
6 0.46
7 0.17
8 0.48
9 0.06
10 0.62
11 0.10 DA-03 DA-07 SHEET DA-01 AND | E 1305830 MATCH SEE MATCH LINE EX-MH 13 EX-MH EX-MH GROVE STREET 14 DA-02 DESIGNED BY: SMI APP'D DATE DEPARTMENT OF TRANSPORTATION DRAWN BY: SMH DATE: MAY, 2024 DIVISION OF TRANSPORTATION ENGINEERING MONTGOMERY COUNTY, MARYLAND MATCH LINE - SEE SHEET DA-06 CHECKED BY: SJZ DATE: MAY, 2024 DRAWING NO.: RECOMMENDED FOR APPROVAL EAST SILVER SPRING Stantec NEIGHBORHOOD GREENWAY Date Chief, Design Section EXISTING CONDITIONS APPROVED DRAINAGE AREA MAP Chief, Division of Transportation Engineering SHEET_027_ of ______113_ SCALE: 1"=40"

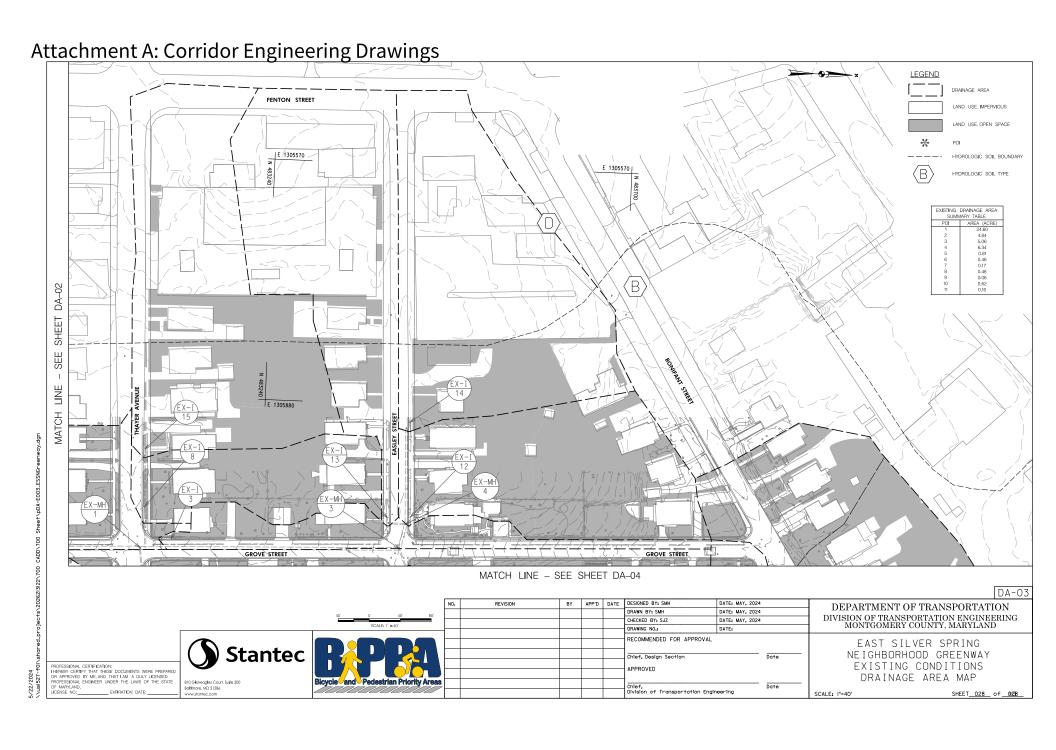


Attachment A: Corridor Engineering Drawings MATCH LINE - SEE SHEET DA-03 DRAINAGE AREA LAND USE IMPERVIOUS LAND USE, OPEN SPACE * HYDROLOGIC SOIL BOUNDARY E 1306200 | HYDROLOGIC SOIL TYPE AND DA-02 EXISTING DRAINAGE AREA SUMMARY TABLE THAYER AVENUE 4.84 5.06 6.34 0.81 0.46 0.17 0.48 0.06 0.62 0.10 SHEET SHEET SEE SEE MATCH E 1306540 HOUSTON STREET

Jects\2026213122\700 CADD\700 Sheet\pDA-E004_ESSNGr DA-04 DESIGNED BY: SMH DATE: MAY, 2024 APP'D DATE DEPARTMENT OF TRANSPORTATION DRAWN BY: SMH DATE: MAY, 2024 DIVISION OF TRANSPORTATION ENGINEERING MONTGOMERY COUNTY, MARYLAND CHECKED BY: SJZ DATE: MAY, 2024 DATE DRAWING NO.: RECOMMENDED FOR APPROVAL EAST SILVER SPRING **Stantec** NEIGHBORHOOD GREENWAY Chief, Design Section PROFESSIONAL CERTIFICATION:
HEBERY CERTIFY THAT THESE DOCUMENTS WERE PREPARED
OR APPROVED BY ME, AND THAT I AM A DULY LICENSED
PROFESSIONAL ENGINEER LINDER THE LAWS OF THE STATE
OF MARTILAND.
LICENSE NO. DOPPRATION DATE: EXISTING CONDITIONS APPROVED DRAINAGE AREA MAP Chief, Division of Transportation Engineering SHEET_029_ of __II3 SCALE: 1"=40"

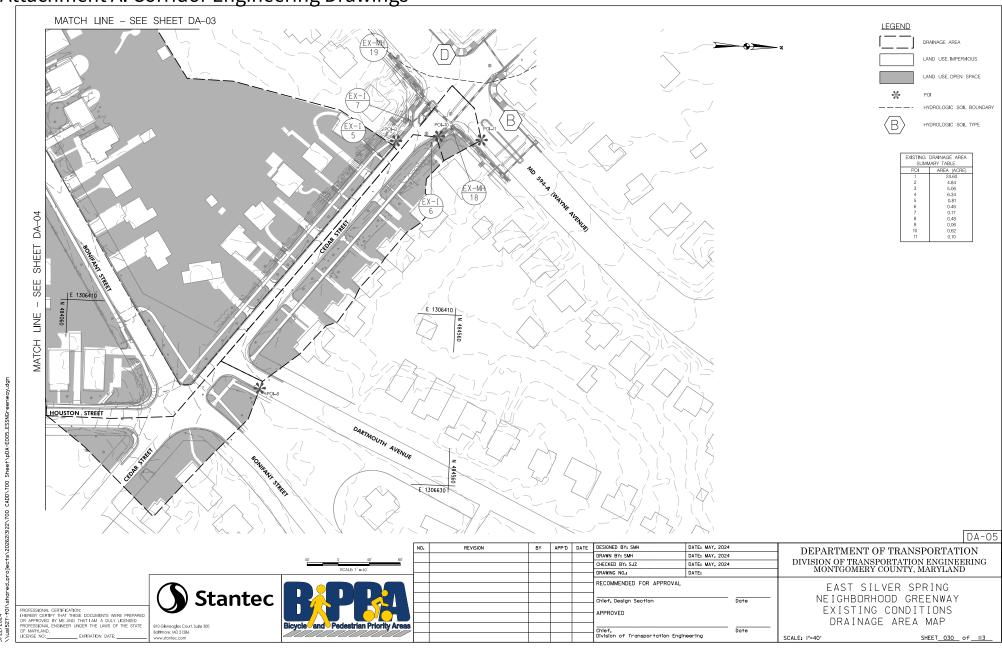


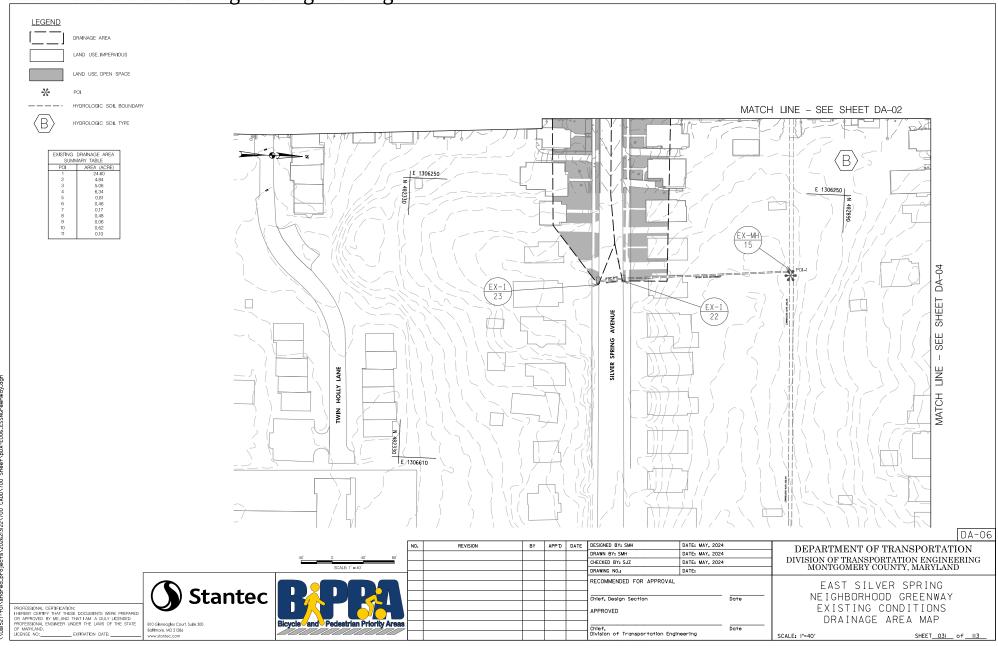


Attachment A: Corridor Engineering Drawings <u>LEGEND</u> DRAINAGE AREA LAND USE IMPERVIOUS MATCH LINE - SEE SHEET DA-01 HYDROLOGIC SOIL TYPE EXISTING DRAINAGE AREA SUMMARY TABLE DA-02 SHEET SEE MATCH LINE GROVE STREET E 1306260 E 1306260 BOSTON AVENUE DA-07 REVISION APP'D DATE DESIGNED BY: SMI DEPARTMENT OF TRANSPORTATION DRAWN BY: SMH DATE: MAY, 2024 DIVISION OF TRANSPORTATION ENGINEERING MONTGOMERY COUNTY, MARYLAND CHECKED BY: SJZ DATE: MAY, 2024 DRAWING NO.: RECOMMENDED FOR APPROVAL EAST SILVER SPRING **Stantec** NEIGHBORHOOD GREENWAY Date Chief, Design Section EXISTING CONDITIONS DRAINAGE AREA MAP Chief, Division of Transportation Engineering SHEET_032_ of __II3_ SCALE: 1"=40"

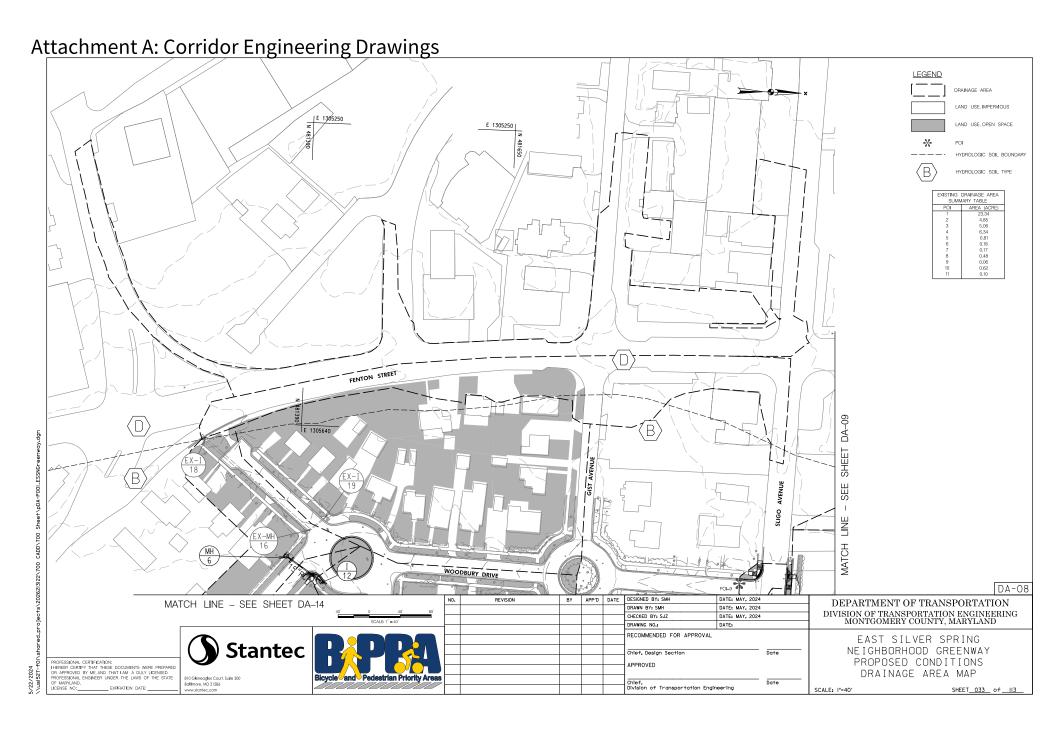


Attachment A: Corridor Engineering Drawings LEGEND FENTON STREET DRAINAGE AREA LAND USE, IMPERMOUS E 1305590 E 1305590 I HYDROLOGIC SOIL BOUNDARY HYDROLOGIC SOIL TYPE EXISTING DRAINAGE AREA SUMMARY TABLE DA-10 DA-14 4.85 5.06 6.34 0.81 0.18 0.17 0.48 0.06 0.62 0.10 AND SHEET DA-01 SEE MATCH LINE E 1305940 EX-MH 13 GROVE STREET 14 DA-09 DESIGNED BY: SMI APP'D DATE DEPARTMENT OF TRANSPORTATION DRAWN BY: SMH DATE: MAY, 2024 DIVISION OF TRANSPORTATION ENGINEERING MONTGOMERY COUNTY, MARYLAND MATCH LINE - SEE SHEET DA-13 CHECKED BY: SJZ DATE: MAY, 2024 DRAWING NO.: RECOMMENDED FOR APPROVAL EAST SILVER SPRING Stantec NEIGHBORHOOD GREENWAY Date Chief, Design Section PROPOSED CONDITIONS APPROVED DRAINAGE AREA MAP Chief, Division of Transportation Engineering SHEET_034_ of __II3_ SCALE: 1"=40"

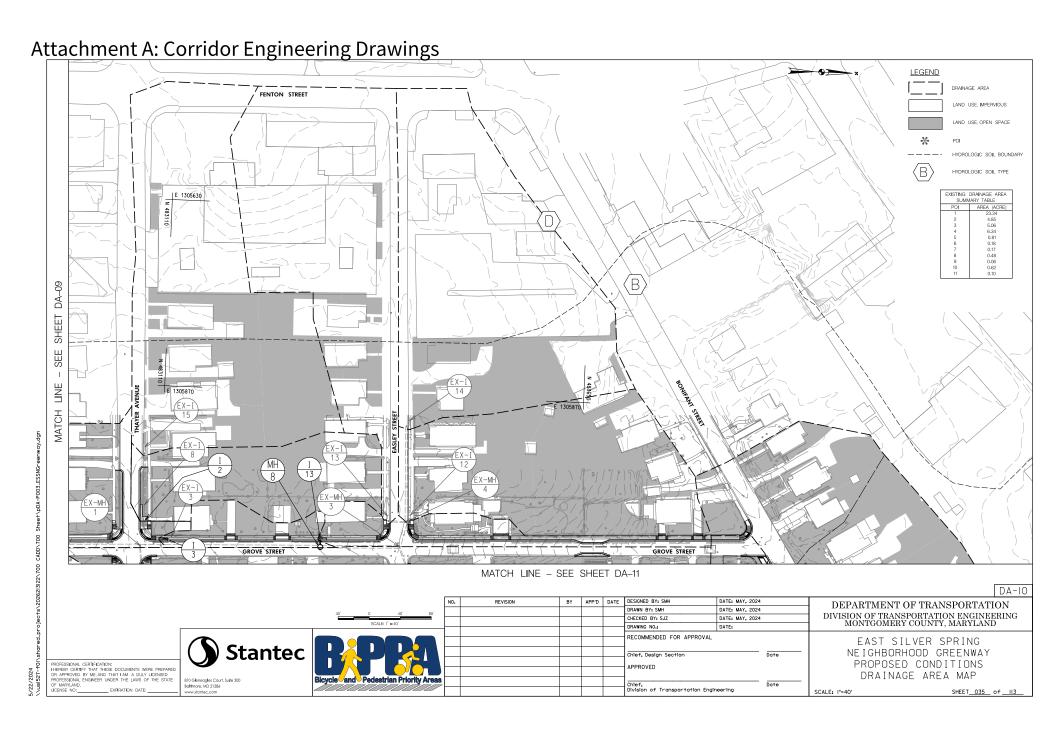


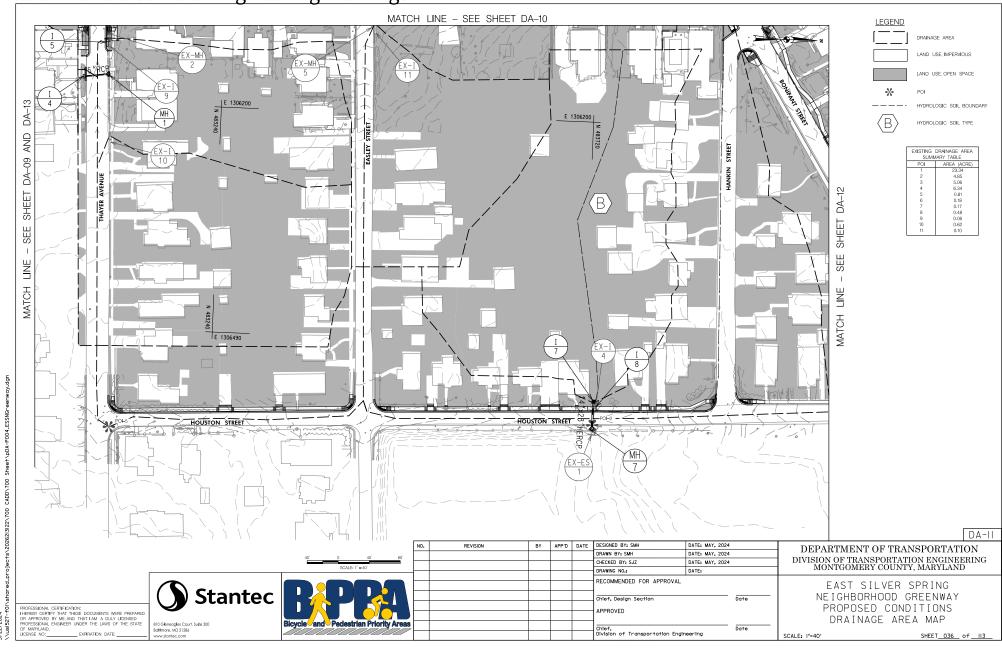

5/22/2024

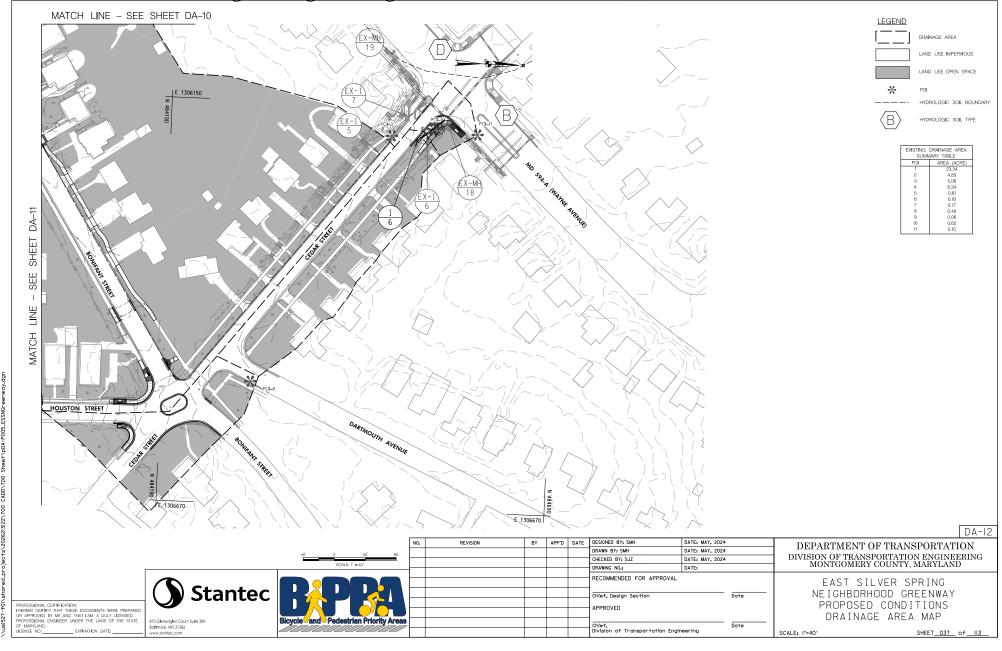


5/22/2024

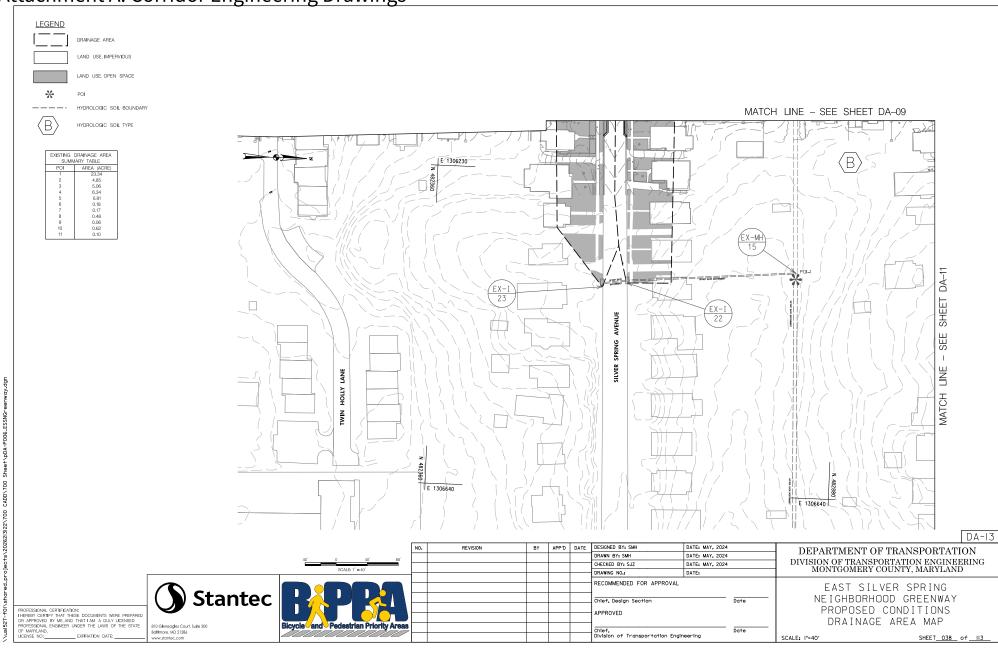

Attachment A: Corridor Engineering Drawings <u>LEGEND</u> DRAINAGE AREA LAND USE, IMPERVIOUS MATCH LINE - SEE SHEET DA-08 HYDROLOGIC SOIL TYPE EXISTING DRAINAGE AREA SUMMARY TABLE POI AREA (ACRE) 23.34 4.85 5.06 6.34 0.81 0.18 0.17 0.48 0.06 0.62 0.10 DA-09 E 1305960 SHEET SEE MATCH LINE E 1306260 E 1306260 BOSTON AVENUE DA-14 REVISION APP'D DATE DESIGNED BY: SMI DEPARTMENT OF TRANSPORTATION DRAWN BY: SMH DATE: MAY, 2024 DIVISION OF TRANSPORTATION ENGINEERING MONTGOMERY COUNTY, MARYLAND CHECKED BY: SJZ DATE: MAY, 2024 DRAWING NO.: RECOMMENDED FOR APPROVAL EAST SILVER SPRING **Stantec** NEIGHBORHOOD GREENWAY Chief, Design Section PROFESSIONAL CERTIFICATION:
HEBERY CERTIFY THAT THESE DOCUMENTS WERE PREPARED
OR APPROVED BY ME, AND THAT I AM A DULY LICENSED
PROFESSIONAL ENGINEER LINDER THE LAWS OF THE STATE
OF MARTILAND.
LICENSE NO. DOPPRATION DATE: PROPOSED CONDITIONS APPROVED DRAINAGE AREA MAP Chief, Division of Transportation Engineering SHEET_039_ of__II3 SCALE: 1"=40"


Attachment A: Corridor Engineering Drawings SW-01° SW-02 SW-05_ SW-03 SW-08 SW-07 SW-10 DRAWN BY: DHM III DATE: MAY, 2024 DIVISION OF TRANSPORTATION ENGINEERING MONTGOMERY COUNTY, MARYLAND CHECKED BY: SJZ DATE: MAY, 2024 DRAWING NO.: RECOMMENDED FOR APPROVAL **Stantec** EAST SILVER SPRING NEIGHBORHOOD GREENWAY STORMWATER PLAN KEY Chief, Division of Transportation Engineering SCALE: 1"=200" SHEET_040_ of _______113_

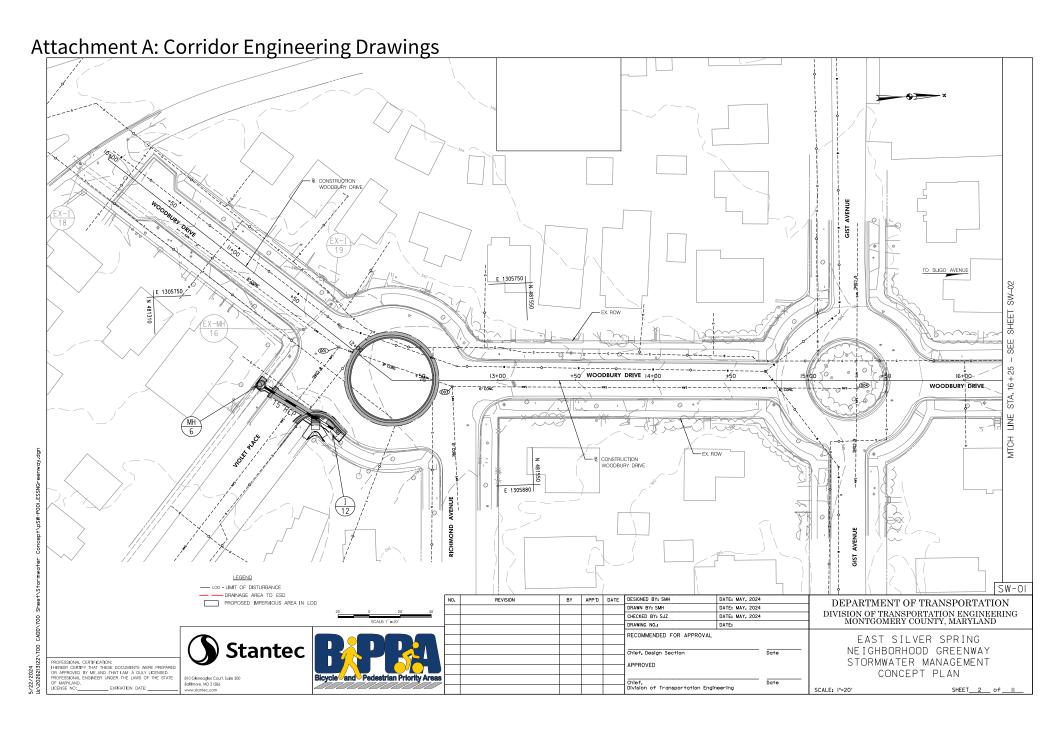

Attachment A: Corridor Engineering Drawings MATCH LINE STA. 101+00 - SEE SHEET SW-03 TO FENTON STREET 22+00 SLIGO AVENUE SLIGO AVENUE SLIGO AVENUE CONSTRUCTION € CONSTRUCTION WOODBURY DRIVE MATCH LINE STA. 16+25 - SEE SHEET SW-01 LEGEND --- LOD - LIMIT OF DISTURBANCE DESIGNED BY: SMH APP'D DATE DEPARTMENT OF TRANSPORTATION PROPOSED IMPERVIOUS AREA IN LOD DRAWN BY: SMH DATE: MAY, 2024 DIVISION OF TRANSPORTATION ENGINEERING MONTGOMERY COUNTY, MARYLAND CHECKED BY: SJZ DATE: MAY, 2024 DRAWING NO.: DATE: RECOMMENDED FOR APPROVAL EAST SILVER SPRING **Stantec** NEIGHBORHOOD GREENWAY Chief, Design Section PROFESSIONAL CERTIFICATION:
IHEREBY CERTIFY THAT THESE DOCUMENTS WERE PREPARED
OR APPROVED BY ME AND THAT I AM A DULY LICENSED
PROFESSIONAL ENGINEER UNDER THE LAWS OF THE STATE
OF MAYILAND.

EXPRATION DATE:

EXPRATION DATE: STORMWATER MANAGEMENT APPROVED CONCEPT PLAN Chief, Division of Transportation Engineering SCALE: 1"=20"

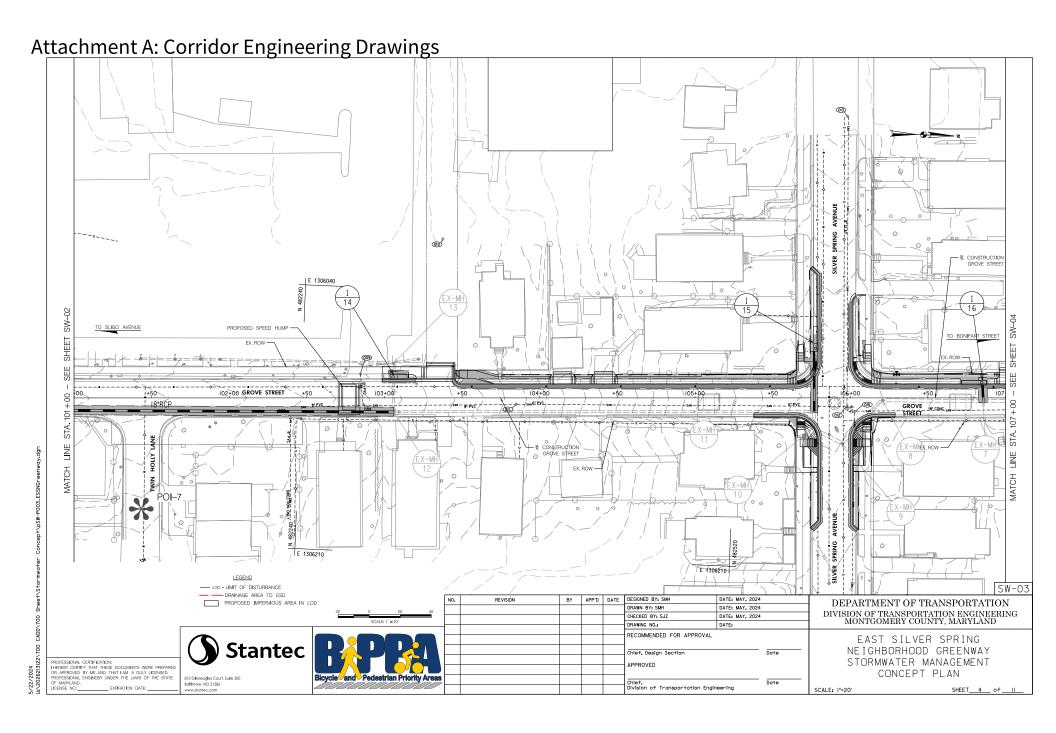


Attachment A: Corridor Engineering Drawings E 1306000 SHEET - & CONSTRUCTION GROVE STREET GROVE STREET GROVE STREET STA. & CONSTRUCTION GROVE STREET E 1306180 LEGEND --- LOD - LIMIT OF DISTURBANCE SW-04 PROPOSED IMPERVIOUS AREA IN LOD DEPARTMENT OF TRANSPORTATION DRAWN BY: SMH DATE: MAY, 2024 DIVISION OF TRANSPORTATION ENGINEERING MONTGOMERY COUNTY, MARYLAND CHECKED BY: SJZ DATE: MAY, 2024 DRAWING NO.: RECOMMENDED FOR APPROVAL EAST SILVER SPRING **Stantec** NEIGHBORHOOD GREENWAY Chief, Design Section PROFESSIONAL CERTIFICATION:
INFERENC CERTIFY THAT THESE DOCUMENTS WERE PREPARED
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PROFESSIONAL RENINSEER UNDER THE LAWS OF THE STATE
OF MARYLAND.
LICENSE NO. DAPPRATION DATE: STORMWATER MANAGEMENT CONCEPT PLAN Chief, Division of Transportation Engineering SCALE: 1"=20"

Attachment A: Corridor Engineering Drawings SW-04 STA. © GROVE STREET E 1306110 1306110 LEGEND --- LOD - LIMIT OF DISTURBANCE SW-05 --- DRAINAGE AREA TO ESD APP'D DATE DESIGNED BY: SMH PROPOSED IMPERVIOUS AREA IN LOD DEPARTMENT OF TRANSPORTATION DRAWN BY: SMH DATE: MAY, 2024 DIVISION OF TRANSPORTATION ENGINEERING MONTGOMERY COUNTY, MARYLAND CHECKED BY: SJZ DATE: MAY, 2024 DRAWING NO.: RECOMMENDED FOR APPROVAL EAST SILVER SPRING **Stantec** NEIGHBORHOOD GREENWAY Chief, Design Section STORMWATER MANAGEMENT APPROVED CONCEPT PLAN Chief, Division of Transportation Engineering SCALE: 1"=20"

Attachment A: Corridor Engineering Drawings TO FENTON STREET CONSTRUCTION BONIFANT STREE BONIFANT STREET 6 GONSTRUCTION -CONSTRUCTION BONIFANT STREET LEGEND --- LOD - LIMIT OF DISTURBANCE REVISION DESIGNED BY: SMH PROPOSED IMPERVIOUS AREA IN LOD DEPARTMENT OF TRANSPORTATION DRAWN BY: SMH DATE: MAY, 2024 DIVISION OF TRANSPORTATION ENGINEERING MONTGOMERY COUNTY, MARYLAND CHECKED BY: SJZ DATE: MAY, 2024 DRAWING NO.: RECOMMENDED FOR APPROVAL EAST SILVER SPRING **Stantec** NEIGHBORHOOD GREENWAY Chief, Design Section PROFESSIONAL CERTIFICATION:
INFRIESY CERTIFY THAT THESE DOCUMENTS WERE PREPARED
OR APPROVED BY ME, AND THAT THAT A DLLY LICENSED
PROFESSIONAL BROINGER UNDER THE LAWS OF THE STATE
OF MAPPLAND.
LICENSE NO:
EXPRATION DATE: STORMWATER MANAGEMENT CONCEPT PLAN Chief, Division of Transportation Engineering SCALE: 1"=20"


Attachment A: Corridor Engineering Drawings MATCH LINE STA. 46+25 - SEE SHEET SW-06 € CONSTRUCTION HOUSTON STREET CONSTRUCTION CEDAR STREET CEDAR STREET - LOD - LIMIT OF DISTURBANCE SW-07 DESIGNED BY: SMH PROPOSED IMPERVIOUS AREA IN LOD DEPARTMENT OF TRANSPORTATION DRAWN BY: SMH DATE: MAY, 2024 DIVISION OF TRANSPORTATION ENGINEERING MONTGOMERY COUNTY, MARYLAND CHECKED BY: SJZ DATE: MAY, 2024 DRAWING NO.: RECOMMENDED FOR APPROVAL EAST SILVER SPRING **Stantec** NEIGHBORHOOD GREENWAY Chief, Design Section STORMWATER MANAGEMENT CONCEPT PLAN Chief, Division of Transportation Engineering SCALE: 1"=20"

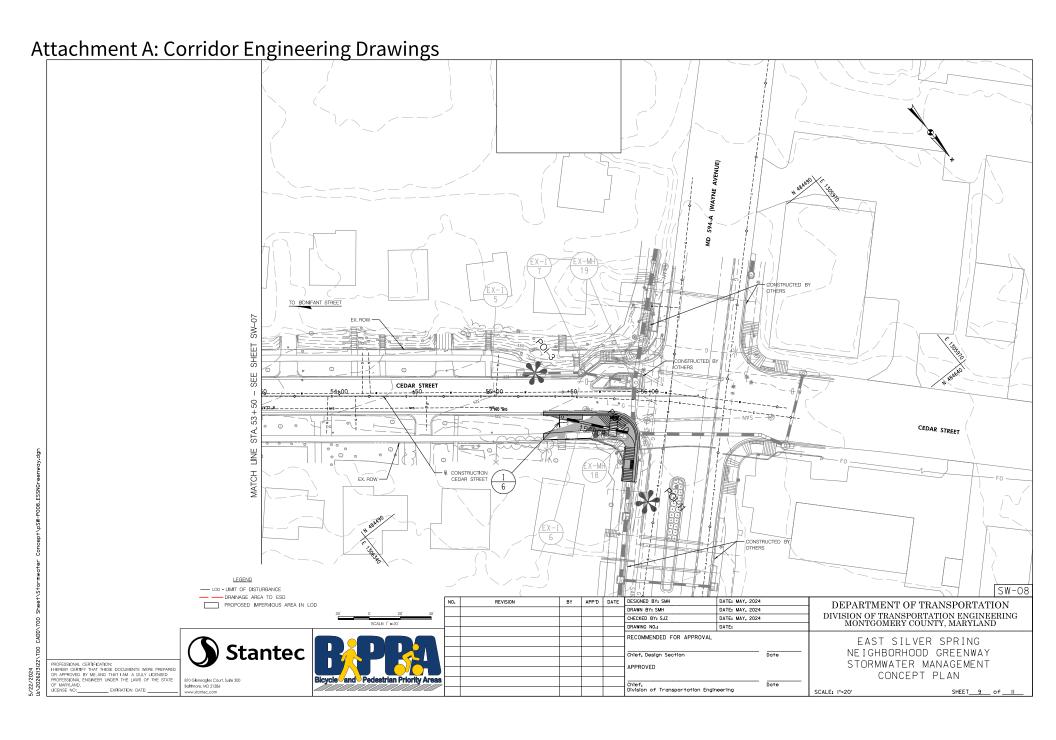


Attachment A: Corridor Engineering Drawings | E 1306500 E 1306500 202+00 HOUSTON STREET HOUSTON STREET ■ CONSTRUCTION HOUSTON STREET ■ CONSTRUCTION HOUSTON STREET E 1306650 EASLEY STREET LEGEND - LOD - LIMIT OF DISTURBANCE SW-09 DESIGNED BY: SMH APP'D DATE PROPOSED IMPERVIOUS AREA IN LOD DEPARTMENT OF TRANSPORTATION DRAWN BY: SMH DATE: MAY, 2024 DIVISION OF TRANSPORTATION ENGINEERING MONTGOMERY COUNTY, MARYLAND CHECKED BY: SJZ DATE: MAY, 2024 DRAWING NO.: DATE: RECOMMENDED FOR APPROVAL EAST SILVER SPRING **Stantec** NEIGHBORHOOD GREENWAY Chief, Design Section STORMWATER MANAGEMENT APPROVED CONCEPT PLAN Chief, Division of Transportation Engineering SHEET__IO__ of __II SCALE: 1"=20"

Attachment A: Corridor Engineering Drawings E 1306450 TO BONIFANT STREET 8W-09 TO SLIGO AVENUE SHEET 209 + 50209+00 HOUSTON STREET HOUSTON STREET STA. € CONSTRUCTION HOUSTON STREET CONSTRUCTION HOUSTON STREET E 1306650 LEGEND --- LOD - LIMIT OF DISTURBANCE SW-10 PROPOSED IMPERVIOUS AREA IN LOD DEPARTMENT OF TRANSPORTATION DRAWN BY: SMH DATE: MAY, 2024 DIVISION OF TRANSPORTATION ENGINEERING MONTGOMERY COUNTY, MARYLAND CHECKED BY: SJZ DATE: MAY, 2024 DATE DRAWING NO.: RECOMMENDED FOR APPROVAL EAST SILVER SPRING **Stantec** NEIGHBORHOOD GREENWAY Chief, Design Section STORMWATER MANAGEMENT APPROVED CONCEPT PLAN Chief, Division of Transportation Engineering SCALE: 1"=20"

Attachment A: Corridor Engineering Drawings LP-01 LP-02 =I_P-05 LP-06 LP-08 LP-07 LP-10 DRAWN BY: DHM III DATE: MAY, 2024 DIVISION OF TRANSPORTATION ENGINEERING MONTGOMERY COUNTY, MARYLAND CHECKED BY: SJZ DATE: MAY, 2024 DRAWING NO.: RECOMMENDED FOR APPROVAL **Stantec** EAST SILVER SPRING NEIGHBORHOOD GREENWAY LANDSCAPE PLAN KEY Chief, Division of Transportation Engineering SHEET_05| of | 113 SCALE: 1"=200"

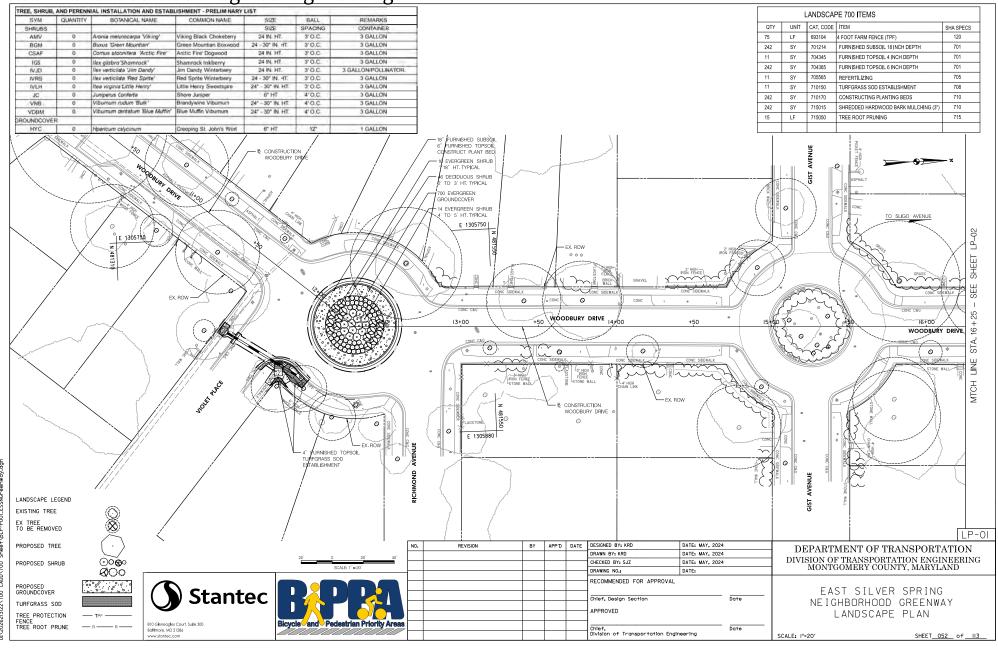

5/22/2024

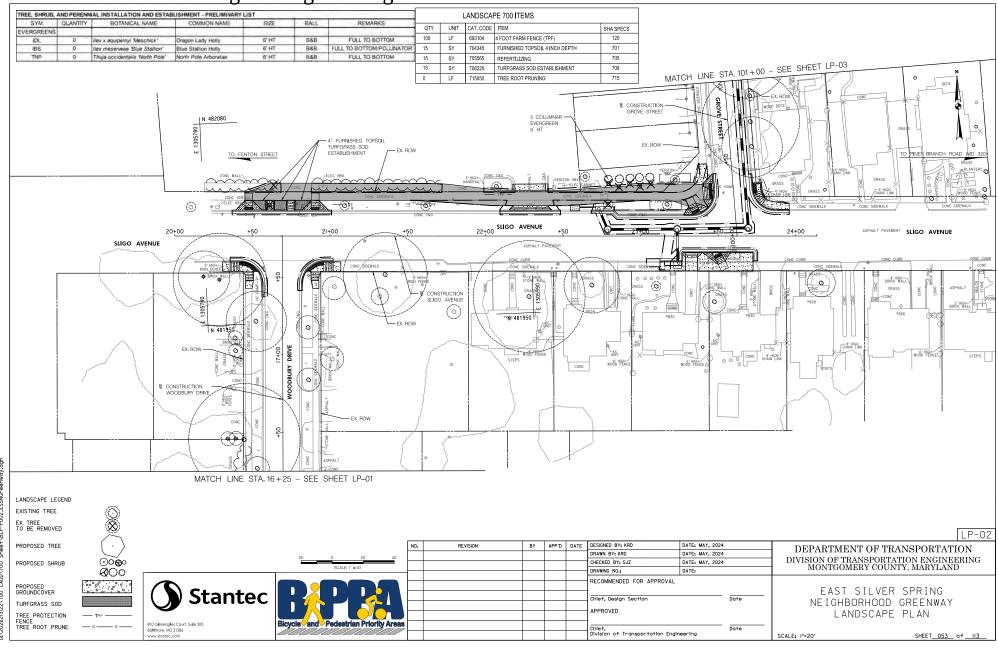

Attachment A: Corridor Engineering Drawings LANDSCAPE 700 ITEMS UNIT CAT. CODE ITEM SHA SPECS 4 FOOT FARM FENCE (TPF) FURNISHED TOPSOIL 4 INCH DEPTH 701 705 REFERTILIZING 708220 TURFGRASS SOD ESTABLISHMENT 708 TREE ROOT PRUNING 715 4' FURNISHED TOPSOIL TURFGRASS SOD ESTABLISHMENT SILVER E 1306040 SHEET EX. ROW GROVE STREET STA. MATCH CONSTRUCTION ○ 膝 LANDSCAPE LEGEND E 1306210-EXISTING TREE E 1306210 EX TREE TO BE REMOVED LP-03 DATE: MAY, 2024 PROPOSED TREE APP'D DATE DEPARTMENT OF TRANSPORTATION DRAWN BY: KRD DATE: MAY, 2024 DIVISION OF TRANSPORTATION ENGINEERING MONTGOMERY COUNTY, MARYLAND ØO° ⊙⊙⊛∘ CHECKED BY: SJZ DATE: MAY, 2024 PROPOSED SHRUB DRAWING NO.: RECOMMENDED FOR APPROVAL **Stantec** PROPOSED GROUNDCOVER EAST SILVER SPRING

Chief, Design Section


Chief, Division of Transportation Engineering


NEIGHBORHOOD GREENWAY LANDSCAPE PLAN

SCALE: 1"=20"

SHEET_054_ of _______113

TREE PROTECTION FENCE TREE ROOT PRUNE

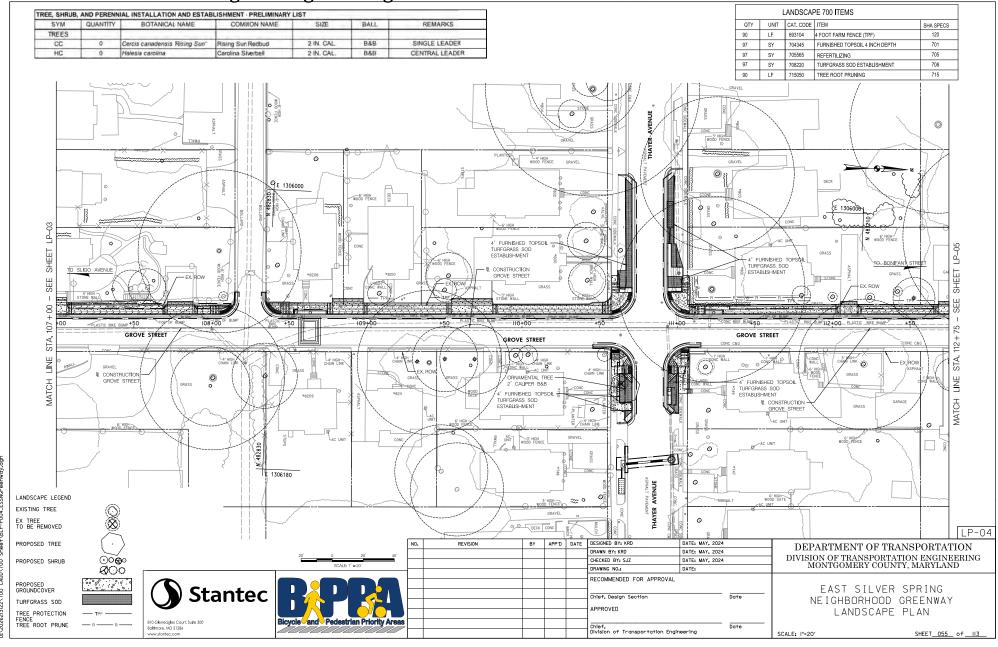

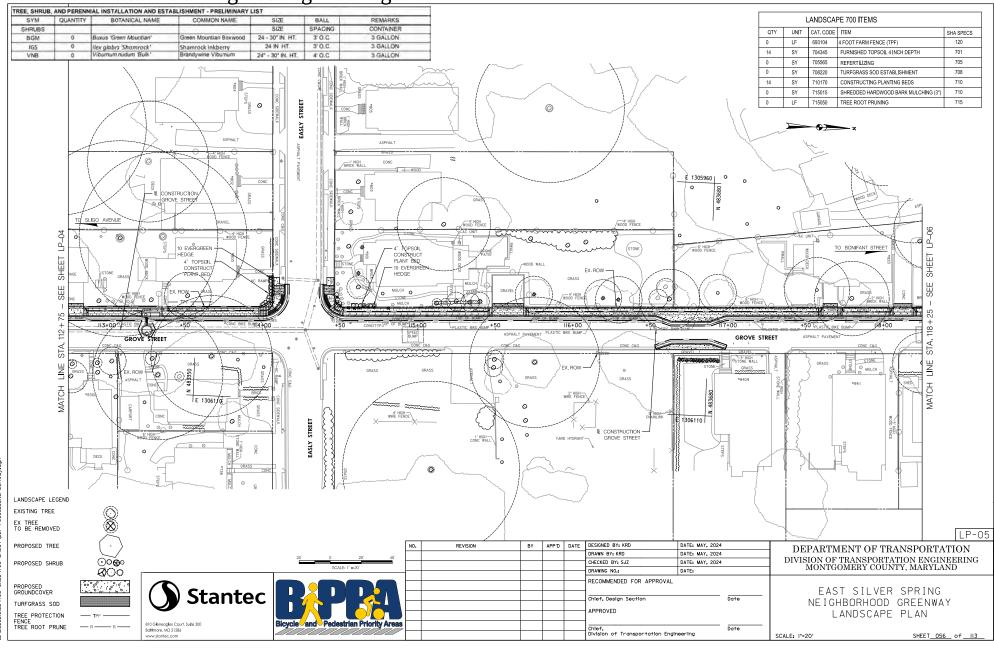

5/22/2024

Attachment A: Corridor Engineering Drawings LANDSCAPE 700 ITEMS UNIT CAT, CODE ITEM SHA SPECS 4 FOOT FARM FENCE (TPF) 120 704345 FURNISHED TOPSOIL 4 INCH DEPTH 701 REFERTILIZING 705 TURFGRASS SOD ESTABLISHMENT 708 715 TO FENTON STREET TURFGRASS SOD ESTABLISHMENT TYPICAL 45+00 BONIFANT STREET BONIFANT STREET CONSTRUCTION BONIFANT STREET 4" FURNISHED TOPSOIL TURFGRASS SOD ESTABLISHMENT LANDSCAPE LEGEND EXISTING TREE EX TREE TO BE REMOVED LP-06 REVISION DESIGNED BY: KRD PROPOSED TREE DEPARTMENT OF TRANSPORTATION DRAWN BY: KRD DATE: MAY, 2024 DIVISION OF TRANSPORTATION ENGINEERING MONTGOMERY COUNTY, MARYLAND CHECKED BY: SJZ DATE: MAY, 2024 PROPOSED SHRUB DRAWING NO.: RECOMMENDED FOR APPROVAL **Stantec** PROPOSED GROUNDCOVER EAST SILVER SPRING

Chief, Design Section

Chief, Division of Transportation Engineering

NEIGHBORHOOD GREENWAY

LANDSCAPE PLAN

SCALE: 1"=20"

SHEET_057_ of _______113_

TURFGRASS SOD

TREE PROTECTION FENCE TREE ROOT PRUNE

Attachment A: Corridor Engineering Drawings LANDSCAPE 700 ITEMS CAT, CODE | ITEM SHA SPECS 4 FOOT FARM FENCE (TPF) 120 FURNISHED TOPSOIL 4 INCH DEPTH 701 705 REFERTILIZING 708220 708 TREE ROOT PRUNING FURNISHED TOPSOIL TURFGRASS SOD ESTABLISHMENT (o) CONSTRUCTION BONIFANT STREET 0 (o) +50 CEDAR STREET 53+00 52+00 CEDAR STREET Y MR TURFGRASS SOD FSTABLISHMENT LANDSCAPE LEGEND EXISTING TREE EX TREE TO BE REMOVED LP-07 DESIGNED BY: KRD PROPOSED TREE DEPARTMENT OF TRANSPORTATION DRAWN BY: KRD DATE: MAY, 2024 DIVISION OF TRANSPORTATION ENGINEERING MONTGOMERY COUNTY, MARYLAND CHECKED BY: SJZ DATE: MAY, 2024 PROPOSED SHRUB DRAWING NO.: RECOMMENDED FOR APPROVAL **Stantec** PROPOSED GROUNDCOVER EAST SILVER SPRING Chief, Design Section

Chief, Division of Transportation Engineering

NEIGHBORHOOD GREENWAY LANDSCAPE PLAN

SCALE: 1"=20"

SHEET_058_ of _______113

TREE PROTECTION FENCE TREE ROOT PRUNE


Attachment A: Corridor Engineering Drawings LANDSCAPE 700 ITEMS UNIT CAT, CODE ITEM SHA SPECS 693104 4 FOOT FARM FENCE (TPF) 120 FURNISHED TOPSOIL 4 INCH DEPTH 704345 701 REFERTILIZING 705 TURFGRASS SOD ESTABLISHMENT 708 708220 TREE ROOT PRUNING 715050 715 O BONIFANT STREET SHEET 0 CEDAR STREET 55+00 CEDAR STREET CONSTRUCTION CEDAR STREET 4" FURNISHED TOPSOIL —
TURFGRASS SOD
ESTABLISHMENT LANDSCAPE LEGEND EXISTING TREE EX TREE TO BE REMOVED LP-08 DESIGNED BY: KRD PROPOSED TREE DEPARTMENT OF TRANSPORTATION DRAWN BY: KRD DATE: MAY, 2024 DIVISION OF TRANSPORTATION ENGINEERING MONTGOMERY COUNTY, MARYLAND CHECKED BY: SJZ DATE: MAY, 2024 PROPOSED SHRUB DATE DRAWING NO.: RECOMMENDED FOR APPROVAL **Stantec** PROPOSED GROUNDCOVER EAST SILVER SPRING Chief, Design Section NEIGHBORHOOD GREENWAY TURFGRASS SOD LANDSCAPE PLAN TREE PROTECTION FENCE TREE ROOT PRUNE

Chief, Division of Transportation Engineering

SHEET<u>059</u> of <u>II3</u>

SCALE: 1"=20"

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		BOTANICAL NAME	COMMON NAME	SIZE	0.011	REVARKS	LANDSCAPE 700 ITEMS
SYM	QUANTITY	BUTANICAL NAME	COMMON NAME	SIZE	BALL	REVIARAS	QTY UNIT CAT. CODE ITEM SHA SPECS
ERGREENS	0	Have a naviganous Manage of	Change Lady Hally	6' HT	B&B	FULL TO BOTTOM	100 LF 693104 4 FOOT FARM FENCE (TPF) 120
IBS	0	llex x aquipernyi "Meschick" llex meserveae "Blue Stallion"	Dragon Lady Holly Blue Stallion Holly	6' HT	B&B	FULL TO BOTTOM/POLLINATOR	50 SY 704345 FURNISHED TOPSOIL 4 INCH DEPTH 701
TNP	0	Thuja occidentalis 'North Pole'	North Pole Arborvitae	6' HT	B&B	FULL TO BOTTOM	0 SY 70556 REFERILED 705
HRUBS	-	Thuja occidentalia Tvortii Fole	TWOITIT DIE ALDOIMIGE	SIZE	SPACING	CONTAINER	0 SY 708220 TURFGRAS SOD ESTABLISHMENT 708
BGM	0	Buxus 'Green Mountian'	Green Mountian Boxwood	24 - 30" IN. HT.	3' O.C.	3 GALLON	50 SY 710170 CONSTRUCTING BEDS 710
CSAF	0	Corrus stolonifera 'Arctic Fire'	Arctic Fire' Dogwood	24 IN. HT.	3' O.C.	3 GALLON	50 SY 715015 SKREDDED HARDWOOD BARK MULCHING (3*) 710
IGS	0	Ilex glabra 'Shamrock'	Shamrock Inkberry	24 IN. HT.	3' O.C.	3 GALLON	100 LF 715050 TREE ROOT PRUNING 715
IVJD	0	Ilex verticilata 'Jim Dandy'	Jim Dandy Winterberry	24 IN. HT.	3' O.C.	3 GALLON/POLLINATOR	100 E TOOM NEETHON THE TOOM TO
IVRS	0	Ilex verticilata 'Red Sprile'	Red Sprite Winterberry	24 - 30" IN. HT.	3' O.C.	3 GALLON	
IVLH	0	Itea virginia 'Little Henry'	Little Henry Sweetspire	24" - 30" IN, HT.	3' O.C.	3 GALLON	
VNB	0	Vibumum nudum 'Bulk'	Brandywine Vibumum	24" - 30" IN. HT.	4' O.C.	3 GALLON	
VDBM	0	Vibumum dentatum 'Blue Muffin'	Blue Muffin Viburnum	24" - 30" IN. HT.	4' O.C.	3 GALLON	N
	EST PARTIE	TONE PLANTING		N 483250	1306500		EASIEY STREET
200+	CONC G	12 EVE		4 A-DRINSHELD ONSTRUCT PL 11 DECIDIOUS -5 HT -50 HOUSTC	HEDGE REGERATION 202+00 DN STREET	PATEUCTION DISTRICTION DISTRICTION DISTRICTION EX.	EX. ROW OBJECTION OB
NDSCAPE LEG STING TREE TREE BE REMOVED						JOSION SIREEL	E 1306650 E CONSTRUCTION HOUSTON STREET
ODOCED TREE	. (NO. REVISION	BY APP'D DATE DESIGNED BY: KRD DATE: MAY, 2024 DED A DOMENIO OF OTRIANS DODOES AND DATE: MAY, 2024
POSED TREE	. (_/		20'	20'	40' REVISION	DEPARTMENT OF TRANSPORTATION
POSED SHRL	ıв 🤄) ○⊗ ∘		SCALE: 1	2U " = 90"	=	CHECKED BY: SJZ DATE: MAY, 2024 DIVISION OF TRANSPORTATION ENGINEERI MONTGOMERY COUNTY, MARYLAND
POSED UNDCOVER FGRASS SOE E PROTECTION CE E ROOT PRU	ON — TPF		tantec	Pedestr			RECOMMENDED FOR APPROVAL Chief, Design Section APPROVED Date EAST SILVER SPRING NEIGHBORHOOD GREENWAY LANDSCAPE PLAN
	INE — R —	Ballimore, MD 21286					Chief, Date Division of Transportation Engineering SCALE-11-20' SHEFT ORD of
. 11001 1110		www.stantec.com					Division of Transportation Engineering SCALE: 1'=20' SHEET_060_ of_

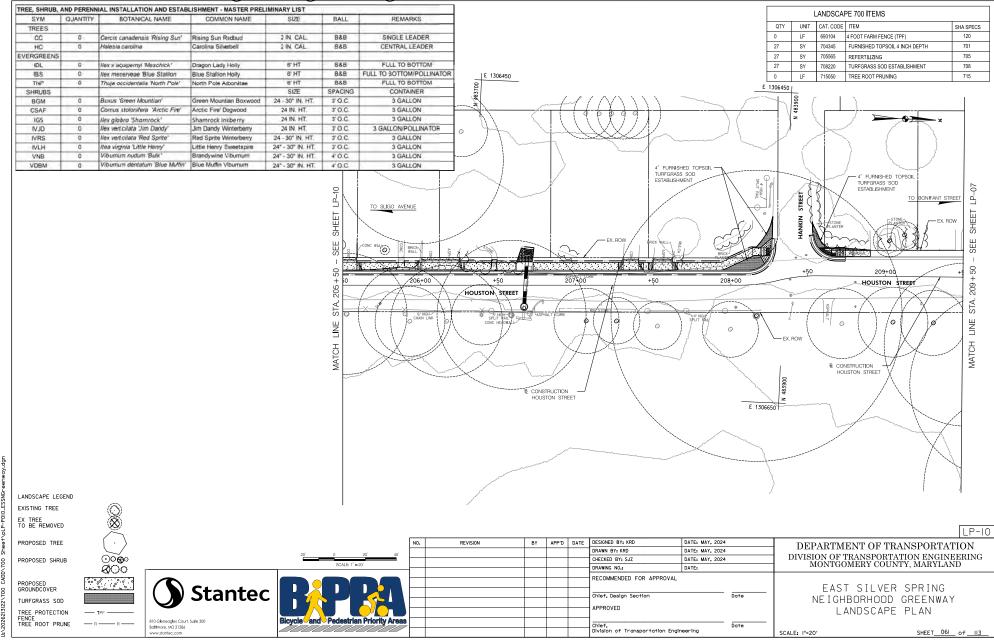

2. TREAT AND REMOVE INVASIVE SPECIES WHERE INDICATED ON THE PLANS AND WHERE DIRECTED BY THE ENGINEER. 3. RETAIN DESIRABLE TREES, SHRUBS, AND PERENNIALS EXCEPT WHERE INDICATED ON THE PLANS OR DIRECTED BY THE ENGINEER.

4. DO NOT REMOVE OR PRUNE THE BRANCHES OR ROOTS OF TREES WITHIN MOOT SHA RIGHT-OF-WAY WITHOUT AN APPROVED

ROADSIDE TREE PERMIT OR REFORESTATION SITE REVIEW APPROVAL FROM THE MD DEPARTMENT OF NATURAL RESOURCES FOREST SERVICE.

5. PLANT IN CLUSTERS OF 3 TO 5 INDIVIDUAL TREES/SHRUBS OF LIKE SPECIES TO CREATE A PATTERN CONSISTENT WITH NATURAL

FOREST DEVELOPMENT.

SITE SPECIFIC NOTES

1.TREE PLANTING SETBACKS:

A. NO TREES SHALL BE LOCATED IN CLEAR ZONES ADJACENT TO TRAVEL LANES OR IN INTERSECTION SIGHT TRIANGLES. 1. IN FILL SLOPES OF 5:1 TO 4:1 THE MINIMUM OFFSET DISTANCE TO TREE TRUNKS FOR A TRAVEL LANE WITH A POSTED SPEED OF 55 MPH IS 30 FEET.

B. MAINTAIN OFFSETS FROM OVERHEAD ELECTRIC LINES AS PER THE FOLLOWING BASED ON SIZE AT MATURITY: 1. OFFSET SMALL TREES (UNDER 20 FT, HEIGHT AT MATURITY) 20 FT, FROM WIRES AND POLES.

2. OFFSET MEDIUM TREES (20-50 FT. HEIGHT AT MATURITY AND MEDIUM AND LARGE COLUMNAR TREES 20 FT. WIDE

MATURITY) 30 ET EROM WIRES AND POLES 3. OFFSET LARGE TREES (OVER 50 FT, HEIGHT AT MATURITY) 50 FT, FROM WIRES AND POLES.

C. INSTALL TREES AT LEAST 7 FT. PLUS HALF THE PIPE DIAMETER FROM THE CENTERLINE OF WATER, GAS, AND SANITARY SEWER

LINES. ADDITIONAL SETBACKS MAY BE REQUIRED BY THE OWNER OF THE UTILITY.

D. INSTALL TREES AT LEAST 7 FT. PLUS HALF THE PIPE DIAMETER OF UNDERGROUND STORM DRAIN PIPES.

E. INSTALL TREES AT LEAST 15 FT. FROM BACK OF TRAFFIC BARRIERS

F. INSTALL SHADE TREES AND UPRIGHT/COLUMNAR ORNAMENTAL TREES AT LEAST 5 FT. BACK FROM THE BACK OF

CLOSED-SECTION MEDIAN PLANTINGS

G. INCREASE SETBACKS FROM ROADS, SIDEWALKS, TRAFFIC CONTROL DEVICES AND STRUCTURES FOR MULTISTEMMED

BROAD-SPREADING ORNAMENTAL TREES TO MAINTAIN NECESSARY BRANCH CLEARANCE.

2.SHRUB PLANTING SETBACKS: A. INSTALL SHRUBS AT LEAST 10 FT. FROM TRAFFIC BARRIERS.

B. DO NOT INSTALL SHRUBS IN SIGHT TRIANGLES FOR INTERSECTIONS WHERE THE MATURE HEIGHT OF THE SHRUBS WHEN ADDED

TO EXISTING TERRAIN WILL EXCEED 30 IN, HEIGHT,

MDTA LANDSCAPE NOTES

7.1 LANDSCAPE NOTES LANDSCAPE CONSTRUCTION WITHIN THE RIGHT OF WAY OF THE MARYLAND STATE HIGHWAY ADMINISTRATION (SHA) AND MARYLAND TRANSPORTATION AUTHORITY (MDTA) WITHIN STATE PROPERTY, EASEMENT AREAS AND LANDS TO BE CONVEYED TO SHA/MTA SHALL CONFORM TO THESE NOTES. FOR GUIDANCE REGARDING DESIGN MODIFICATIONS DURING CONSTRUCTION, REFER TO SHA LANDSCAPE DESIGN GUIDE, SHA LANDSCAPE ESTIMATING MANUAL AND SHA ENVIRONMENTAL GUIDE FOR ACCESS AND DISTRICT PERMIT APPLICANTS AT HTTP://WWW.ROADS.MARYLAND.GOV/INDEX.ASPX?PAGEID=25

- 7.2 SHA STANDARD SPECIFICATIONS, LANDSCAPE CONSTRUCTION SHALL CONFORM TO SECTIONS 701 THROUGH 716, AND LANDSCAPE MATERIALS SHALL CONFORM TO SECTION 920 OF THE MOST RECENT REVISION OF SHA STANDARD SPECIFICATIONS FOR CONSTRUCTION AND MATERIALS, INCLUDING ALL REVISIONS AND SUPPLEMENTS, AND AS SPECIFIED IN THESE NOTES. THESE REQUIREMENTS SHALL SUPERSEDE ALL OTHER SPECIFICATIONS FOR WORK ON SHA PROPERTY. CURRENT SPECIFICATIONS ARE AT HTTP://www.ROADS.MARYLAND.GOV/INDEX.ASPX?PAGEID=44
- 7.3 FROSION AND SEDIMENT CONTROL MANAGER (ESCM) SOIL DISTURBANCE SUCH AS GRADING EXCAVATION SOIL PLACEMENT OR OTHER ACTIVITIES THAT INVOLVE SOIL DISTURBANCE SHALL BE SUPERVISED BY AN ESCM MANAGER WITH A VALID "SHA YELLOW CARD" IN CONFORMANCE WITH SHA STANDARD SPECIFICATIONS AND ANY APPLICABLE EROSION AND SEDIMENT CONTROL PERMIT
- 7.4 SHA STANDARD DETAILS FOR TREES, SHRUBS AND PLANTING BEDS. THE INSTALLATION OF TREES, SHRUBS, PLANTING BEDS AND OTHER LANDSCAPE CONSTRUCTION RELATED TO SECTION 710 OF THE SHA STANDARD SPECIFICATIONS SHALL CONFORM TO THE "SHA BOOK OF STANDARDS FOR HIGHWAY & INCIDENTAL STRUCTURES - CATEGORY 7" AT HTTP://APPS.ROADS.MARYLAND.GOV/BUSINESSWITHSHA/BIZSTDSSPECS/DESMANUALSTDPUE /PUBLICATIONSONLINE/OHD/BOOKSTD/TOCCAT7.ASP.
- 7.5 TEMPORARY STARILIZATION SHALL BE INSTALLED IN CONFORMANCE WITH SECTION 704 TO ENSURE THAT AREAS OF SOIL DISTURBANCE ARE PROTECTED FROM WIND, RAINFALL AND FLOWING WATER UNTIL PERMANENT STABILIZATION IS
- TEMPORARY MULCH, EITHER AS TEMPORARY STRAW MULCH OR TEMPORARY MATTING MULCH, SHALL BE INSTALLED AT THE END OF EACH WORKING DAY TO PROVIDE "SAME DAY STABILIZATION" UNLESS OTHER APPROVED STABILIZATION IS
- TEMPORARY STRAW MULCH SHALL BE INSTALLED ON AREAS AND SLOPES FLATTER THAN 4:1 TEMPORARY MATTING MULCH SHALL BE APPLIED ON SLOPES 4:1 AND STEEPER, AND TO AREAS WITHIN CHANNELS. TEMPORARY SED SHALL BE INSTALLED IN LIEU OF TEMPORARY MULCH WHEN SOLL REDISTURBANCE IS EXPECTED
- MORE THAN 30 DAYS AFTER SOIL DISTURBANCE. THE REQUIRED APPLICATION RATE SHALL BE 100 LBS PER ACRE OF 37-0-0 (SCU) FERTILIZER.

7.6 ROADWAY PAVEMENT REMOVAL. AREAS OF ROADWAY REMOVAL SHALL BE EXCAVATED TO REMOVED PAVEMENTS, AGGREGATE BASE, AND COMPACTED SOIL TO A MINIMUM DEPTH OF 10 INCHES BELOW THE PAVEMENT SURFACE OR AS NECESSARY TO REMOVE ALL MATERIAL UNSUITABLE FOR LANDSCAPING. THE EXCAVATION AREAS SHALL BE RESTORED WITH SUBSOIL AND TOPSOIL AS PART OF SOIL RESTORATION.

- 7.7 EXCAVATION AND DEBRIS REMOVAL. DEBRIS RELATED TO THE DEMOLITION OF SIDEWALKS, DRIVEWAYS, CURBS, TREES, STUMPS, ROOTS, FENCING, PIPES, AND OTHER MATERIALS THAT MAY INTERFERE WITH LANDSCAPE INSTALLATION OR FUTURE MAINTENANCE SHALL BE EXCAVATED AS NECESSARY FOR THEIR COMPLETE REMOVAL AND DISPOSAL
- 7.8 SOIL RESTORATION, AREAS OF PAVEMENT REMOVAL, EXCAVATION OR DRILLING IN LANDSCAPED AREAS SHALL REMOVE EXCAVATED DEBRIS AND RESTORE THE SUBGRADE WITH APPROVED SUBSOIL AND TOPSOIL PLACED IN CONFORMANCE WITH SECTION 701 OF THE SHA STANDARD SPECIFICATIONS.

A LAYER OF APPROVED TOPSOIL AT LEAST 4 INCH DEPTH SHALL BE PLACED ON ALL DISTURBED AREAS FLATTER THAN

2:1 AND IN ALL CHANNELS PRIOR TO SEEDING SODDING OR OTHER LANDSCAPING LINESS OTHERWISE SPECIFIED A LAYER OF APPROVED TOPSOIL AT LEAST 2 INCH DEPTH SHALL BE PLACED ON ALL DISTURBED AREAS 2:1 AND STEEPER PRIOR TO SEEDING, SODDING OR OTHER LANDSCAPING, LINESS OTHERWISE SPECIFIED. 3. BIORETENTION SOIL MIX (BSM) AND OTHER MATERIALS INSTALLED IN CONJUNCTION WITH SPI 316 - STORMWATER FILTRATION FACILITIES AND SHA STORMWATER DETAILS SHALL BE INSTALLED IN CONFORMANCE WITH THE SHA LANDSCAPE NOTES AND LANDSCAPE PLANS, PLANT MATERIALS AND MULCH SHALL BE INSTALLED IN BSM IN CONFORMANCE WITH STORMWATER DETAILS, SECTION 710 OR OTHER SHA SPECIFICATIONS.

7.9 TURFGRASS SOD ESTABLISHMENT SHALL BE PERFORMED IN ALL DISTURBED AREAS, OR WITHIN THE AREAS INDICATED IN THE PLANS IN CONFORMANCE WITH SECTION 708 OF THE SHA STANDARD SPECIFICATIONS. THE REQUIRED APPLICATION RATE OF 20-16-12 FERTILIZER SHALL BE 200 LBS PER ACRE, AND NO FERTILIZER SHALL BE APPLIED FROM NOVEMBER 15 TO

7.10 TUREGRASS ESTABLISHMENT SHALL BE PERFORMED IN ALL DISTURBED AREAS OR WITHIN THE AREAS INDICATED IN THE PLANS, IN CONFORMANCE WITH SECTION 705 OF THE SHA STANDARD SPECIFICATIONS. THE REQUIRED APPLICATION RATE OF 20-16-12 FERTILIZER SHALL BE 200 LBS PER ACRE, AND NO FERTILIZER SHALL BE APPLIED FROM NOVEMBER 15 TO MARCH 1.

7.11 SOIL STABILIZATION MATTING SHALL BE INSTALLED IN CONFORMANCE WITH SECTION 709 OF THE SHA STANDARD SPECIFICATIONS, IN CONJUNCTION WITH TURFGRASS ESTABLISHMENT PER SECTION 705 OR MEADOW ESTABLISHMENT PER

1, AREAS FLATTER THAN 6:1. TYPE A OR TYPE E MATTING MAY BE INSTALLED IN LIEU OF STRAW MULCH AND

HYDROMULCH BINDER IN CONJUNCTION WITH TURFGRASS ESTABLISHMENT.

2. AREAS STEEEPER THAN 6:1 AND FLATTER THAN 4:1. TYPE A OR TYPE E MATTING SHALL BE INSTALLED IN LIEU OF STRAW MULCH AND HYDORMULCH BINDER IN CONJUNCTION WITH TURFGRASS ESTABLISHMENT, UNLESS DELINEATED AND NOTED OTHERWISE.

3. CHANNELS, STORMWATER MANAGEMENT FACILITIES, AND SLOPES 4:1 AND STEEPER TYPE A SOIL STABILIZATION MATTING SHALL BE INSTALLED IN LIEU OF STRAW MULCH AND HYDROMULCH BINDER IN CONJUNCTION WITH TURFGRASS ESTABLISHMENT, UNLESS DELINEATED AND NOTED OTHERWISE.

7.13 TREE PRESERVATION AREAS, TEMPORARY ORANGE CONSTRUCTION FENCE (TOCF) SHALL BE INSTALLED IN LOCATIONS DELINEATED ON THE PLANS IN CONFORMANCE WITH SECTION 120 OF THE SHA STANDARD SPECIFICATION TO PROTECT EXISTING TREES AND OTHER VEGETATION DURING CONSTRUCTION, AREAS WITHIN TOCE SHALL BE PROTECTED FROM ALL PROHIBITED AND RESTRICTED ACTIVITIES AS SPECIFIED IN SECTION 120.

7.14 ROADSIDE TREE PERMIT. TREE REMOVAL, TREE INSTALLATION, TREE ROOT AND BRANCH PRUNING, AND OTHER REGULATED IMPACTS TO TREES IN THE SHA RIGHT OF WAY SHALL CONFORM TO THE REQUIREMENTS OF THE ROADSIDE TREE PERMIT (RTP) OF THE MARYLAND DEPARTMENT OF NATURAL RESOURCES, OR THE APPROVED FOREST CONSERVATION ACT PLAN OF THE LOCAL AUTHORITY

1. A COPY OF THE RTP OR FCP SHALL BE SUBMITTED TO THE SHA OFFICE OF ENVIRONMENTAL DESIGN BEFORE WORK IS PERFORMED, AND A COPY OF THE RTP OR ECP SHALL BE REPRODUCED IN THE PLANS OR BE IN POSSESSION OF THE APPLICANT AT THE PROJECT SITE WHEN THE PERMITTED WORK IS PERFORMED

2. A MARYLAND LICENSED TREE EXPERT SHALL PERFORM THE SPECIFIED TREE OPERATIONS IN CONFORMANCE WITH THE SHA STANDARD SPECIFICATIONS AND ANSI A300 STANDARDS FOR TREE CARE OPERATIONS.

7.15 TREES AND OTHER PLANT MATERIAL INSTALLATION. TREES, SHRUBS, PERENNIALS, ANNUALS, BULBS, LANDSCAPE BEDS, BARK MULCH AND SIMILAR MATERIALS SHALL BE INSTALLED IN CONFORMANCE WITH SECTION 710 AND 711 OF THE SHA STANDARD SPECIFICATIONS. TREE AND SHRUBS SHALL BE PRUNED AT THE TIME OF INSTALLATION TO ENSURE SIDEWALK CLEARANCE FOR PEDESTRIANS IS MAINTAINED TO A HEIGHT OF 8 FEET. NO TREE OR SHRUB SHALL BE INSTALLED WITHIN 3 FEET OF CURBS, SIDEWALKS, OR PAVEMENT EDGES.

7.20 STUMP REMOVAL, STUMP REMOVAL IN TURFGRASS OR MEADOW AREAS SHALL BE PERFORMED IN CONFORMANCE WITH OPERATION 5 - STUMP REMOVAL OF SECTION 714.

7.21 TREE BRANCH PRUNING SHALL BE PERFORMED OR DIRECTLY SUPERVISED BY A MARYLAND LICENSED TREE EXPERT IN CONFORMANCE WITH ANSI A300 STANDARDS PER SECTION 712 AS NECESSARY FOR ANY OF THE FOLLOWING: TO INSTALL TEMPORARY ORANGE CONSTRUCTION FENCE (TOCF) ALONG DELINEATIONS OF PLANS; TO PERFORM TREE ROOT PRUNING ALONG DELINEATIONS ON PLANS: TO PROVIDE 8 FOOT CLEARANCE ABOVE SIDEWALK PAVEMENTS AND 16 FOOT CLEARANCE ABOVE ROADWAY PAVEMENTS: TO REPAIR TREE WOUNDS; AND TO PERFORM OTHER RECOMMENDED CLEANING, THINNING, REDUCING, AND PRUNING NECESSARY TO ACCOMMODATE LITHLITIES, ALL DEBRIS SHALL BE REMOVED FROM SHA PROPERTY

7.22 TREE ROOT PRUNING SHALL BE PERFORMED ALONG THE LINE SHOWN ON THE PLANS IN CONFORMANCE WITH SECTION 715. TREE ROOT PRUNING SHALL BE COMPLETED BEFORE BEGINNING EXCAVATION OR OTHER CONSTRUCTION ADJACENT TO TREES TO BE PRESERVED.

7.23 FINISHED MATERIALS, THE SUITABILITY, COLOR AND TEXTURE OF APPLICANT TO INSERT NAME OF MATERIALS WITH REFERENCES TO PAGES OF THE PLAN WHICH SPECIFY THESE MATERIALS TO BE INSTALLED. SHALL BE APPROVED BEFORE INSTALLATION, THE CONTRACTOR SHALL FURNISH SAMPLE OR MAKE ARRANGEMENTS FOR INSPECTION AND APPROVAL AT THE PROJECT SITE.

TREE PROTECTION NOTE:

REFER TO TREE SAVE PLAN SNRI-42022181E FOR SEQUENCE OF CONSTRUCTION & TREE PROTECTION. NOTES AND DETAILS.

TREE PROTECTION FENCE AND TREE ROOT PRUNE ARE INSTALLED AND PERFORMED AT THE LOD LINE. FINAL DETERMINATION TO BE MADE DURING THE PRECONSTRUCTION MEETING FOR TREE PROTECTION.

LANDSCAPE 700 ITEMS							
QTY	QTY UNIT CAT. CODE ITEM						
719	LF	693104	4 FOOT FARM FENCE (TPF)	120			
242	SY	701214	FURNISHED SUBSOIL 18 INCH DEPTH	701			
597	SY	704345	FURNISHED TOPSOIL 4 INCH DEPTH	701			
242	SY	704365	FURNISHED TOPSOIL 6 INCH DEPTH	701			
533	SY	705565	REFERTILIZING	705			
533	SY	708220	TURFGRASS SOD ESTABLISHMENT	708			
306	SY	710170	CONSTRUCTING PLANTING BEDS	710			
306	SY	715015	SHREDDED HARDWOOD BARK MULCHING (3*) SHBM IS INCIDENTAL TO CONSTRUCTING PLANTING BED	710			
429	LF	715050	TREE ROOT PRUNING	715			

LP-II

Stantec



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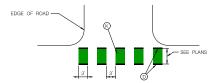
EAST SILVER SPRING NEIGHBORHOOD GREENWAY LANDSCAPE NOTES

DEPARTMENT OF TRANSPORTATION


DIVISION OF TRANSPORTATION ENGINEERING MONTGOMERY COUNTY, MARYLAND

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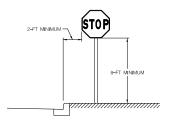
SHEET 062 of II3




TYPICAL CONFLICT ZONE DETAIL

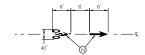


BIKE LANE SYMBOL DETAIL




POST MOUNTED SIGN DETAIL

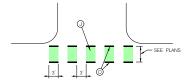

TYPICAL CONFLICT ZONE DETAIL AT ROADWAYS

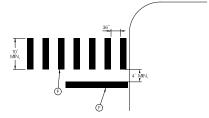

TYPICAL CROSSWALK DETAIL SHA

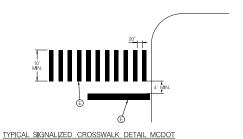

NOTE: STOP BARS AT UNSIGNALIZED CROSSWALK SHALL BE 16" FOR MCDOT

PAVEMENT MARKING LEGEND

- (A) INSTALL 5 INCH YELLOW LEAD FREE THERMOPLASTIC PAVEMENT MARKING (DOUBLE)
- (B) INSTALL 5 INCH WHITE LEAD FREE THERMOPLASTIC PAVEMENT MARKING (SOLID)
- (C) INSTALL 5 INCH YELLOW LEAD FREE THERMOPLASTIC PAVEMENT MARKING (SOLID)
- (D) INSTALL 5 INCH WHITE LEAD FREE THERMOPLASTIC PAVEMENT MARKING (3-3-3 SKIP)
- (E) INSTALL 16 INCH WHITE LEAD FREE THERMOPLASTIC PAVEMENT MARKING.
- (F) INSTALL 24 INCH WHITE LEAD FREE THERMOPLASTIC PAVEMENT MARKING (G) INSTALL WHITE PREFORMED THERMOPLASTIC PAVEMENT MARKING LEGENDS AND SYMBOLS
- (H) INSTALL BIKE SYMBOL WITH AN ARROW
- () INSTALL SHARROW
- (NSTALL GREEN PAVEMENT MARKING; EPOXY (LOW TRAFFIC VOLUME AREAS)
- REMOVE PAVEMENT MARKING

	DEPARTMENT OF TRANSPORTATION DIVISION OF TRAFFIC ENGINEER AND OPERATIONS MONTGOMERY COUNTY, MO
	APPROVED
For	
BY	
DATE:	

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•	Bicycle and Pedestrian Priority Areas	
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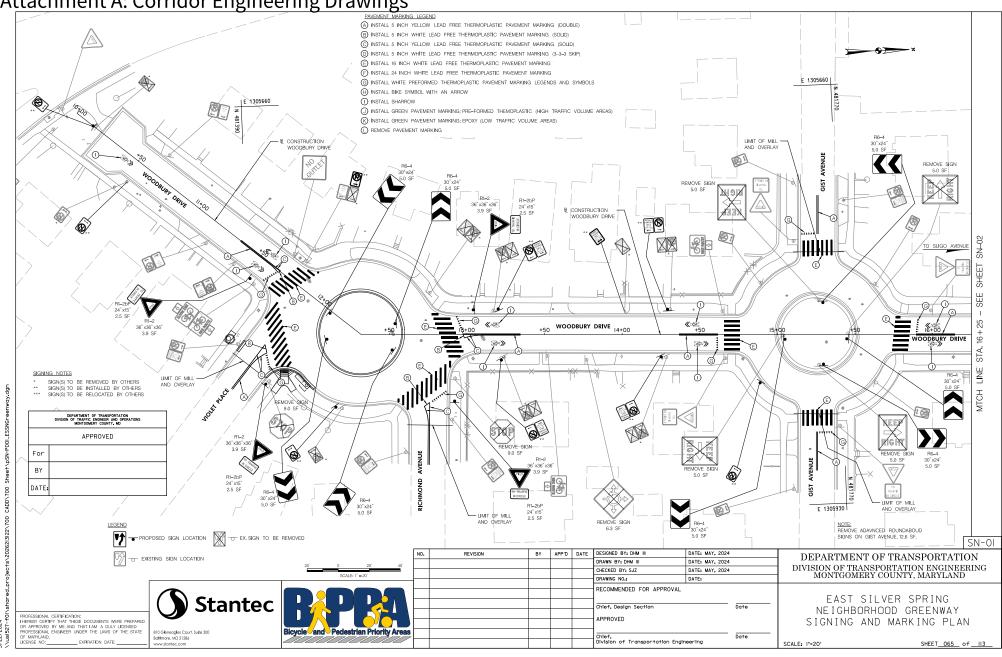
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					DRAWN BY: DHM III	DATE: MAY, 2024	
					CHECKED BY: SJZ	DATE: MAY, 2024	
					DRAWING NO.:	DATE:	
					RECOMMENDED FOR APPROVAL		
					Chief. Design Section		Date
					APPROVED		
					Chief, Division of Transportation Engin	eering	Date

EAST SILVER SPRING NEIGHBORHOOD GREENWAY SIGNING AND MARKING DETAILS

DEPARTMENT OF TRANSPORTATION DIVISION OF TRANSPORTATION ENGINEERING MONTGOMERY COUNTY, MARYLAND

SHEET_063_ of_ II3_ SCALE: NTS

Attachment A: Corridor Engineering Drawings SN-01 = || = | = | =SN-05 SN-08 SN-07 SN-10 DRAWN BY: DHM III DATE: MAY, 2024 DIVISION OF TRANSPORTATION ENGINEERING MONTGOMERY COUNTY, MARYLAND CHECKED BY: SJZ DATE: MAY, 2024 DRAWING NO.: RECOMMENDED FOR APPROVAL **Stantec** EAST SILVER SPRING NEIGHBORHOOD GREENWAY SIGNING AND MARKING PLAN KEY Chief, Division of Transportation Engineering



Attachment A: Corridor Engineering Drawings MATCH LINE STA. 101+00 - SEE SHEET SN-03 N 482100 RELOCATE SIGNS (4015) **GOTS** TO FENTON STREET SLIGO AVENUE SLIGO AVENUE **B** 20+00 SLIGO AVENUE LIMIT OF MILL € CONSTRUCTION SLIGO AVENUE STOP N 481940 WOODBURY gho. REMOVE SIGN WOODBURY DRIVE PAVEMENT MARKING LEGEND (A) INSTALL 5 INCH YELLOW LEAD FREE THERMOPLASTIC PAVEMENT MARKING (DOUBLE) (B) INSTALL 5 INCH WHITE LEAD FREE THERMOPLASTIC PAVEMENT MARKING (SOLID) (C) INSTALL 5 INCH YELLOW LEAD FREE THERMOPLASTIC PAVEMENT MARKING (SOLID) (D) INSTALL 5 INCH WHITE LEAD FREE THERMOPLASTIC PAVEMENT MARKING (3-3-3 SKIP) APPROVED (E) INSTALL 16 INCH WHITE LEAD FREE THERMOPLASTIC PAVEMENT MARKING MATCH LINE STA. 16+25 - SEE SHEET SN-01 (G) INSTALL WHITE PREFORMED THERMOPLASTIC PAVEMENT MARKING LEGENDS AND SYMBOLS BY SIGNING NOTES SIGN(S) TO BE REMOVED BY OTHERS SIGN(S) TO BE INSTALLED BY OTHERS SIGN(S) TO BE RELOCATED BY OTHERS DATE (J) INSTALL GREEN PAVEMENT MARKING; PRE-FORMED THEMOPLASTIC (HIGH TRAFFIC VOLUME AREAS) (K) INSTALL GREEN PAVEMENT MARKING; EPOXY (LOW TRAFFIC VOLUME AREAS) PROPOSED SIGN LOCATION OF EX. SIGN TO BE REMOVED () REMOVE PAVEMENT MARKING DESIGNED BY: DHM III DATE: MAY, 2024 REVISION APP'D DATE DEPARTMENT OF TRANSPORTATION EXISTING SIGN LOCATION DRAWN BY: DHM III DATE: MAY, 2024 DIVISION OF TRANSPORTATION ENGINEERING MONTGOMERY COUNTY, MARYLAND CHECKED BY: SJZ DATE: MAY, 2024 DRAWING NO.: DATE RECOMMENDED FOR APPROVAL **Stantec** EAST SILVER SPRING Date Chief, Design Section NEIGHBORHOOD GREENWAY APPROVED SIGNING AND MARKING PLAN Chief, Division of Transportation Engineering SCALE: 1"=20"

Attachment A: Corridor Engineering Drawings (A) INSTALL 5 INCH YELLOW LEAD FREE THERMOPLASTIC PAVEMENT MARKING (DOUBLE) (B) INSTALL 5 INCH WHITE LEAD FREE THERMOPLASTIC PAVEMENT MARKING (SOLID) (C) INSTALL 5 INCH YELLOW LEAD FREE THERMOPLASTIC PAVEMENT MARKING (SOLID) (3-3-3 SKIP) INSTALL 5 INCH WHITE LEAD FREE THERMOPLASTIC PAVEMENT MARKING (3-3-3 SKIP) (E) INSTALL 16 INCH WHITE LEAD FREE THERMOPLASTIC PAVEMENT MARKING F) INSTALL 24 INCH WHITE LEAD FREE THERMOPLASTIC PAVEMENT MARKING (G) INSTALL WHITE PREFORMED THERMOPLASTIC PAVEMENT MARKING LEGENDS AND SYMBOLS (H) INSTALL BIKE SYMBOL WITH AN ARROW (I) INSTALL SHARROW | E 1305950 INSTALL GREEN PAVEMENT MARKING; PRE-FORMED THEMOPLASTIC (HIGH TRAFFIC VOLUME AREAS) (NSTALL GREEN PAVEMENT MARKING; EPOXY (LOW TRAFFIC VOLUME AREAS) E 1305950 | REMOVE PAVEMENT MARKING REMOVE SIGN REMOVE SIG RELOCATE SIGN RELOCATE SIGNS RELOCATE SIGN 9.0 SF TO SLIGO AVENUE TO BONIFANT STREET SN-02 SHEET SEE 103+00 GROVE STREET 104+00 105+00 8 101+(GROVE STREET STA. REMO<u>VE_SIGNS</u> EN EN REMOVE SIG BEMOVE SIGN E 1306170 APPROVED For SIGN(S) TO BE REMOVED BY OTHERS BY SIGN(S) TO BE INSTALLED BY OTHERS PROPOSED SIGN LOCATION OF EX. SIGN TO BE REMOVED DATE DESIGNED BY: DHM II DATE: MAY, 2024 NO. REVISION APP'D DATE DEPARTMENT OF TRANSPORTATION O EXISTING SIGN LOCATION DRAWN BY: DHM III DATE: MAY, 2024 DIVISION OF TRANSPORTATION ENGINEERING MONTGOMERY COUNTY, MARYLAND CHECKED BY: SJZ DATE: MAY, 2024 DATE DRAWING NO.: RECOMMENDED FOR APPROVAL **Stantec** EAST SILVER SPRING Date Chief, Design Section NEIGHBORHOOD GREENWAY

APPROVED

Chief, Division of Transportation Engineering

SIGNING AND MARKING PLAN

SCALE: 1"=20"

Attachment A: Corridor Engineering Drawings (A) INSTALL 5 INCH YELLOW LEAD FREE THERMOPLASTIC PAVEMENT MARKING (DOUBLE) (B) INSTALL 5 INCH WHITE LEAD FREE THERMOPLASTIC PAVEMENT MARKING (SOLID) (C) INSTALL 5 INCH YELLOW LEAD FREE THERMOPLASTIC PAVEMENT MARKING (SOLID) (3-3-3 SKIP) INSTALL 5 INCH WHITE LEAD FREE THERMOPLASTIC PAVEMENT MARKING (3-3-3 SKIP) (E) INSTALL 16 INCH WHITE LEAD FREE THERMOPLASTIC PAVEMENT MARKING F) INSTALL 24 INCH WHITE LEAD FREE THERMOPLASTIC PAVEMENT MARKING (G) INSTALL WHITE PREFORMED THERMOPLASTIC PAVEMENT MARKING LEGENDS AND SYMBOLS (H) INSTALL BIKE SYMBOL WITH AN ARROW (I) INSTALL SHARROW (HIGH TRAFFIC VOLUME AREAS) (NSTALL GREEN PAVEMENT MARKING; EPOXY (LOW TRAFFIC VOLUME AREAS) REMOVE PAVEMENT MARKING RELCATE SIGNS E 1306000 (40Ta E 1306000 | TO SUGO AVENUE SN-03 SHEET STOP) - B CONSTRUCTION LIMIT OF MILL . S SHEET TO BONIFANT STREET 109+00 +50 GROVE STREET GROVE STREET GROVE STREET STA B CONSTRUCTION -APPROVED E 1306180 For SIGNING NOTES SIGN(S) TO BE REMOVED BY OTHERS SIGN(S) TO BE INSTALLED BY OTHERS SIGN(S) TO BE RELOCATED BY OTHERS BY DATE: PROPOSED SIGN LOCATION OF EX. SIGN TO BE REMOVED SN-04 DESIGNED BY: DHM III DEPARTMENT OF TRANSPORTATION EXISTING SIGN LOCATION DRAWN BY: DHM III DATE: MAY, 2024 DIVISION OF TRANSPORTATION ENGINEERING MONTGOMERY COUNTY, MARYLAND CHECKED BY: SJZ DATE: MAY, 2024 DRAWING NO.: DATE: RECOMMENDED FOR APPROVAL

EAST SILVER SPRING

NEIGHBORHOOD GREENWAY

SIGNING AND MARKING PLAN

Date


SCALE: 1"=20"

Chief, Design Section

Chief, Division of Transportation Engineering

APPROVED

Stantec

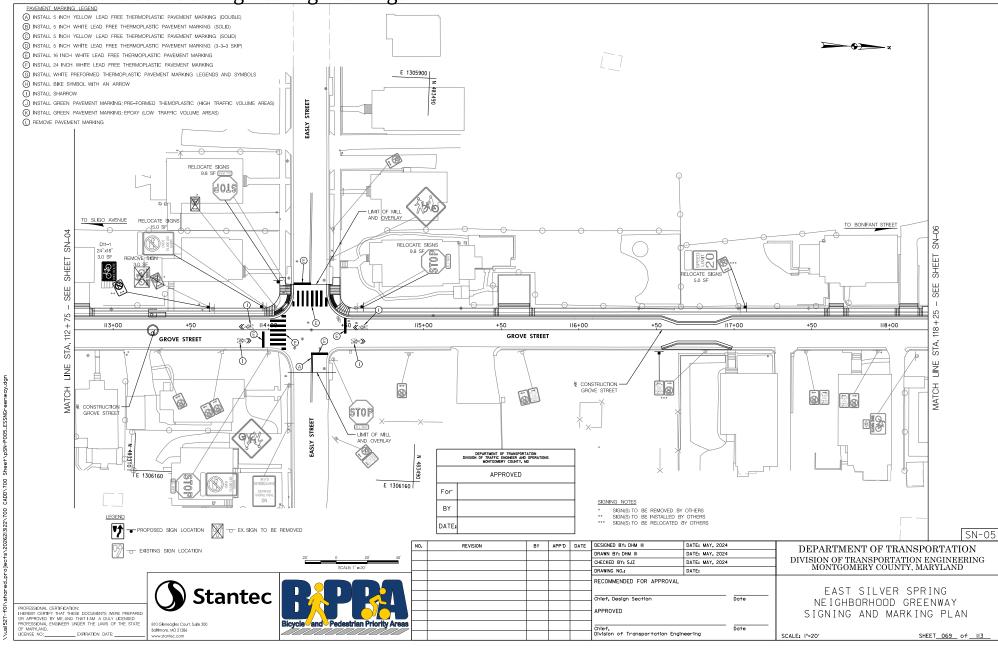

5/22/2024

Attachment A: Corridor Engineering Drawings (A) INSTALL 5 INCH YELLOW LEAD FREE THERMOPLASTIC PAVEMENT MARKING (DOUBLE) (B) INSTALL 5 INCH WHITE LEAD FREE THERMOPLASTIC PAVEMENT MARKING (SOLID) (C) INSTALL 5 INCH YELLOW LEAD FREE THERMOPLASTIC PAVEMENT MARKING (SOLID) (3-3-3 SKIP) (E) INSTALL 16 INCH WHITE LEAD FREE THERMOPLASTIC PAVEMENT MARKING F) INSTALL 24 INCH WHITE LEAD FREE THERMOPLASTIC PAVEMENT MARKING (G) INSTALL WHITE PREFORMED THERMOPLASTIC PAVEMENT MARKING LEGENDS AND SYMBOLS $\overset{-}{\textstyle \dot{\textstyle \, \boldsymbol{\Theta}}}$ install bike symbol with an arrow (I) INSTALL SHARROW (HIGH TRAFFIC VOLUME AREAS) (NSTALL GREEN PAVEMENT MARKING; EPOXY (LOW TRAFFIC VOLUME AREAS) REMOVE PAVEMENT MARKING TO FENTON STREET SONIFANT STREET STOP AND OVERLAY ********* **≪**₹ +50 BONIFANT STREET BONIFANT STREET ₽ CONSTRUCTION APPROVED For SIGNING NOTES SIGN(S) TO BE REMOVED BY OTHERS SIGN(S) TO BE INSTALLED BY OTHERS SIGN(S) TO BE RELOCATED BY OTHERS BY DATE: PROPOSED SIGN LOCATION OF EX. SIGN TO BE REMOVED DESIGNED BY: DHM III DATE: MAY, 2024 APP'D DATE NO. DEPARTMENT OF TRANSPORTATION The existing sign location DRAWN BY: DHM III DATE: MAY, 2024 DIVISION OF TRANSPORTATION ENGINEERING MONTGOMERY COUNTY, MARYLAND CHECKED BY: SJZ DATE: MAY, 2024 DRAWING NO.: DATE:

RECOMMENDED FOR APPROVAL **Stantec** EAST SILVER SPRING Chief, Design Section NEIGHBORHOOD GREENWAY APPROVED SIGNING AND MARKING PLAN Chief, Division of Transportation Engineering SHEET_070_ of_ II3_ SCALE: 1"=20"

Attachment A: Corridor Engineering Drawings PAVEMENT MARKING LEGEND (A) INSTALL 5 INCH YELLOW LEAD FREE THERMOPLASTIC PAVEMENT MARKING (DOUBLE) (B) INSTALL 5 INCH WHITE LEAD FREE THERMOPLASTIC PAVEMENT MARKING (SOLID) (C) INSTALL 5 INCH YELLOW LEAD FREE THERMOPLASTIC PAVEMENT MARKING (SOLID) (INSTALL 5 INCH WHITE LEAD EBEE THERMOPLASTIC PAVEMENT MARKING /3-3-3 SKIP) (E) INSTALL 16 INCH WHITE LEAD FREE THERMOPLASTIC PAVEMENT MARKING (F) INSTALL 24 INCH WHITE LEAD FREE THERMOPLASTIC PAVEMENT MARKING (G) INSTALL WHITE PREFORMED THERMOPLASTIC PAVEMENT MARKING LEGENDS AND SYMBOLS (H) INSTALL BIKE SYMBOL WITH AN ARROW (J) INSTALL GREEN PAVEMENT MARKING; PRE-FORMED THEMOPLASTIC (HIGH TRAFFIC VOLUME AREAS) (K) INSTALL GREEN PAVEMENT MARKING; EPOXY (LOW TRAFFIC VOLUME AREAS) (L) REMOVE PAVEMENT MARKING € CONSTRUCTION HOUSTON STREET CEDAR STREET 53+00 CEDAR STREET STA. LIMIT OF MILL AND OVERLAY - B CONSTRUCTION APPROVED For BY DATE: SIGN(S) TO BE REMOVED BY OTHERS SIGN(S) TO BE INSTALLED BY OTHERS SIGN(S) TO BE RELOCATED BY OTHERS PROPOSED SIGN LOCATION OF EX. SIGN TO BE REMOVED LIMIT OF MILL AND OVERLAY SN-07 NO. DESIGNED BY: DHM II DATE: MAY, 2024 DEPARTMENT OF TRANSPORTATION O EXISTING SIGN LOCATION DRAWN BY: DHM III DATE: MAY, 2024 DIVISION OF TRANSPORTATION ENGINEERING MONTGOMERY COUNTY, MARYLAND CHECKED BY: SJZ DATE: MAY, 2024 DRAWING NO.: RECOMMENDED FOR APPROVAL **Stantec** EAST SILVER SPRING Chief, Design Section NEIGHBORHOOD GREENWAY APPROVED SIGNING AND MARKING PLAN Chief, Division of Transportation Engineering EXPIRATION DATE: SHEET_07I_ of __II3 SCALE: 1"=20"

Attachment A: Corridor Engineering Drawings (A) INSTALL 5 INCH YELLOW LEAD FREE THERMOPLASTIC PAVEMENT MARKING (DOUBLE) (B) INSTALL 5 INCH WHITE LEAD FREE THERMOPLASTIC PAVEMENT MARKING (SOLID) (C) INSTALL 5 INCH YELLOW LEAD FREE THERMOPLASTIC PAVEMENT MARKING (SOLID) (3-3-3 SKIP) (E) INSTALL 16 INCH WHITE LEAD FREE THERMOPLASTIC PAVEMENT MARKING F) INSTALL 24 INCH WHITE LEAD FREE THERMOPLASTIC PAVEMENT MARKING (G) INSTALL WHITE PREFORMED THERMOPLASTIC PAVEMENT MARKING LEGENDS AND SYMBOLS H INSTALL BIKE SYMBOL WITH AN ARROW ① INSTALL GREEN PAVEMENT MARKING; PRE-FORMED THEMOPLASTIC (HIGH TRAFFIC VOLUME AREAS) (NSTALL GREEN PAVEMENT MARKING; EPOXY (LOW TRAFFIC VOLUME AREAS) REMOVE PAVEMENT MARKING AND OVERLAY TO BONIFANT STREET CEDAR STREET CEDAR STREET ■ CONSTRUCTION — RELOGATE SIGN 5.0 SF APPROVED SIGNING NOTES SIGN(S) TO BE REMOVED BY OTHERS SIGN(S) TO BE INSTALLED BY OTHERS SIGN(S) TO BE RELOCATED BY OTHERS DATE: PROPOSED SIGN LOCATION OF EX. SIGN TO BE REMOVED DESIGNED BY: DHM II APP'D DATE DEPARTMENT OF TRANSPORTATION EXISTING SIGN LOCATION DRAWN BY: DHM III DATE: MAY, 2024 DIVISION OF TRANSPORTATION ENGINEERING MONTGOMERY COUNTY, MARYLAND CHECKED BY: SJZ DATE: MAY, 2024 DRAWING NO.: DATE: RECOMMENDED FOR APPROVAL **Stantec** EAST SILVER SPRING Chief, Design Section NEIGHBORHOOD GREENWAY APPROVED SIGNING AND MARKING PLAN Chief, Division of Transportation Engineering SHEET_072_ of __II3_ SCALE: 1"=20"

Attachment A: Corridor Engineering Drawings (A) INSTALL 5 INCH YELLOW LEAD FREE THERMOPLASTIC PAVEMENT MARKING (DOUBLE) (B) INSTALL 5 INCH WHITE LEAD FREE THERMOPLASTIC PAVEMENT MARKING (SOLID) (C) INSTALL 5 INCH YELLOW LEAD FREE THERMOPLASTIC PAVEMENT MARKING (SOLID) (D) INSTALL 5 INCH WHITE LEAD FREE THERMOPLASTIC PAVEMENT MARKING (3-3-3 SKIP) (E) INSTALL 16 INCH WHITE LEAD FREE THERMOPLASTIC PAVEMENT MARKING F) INSTALL 24 INCH WHITE LEAD FREE THERMOPLASTIC PAVEMENT MARKING (G) INSTALL WHITE PREFORMED THERMOPLASTIC PAVEMENT MARKING LEGENDS AND SYMBOLS $\overset{-}{\textstyle \dot{\textstyle \, \boldsymbol{\Theta}}}$ install bike symbol with an arrow (I) INSTALL SHARROW (HIGH TRAFFIC VOLUME AREAS) (NSTALL GREEN PAVEMENT MARKING; EPOXY (LOW TRAFFIC VOLUME AREAS) REMOVE PAVEMENT MARKING EASLEY STREET LE 1306500 36" x36" 9.0 SF E 1306500 REMOVE SIGN RELOCATE SIGNS SN-**40T**§ LIMIT OF MILL -SHEET TO BONIFANT STREET AND OVERLAY SEE 200+00 201+00 +50 202+00 +50 203+00 +50 HOUSTON STREET HOUSTON STREET STA. EINE HOUSTON STREET LIMIT OF MILL -AND OVERLAY E 1306650 - UMIT OF MILL APPROVED For SIGNING NOTES BY SIGN(S) TO BE REMOVED BY OTHERS SIGN(S) TO BE INSTALLED BY OTHERS SIGN(S) TO BE RELOCATED BY OTHERS DATE PROPOSED SIGN LOCATION OF EX. SIGN TO BE REMOVED SN-09 DESIGNED BY: DHM III APP'D DATE DEPARTMENT OF TRANSPORTATION EXISTING SIGN LOCATION DRAWN BY: DHM III DATE: MAY, 2024 DIVISION OF TRANSPORTATION ENGINEERING MONTGOMERY COUNTY, MARYLAND CHECKED BY: SJZ DATE: MAY, 2024 DRAWING NO.: DATE: RECOMMENDED FOR APPROVAL Stantec EAST SILVER SPRING Date Chief, Design Section NEIGHBORHOOD GREENWAY APPROVED SIGNING AND MARKING PLAN Chief, Division of Transportation Engineering SHEET_073_ of_ II3_ SCALE: 1"=20"

Attachment A: Corridor Engineering Drawings (A) INSTALL 5 INCH YELLOW LEAD FREE THERMOPLASTIC PAVEMENT MARKING (DOUBLE) (B) INSTALL 5 INCH WHITE LEAD FREE THERMOPLASTIC PAVEMENT MARKING (SOLID) (C) INSTALL 5 INCH YELLOW LEAD FREE THERMOPLASTIC PAVEMENT MARKING (SOLID) (3-3-3 SKIP) INSTALL 5 INCH WHITE LEAD FREE THERMOPLASTIC PAVEMENT MARKING (3-3-3 SKIP) (E) INSTALL 16 INCH WHITE LEAD FREE THERMOPLASTIC PAVEMENT MARKING F) INSTALL 24 INCH WHITE LEAD FREE THERMOPLASTIC PAVEMENT MARKING (G) INSTALL WHITE PREFORMED THERMOPLASTIC PAVEMENT MARKING LEGENDS AND SYMBOLS | E 1306450 $\overset{-}{\textstyle \dot{\textstyle \, \boldsymbol{\Theta}}}$ install bike symbol with an arrow E 1306450 J (I) INSTALL SHARROW INSTALL GREEN PAVEMENT MARKING; PRE-FORMED THEMOPLASTIC (HIGH TRAFFIC VOLUME AREAS) (NSTALL GREEN PAVEMENT MARKING; EPOXY (LOW TRAFFIC VOLUME AREAS) REMOVE PAVEMENT MARKING LIMIT OF MILL (40T8) 60-NS TO SLIGO AVENUE TO BONIFANT STREET SN SHEET SEE 20 206+00 207+00 HOUSTON STREET HOUSTON STREET STA € CONSTRUCTION HOUSTON STREET CONSTRUCTION HOUSTON STREET E 1306650 DEPARTMENT OF TRANSPORTATION DIVISION OF TRAFFIC ENGINEER AND OPERATIONS MONTGOMERY COUNTY, MD APPROVED For BY DATE: SIGN(S) TO BE REMOVED BY OTHERS SIGN(S) TO BE INSTALLED BY OTHERS SIGN(S) TO BE RELOCATED BY OTHERS PROPOSED SIGN LOCATION OF EX. SIGN TO BE REMOVED SN-10 DESIGNED BY: DHM III REVISION APP'D DATE DEPARTMENT OF TRANSPORTATION EXISTING SIGN LOCATION DRAWN BY: DHM III DATE: MAY, 2024 DIVISION OF TRANSPORTATION ENGINEERING MONTGOMERY COUNTY, MARYLAND CHECKED BY: SJZ DATE: MAY, 2024 DRAWING NO.: DATE: RECOMMENDED FOR APPROVAL Stantec EAST SILVER SPRING Date Chief, Design Section NEIGHBORHOOD GREENWAY APPROVED SIGNING AND MARKING PLAN Chief, Division of Transportation Engineering SHEET_074_ of __II3_ SCALE: 1"=20"

SIGN	I	CODE NUMBERS •																		
NO.	REMARKS	1	2	3	4	5	6	7	8	9	10	- U	12	13	14	15	16	17	18	19
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SN-02																				
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16								

	DEPARTMENT OF TRANSPORTATION DIVISION OF TRAFFIC ENGINEER AND OPERATIONS MONTGOMERY COUNTY, MD
	APPROVED
For	
BY	
DATE:	

Stantec

APP'D DATE DESIGNED BY: DHM III DRAWN BY: DHM III DATE: MAY, 2024 CHECKED BY: SJZ DATE: MAY, 2024 DATE: DRAWING NO.: RECOMMENDED FOR APPROVAL Chief, Design Section APPROVED Chief, Division of Transportation Engineering

EAST SILVER SPRING NEIGHBORHOOD GREENWAY SIGNING AND MARKING DETAILS

DEPARTMENT OF TRANSPORTATION

DIVISION OF TRANSPORTATION ENGINEERING MONTGOMERY COUNTY, MARYLAND

SHEET_075_ of __II3_ SCALE: NONE



CONSTRUCTION DETAILS

INSTALL CONCRETE FOUNDATION WITH A 21 FT.MONTGOMERY COUNTY SPECIAL MAST ARM POLE. 18 FOOT MAST ARM WITH SIGNAL HEADS, SIGNS, PEDESTRIAN SIGNALS.AUDIBLE TACTILE PUSHBUTTON AND SIGN. (NOTE: ONE 3 IN. PVC SCHEDULE 80 CONDUIT BENDS). INSTALL A NEWA SIZE "6" BASE MOUNTED CONTROLLER AND CABINET WITH ALL NECESSARY EQUIPMENT. AN UNINTERRUPTED POWER SUPPLY (UPS.) WITH BATTERY BACK IND SUAL BE DICKY BACKET OF THE PLENT SIDE OF THE

UP SHALL BE PIGGY BACKED TO THE RIGHT SIDE OF THE CABINET (NOTE: TWO-4 IN. PVC, ONE-3 IN. AND TWO-2 IN. PVC SCHEDULE 80 CONDUIT BENDS).

INSTALL EMBEDDED METERED SERVICE PEDESTAL(200 AMPS).
(NOTE: INSTALL 1-2 IN. AND 1-4 IN. 90 33/64 CONDUIT BENDS).
INSTALL 4 IN. PVC SCHEDULE 40 ELECTRICAL CONDUIT FOR ELECTRICAL SERVICE - BORED. STUB OUT COUNDUIT BEND AT BASE OF UTILITY POLE.

E. INSTALL 3 IN. PVC. SCHEDULE 80 ELECTRICAL

CONDUIT - TRENCHED

F. INSTALL 4 IN. PVC SCHEDULE 80 ELECTRICAL
CONDUIT - TRENCHED.


G. INSTALL 4 IN. PVC SCHEDULE 80 ELECTRICAL CONDUIT - SLOTTED.
H. INSTALL 2 IN. PVC SCHEDULE 80 ELECTRICAL CONDUIT - TRENCHED.

I. INSTALL HANDHOLE.

1. INSTALL HANDHOLE.

J. INSTALL 10' PEDESTAL POLE (MD 818.16-01). WITH BREAKAWAY COUPLINGS MODIFIED BASE (MD 801.01-01). COUNTDOWN PEDESTRIAN SIGNALS. AUDIBLE TACTILE PUSHBUTTON AND SIGN. (NOTE: ONE 2 IN. PVC SCHEDULE 80 CONDUIT BEND).

K. SIGNAL CONTRACTOR SHALL BE RESPONSIBLE FOR INSTALLING STOP BARS.

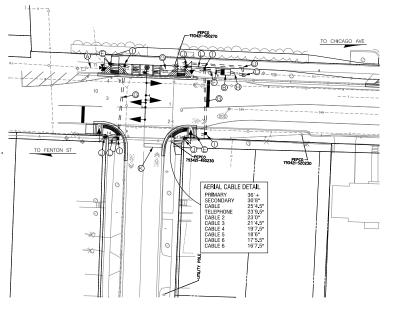

PROPOSED BLACK-FACED





NOTE: TRAFFIC SIGNAL HEADS SHALL HAVE BACK PLATES

PROPOSED SIGNS





PHASING

-1 kg

GEOMETRIC LEGEND _ _ _ FXISTING

UTILITY LEGEND									
——SD——SD—— STORM DRAIN									
— G — G — GAS MAIN									
──₩──₩── WATER MAIN									
— S — S — SEWER MAIN									
— E — E — ELECTRIC CABLES									
—— A —— A ERIAL CABLES									
— T — T — TELEPHONE CABLES									
F F E IRED_ODTIC									

PROFESSIONAL CERTIFICATION:
INFRIESY CERTIFY THAT THESE DOCUMENTS WERE PREPARED
OR APPROVED BY ME, AND THAT THAT A DLLY LICENSED
PROFESSIONAL BROINGER UNDER THE LAWS OF THE STATE
OF MAPPLAND.
LICENSE NO. EXPRATION DATE:

Stantec

	SCALE: 1" = 20"
•	Bloycle and Pedestrian Priority Areas

	NO.	REVISION	BY	APP'D	DATE	DESIGNED BY: JM	DATE: MAY, 2024	
0 20' 40'						DRAWN BY: JM	DATE: MAY, 2024	
						CHECKED BY: RJM	DATE: MAY, 2024	
SCALE: 1" = 20"						DRAWING NO.:	DATE:	
DE LA sadestrian Priority Areas						RECOMMENDED FOR APPROVAL Chief, Design Section APPROVED Chief.		Date Date
		•				Division of Transportation Engin	eering	

SG-01

DEPARTMENT OF TRANSPORTATION DIVISION OF TRANSPORTATION ENGINEERING MONTGOMERY COUNTY, MARYLAND

EAST SILVER SPRING NEIGHBORHOOD GREENWAY TRAFFIC SIGNAL PLAN SLIGO AVENUE AT WOODBURY DRIVE

SCALE: 1"=20" SHEET 076 of II3

I. GENERAL

THIS PROJECT INVOLVES THE INSTALLATION OF A PEDESTRIAN HYBRID BEACON AT THE INTERSECTION OF SLIGO AVENUE AND WOODBURY DRIVE IN MONTGOMERY COUNTY. SLIGO AVENUE IS ASSUMED TO RUN IN A EAST-WEST DIRECTION.

II. INTERSECTION OPERATION

- THE INTERSECTION SHALL OPERATE AS A PEDESTRIAN HYBIRD BEACON. DURING "NORMAL DYPERATION" THE SIGNAL SHALL BE DARK. PRORACHES SHALL OF OTO A FLASHING YELLOW FOLLOWED BY A SOLID YELLOW THEN ALL RED MODE. THE RED MODE SHALL REMAIN OPERATIONAL FOR THE DURATION OF THE PROPERTY OF THE SHALL BE SOUTH LEE OF FENTON STREET, GIST AVENUE SHALL BE CONTROLLED BY A "STOP" SIGN.
- A FULL-TRAFFIC ACTUATED. EIGHT PHASE CONTROLLER WITH ALL NECESSARY EQUIPMENT HOUSED IN A NEWA SIZE "6" BASE-MOUNTED CABINET SHALL BE INSTALLED AT THIS INTERSECTION. A UPS BATTERY BACK UP SYSTEM SHALL BE ATTACHED TO THE RIGHT SIDE OF THE CABINET.
- MONTGOMERY COUNTY SIGNAL SHOP SHALL INSTALL APS CONTROL UNIT INTO CONTROLLER CABINET. THE CONTRACTOR SHALL DELIVER THE APS PUSHBUTTONS TO THE MONTGOMERY COUNTY SIGNAL SHOP FOR TESTING AND PROGRAMMING AT LEAST TWO WEEKS PRIOR TO THE BEGINNING OF WORKE

III. SPECIAL NOTES

- THE CONTRACTOR SHALL BE RESPONSIBLE FOR TERMINATING ALL SIGNAL CABLES TO THE APPROPRIATE TERMINALS AND SHALL PROPERLY LABEL EACH CABLE.
- ALL UNDERGROUND AND OWERHEAD UIT, LITTLES SHOWN ON THESE PLANS ONE SCHEMATIC ONLY AND MAY NOT BE COMPLETE. THE CONTRACTOR SHALL BE RESPONSIBLE FOR NOTIFYING WISS UTILITY PRIOR TO CONSTRUCTION SO THAT ALL UTILITIES MAY BE LOCATED IN THE FIELD. IF THE CONTRACTOR PERCEIVES THAT A CONFLICT BETWEEN THE UTILITIES AND THE TRAFFIC STOWN. WILL COUR. THE CONTRACTOR SHALL NOTIFY THE PROJECT ENGINEER IMMEDIATELY STATE OF THE CONTRACTOR SHALL NOTIFY THE PROJECT ENGINEER IMMEDIATELY SHALL SHALL NOTIFY THE PROJECT ENGINEER IMMEDIATELY SHALL NOTIFY THE PROJECT ENGINEER IMMEDIATELY SHALL SHAL

TO CROSS SLIGO AVENUE

- A. WHEN PEDESTRIAN LOCATES AND PRESSES THE PUSHBUTTON FOR AN EXTENDED TIME. THE PUSHBUTTON UNIT WILL ANNOUNCE THE FOLLOWING MESSAGE "WAIT TO CROSS SLIGO AT WOODSDURY."
- B. WHEN THE WALK PHASE BEGINS. THE PUSHBUTTON UNIT WILL PROVIDE A RAPID TICK WHICH WILL LAST FOR THE DURATION OF THE WALK PHASE.

TO CROSS WOODBURY DRIVE

A. WOODBURY DRIVE WILL REMAIN AN UNCONTROLLED CROSSING.

PROJECT CONTACT LIST

OUTS CONTACTS:

MS. REBECCA LICHTENSTEIN, P.E. CHIEF TRAFFIC OPERATION DIVISION PHONE: (410)-787-7630

ASSISTANT DIVISION CHIEF. TRAFFIC OPERATIONS DIVISION PHONE: (410)-787-7625

CHIEF. WAREHOUSE SECTION PHONE: (410)-787-7668

MR. DAVID "TODD" JONES SIGN SHOP MANAGER 410-787-7676

PEPCO

MR. PAUL WILSON PHONE 202-833-7500

DISTRICT 3

MR. JOSEPH MOGES ASSISTANT DISTRICT ENGINEER - TRAFFIC 301-513-7498

MR. MARK LOEFFLER DISTRICT ENGINEER - UTILITIES 301-513-7350

MR. JOHN GOVER ASSISTANT DISTRICT ENGINEER - CONSTRUCTION 301-513-7336

MR. GREGORY EDWARDS ASSISTANT DISTRICT ENGINEER - MAINTENANCE 301-513-7304

MONTGOMERY COUNTY

MR. KAMAL HAMUD MONTGOMERY COUNTY-TRAFFIC ENGINEERING PHONE NUMBER 240-777-8761

EQUIPMENT LIST

A. FOLIPMENT TO BE FURNISHED BY STATE HIGHWAY ADMINISTRATIONS

ITEM NO. / OHANTITY DESCRIPTION CAT CODE

B. EQUIPMENT TO BE FURNISHED AND/OR INSTALLED BY CONTRACTOR:

ITEM NO./ CAT CODE OHANTITY DESCRIPTION

C. EQUIPMENT TO BE REMOVED AND RETURNED TO SHA:

MAINTENANCE OF TRAFFIC NOTE


NO.


IF THE CABINET IS TO BE REMOVED SHA FORCES SHALL REMOVE THE CONTROLLER AND ALL AUXILIARY EQUIPMENT FROM THE CONTROLLER
CABINET. THE CABINET AND ALL OTHER MATERIALS TO BE REMOVED BY THE CONTRACTOR SHALL BECOME THE PROPERTY OF THE CONTRACTOR.

MAINTENANCE OF TRAFFIC WILL BE HANDLED BY THE CONTRACTOR UTILIZING THE FOLLOWING STANDARD PLATES FOR TRAFFIC CONTROL:

ADDITIONAL TRAFFIC CONTROL STANDARDS MAY BE USED AS DIRECTED BY THE ENGINEER.

REVISION

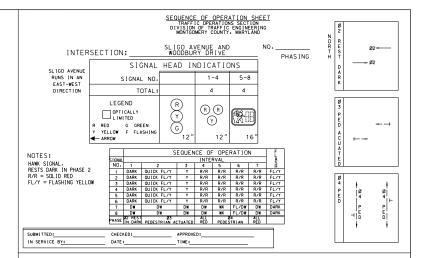

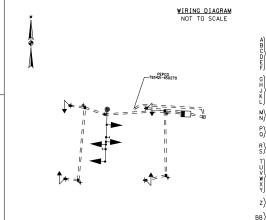

7 CONDUCTOR ELECTRICAL CABLE (NO. 14 AWG)

5 CONDUCTOR ELECTRICAL CABLE (NO. 14 AWG)

3 CONDUCTOR ELECTRICAL CABLE (NO. 14 AWG)

2 CONDUCTOR ELECTRICAL CABLE (NO. 14 AWG)

VIDEO DETECTION CABLE

1 CONDUCTOR (NO. 6 AWG) STRANDED COPPER GROUND WIRE

50 PAIR INTERCONNECT CABLE POWER SERVICE UNDERGROUND 3 WIRE 1 CONDUCTOR (NO. 4 AWG)

GROUND ROD

DRAWN BY: JM DATE: MAY, 2024 HECKED BY: RJM DATE: MAY, 2024 DRAWING NO.: DATE: RECOMMENDED FOR APPROVAL Chief, Design Section Date APPROVED Date Chief, Division of Transportation Engineering

APP'D DATE

DESIGNED BY: JM

DEPARTMENT OF TRANSPORTATION DIVISION OF TRANSPORTATION ENGINEERING

EAST SILVER SPRING NEIGHBORHOOD GREENWAY GENERAL INFORMATION SHEET SLIGO AVENUE AT WOODBURY DRIVE SHEET 077 of II3 SCALE: NTS



PROFESSIONAL CERTIFICATION:
IHERBRY CERTIFY THAT THESE DOCUMENTS WERE PREPARED
OR APPROVED BY ME, AND THAT I AM A DULY LICENSED
PROFESSIONAL ENGINEER UNDER THE LAWS OF THE STATE
OF MARTIAND.

LICENSE NO:

EXPRATION DATE:

GENERAL NOTES:

THE LOCATIONS OF THE UTILITIES SHOWN ON THESE DRAWINGS ARE BASED ON FIELD OBSERVATION AND/OR RECORD DRAWINGS. THE INFORMATION SHOWN IS NOT NECESSARILY COMPLETE AND THE LOCATION OF THE UTILITIES SHOWN IS APPROXIMATE. THE CONTRACTOR WILL VERIFY THE EXISTENCE OF ALL UTILITIES IN ADVANCE OF CONDUCTING CONSTRUCTION OPERATIONS THAT COULD DAMAGE THESE UTILITIES.

2. IN THE AREAS WHERE PROPOSED CONSTRUCTION MAY CONFLICT WITH EXISTING UTILITIES, THE CONTRACTOR WILL TAKE ALL NECESSARY PRECAUTIONS TO AVOID DAMAGE TO THESE UTILITIES.

A. IF AN UNDERGROUND UTILITY IS DAMAGED, THE CONTRACTOR WILL IMMEDIATELY NOTIFY THE DISTRICT AND THE OWNER OF THE UTILITY. ANY DAMAGE SUSTAINED TO UTILITIES ABOVE OR BELOW GROUND WILL BE REPAIRED BY THE CONTRACTOR UNDER THE DIRECTION OF THE UTILITY OWNER AT THE CONTRACTOR'S EXPENSE UNDER NO CIRCUMSTANCE WILL THE CONTRACTOR'S EXPENSE. UNDER NO AFFECTING SAID UTILITY WITHOUT FIRST RECEIVING PERMASSION FROM THE UTILITY OWNER.

4. THE CONTRACTOR WILL NOTIFY THE FOLLOWING PARTIES AT LEAST FORTY EIGHT (48) HOURS, BUT NOT MORE THAN TEN (10) WORKING DAYS IN ADVANCE OF PROCEEDING WITH ANY EXCAVATION WORK:

NOTIFY AGENCIES

GAS, TELEPHONE, ELECTRICAL, CONDUIT & CABLE TV

(800-257-7777)

WATER MAIN & SEWERS

WASHINGTON SUBURBAN SANITARY COMMISSION (301-206-7342)

5. SOME STREETLIGHT FOUNDATIONS SHOWN ON THE PLANS WILL BE REPLACED OR REMOVED. ALL EXISTING STREETLIGHT CONDUITS TO BE ABANDONED WILL BE SEALED WITH CONCRETE BEFORE INSTALLING THE NEW FOUNDATION OR BACKFILLING, REMOVE THE CONCRETE FOUNDATION COMPLETELY, SUCH AS ANCHOR BOLTS, CONDUITS, CABLE AND ALL OTHER ASSOCIATED DEVICES.

6. WHERE A STREETLIGHT IS REPLACED IN THE SAME LOCATION, THE LIGHT WILL BE RESTORED WITHIN 5 WORKING DAYS. ALL LIGHTS WITHIN THE PROJECT LIMIT ARE THE CONTRACTOR'S RESPONSIBILITY TO REPAIR IN A TIMELY MANNER (WITHIN FORTY-EIGHT HOURS) FROM THE UNIT LITHE PROJECT IS ACCEPTED BY THE MONTGOMERY COUNTY

7. THE CONTRACTOR WILL KEEP PROPER RECORD OF ALL TRAFFIC AND PARKING SIGNS THAT WILL BE REMOVED PRIOR TO REMOVING THE STREETLIGHT POLE. THE SIGNS SHALL BE RELOCATED TO THE NEW POLE AT THE SAME HEIGHT AND ORIENTATION. A U-POST SHALL BE INSTALLED TO MOUNT THE REPLACED SIGN IF A PROPOSED NEW POLE HAS A DIFFERENT LOCATION.

8. ALL POLE FOUNDATIONS WILL BE INSTALLED 3'FROM FACE OF CURB TO CENTER OF FOUNDATION UNLESS NOTED ON THE PLANS OR DIRECTED BY THE ENGINEER.

9. THE CONTRACTOR SHALL BE RESPONSIBLE TO FIELD CHECK FOR ALL EXISTING LOCATIONS AND MAKE NECESSARY ADJUSTMENTS TO ACCOMMODATE THE NEW WORK AT NO ADDITIONAL COST TO THE MONTGOMERY COUNTY GOVERNMENT.

LEGEND:

● ★> EXISTING WOOD POLE TO REMAIN WITH LUMINAIRE TO BE REMOVED

■ FXISTING WOOD POLE TO REMAIN

EXISTING WASHINGTON GLOBE STREETLIGHT POLE

PROPOSED PENDANT POLE WITH LUMINAIRE

TRAFFIC SIGNAL LIGHT POLE

EXISTING ELECTRICAL HAND BOX

PROPOSED ELECTRICAL HAND BOX

© EXISTING ELECTRICAL MANHOLE

© EXISTING GAS MANHOLE

EXISTING GAS VALVE

B EXISTING CATCH BASIN

@ EXISTING STORM DRAINAGE MANHOLE

S EXISTING SANITARY SEWER MANHOLE

EXISTING WATER MANHOLE

M EXISTING WATER VALVE

FXISTING FIRE HYDRANT

NO.

REVISION

■ EXISTING UNIDENTIFIED MANHOLE

-------- EXISTING GAS LINE ----- EXISTING WATER LINE

ABBREVIATION LIST:

HPS HIGH PRESSURE SODIUM VAPOR

RXX EXISTING STREETLIGHT LUMINAIRE TO BE REMOVED LXX

STREETLIGHT LUMINAIRE TO BE INSTALLED

PP PENDANT POLE

нвх ELECTRICAL HAND BOX

ETR EXISTING TO REMAIN

> LT-01 DEPARTMENT OF TRANSPORTATION



Precision Systems, Inc.

WASHINGTON, D.C. (202) 686-8225 www.dcpsi.com

PROFESSIONAL CERTIFICATION:

HERRERY CERTIFY THAT THESE DOCUMENTS. WERE PREPARED

OR APPROVED BY ME, AND THAT I AM. A DULY LICENSED

PROFESSIONAL ENGINEER UNDER THE LAWS OF THE STATE

OF MARYLAND.

LICENSE NO:

EXPRATION DATE:







[DRAWN BY:SF	DATE: MAY, 2024						
ŀ				CHECKED BY:AYY	DATE: MAY, 2024		DIVISION OF TRANSPORTATION ENGINEERING				
_	_			DRAWING NO.:	DATE:		MONTGOMERY COUNTY, MARYLAND				
.				RECOMMENDED FOR APPROVAL							
ΝI											
M				Chief, Design Section	Date		EAST SILVER SPRING				
M				Criter, Design Section	Dute		NEIGHBORHOOD GREENWAY				
N				APPROVED							
_	_						STREETLIGHT LEGEND AND GENERAL NO	11F2			
88				Chief,	Date						
				Division of Transportation Engineering	9		SCALE: NTS SHEET 78 of _	113			


BY APP'D DATE DESIGNED BY:SF

Attachment A: Corridor Engineering Drawings E 1305750 STA. 16+25 +50 WOODBURY DRIVE 14+00 WOODBURY DRIVE DESIGNED BY:SF DEPARTMENT OF TRANSPORTATION DRAWN BY:SF DATE: MAY, 2024 DIVISION OF TRANSPORTATION ENGINEERING MONTGOMERY COUNTY, MARYLAND CHECKED BY:AYY DATE: MAY, 2024 DRAWING NO: Precision Systems, Inc.
Engineers, Planners and Architects RECOMMENDED FOR APPROVAL **Stantec** WASHINGTON, D.C. (202) 686-8225 www.dcpsi.com EAST SILVER SPRING Chief, Design Section NEIGHBORHOOD GREENWAY APPROVED STREETLIGHT PLAN Chief, Division of Transportation Engineering SHEET 79 of 113 SCALE: 1"-20"

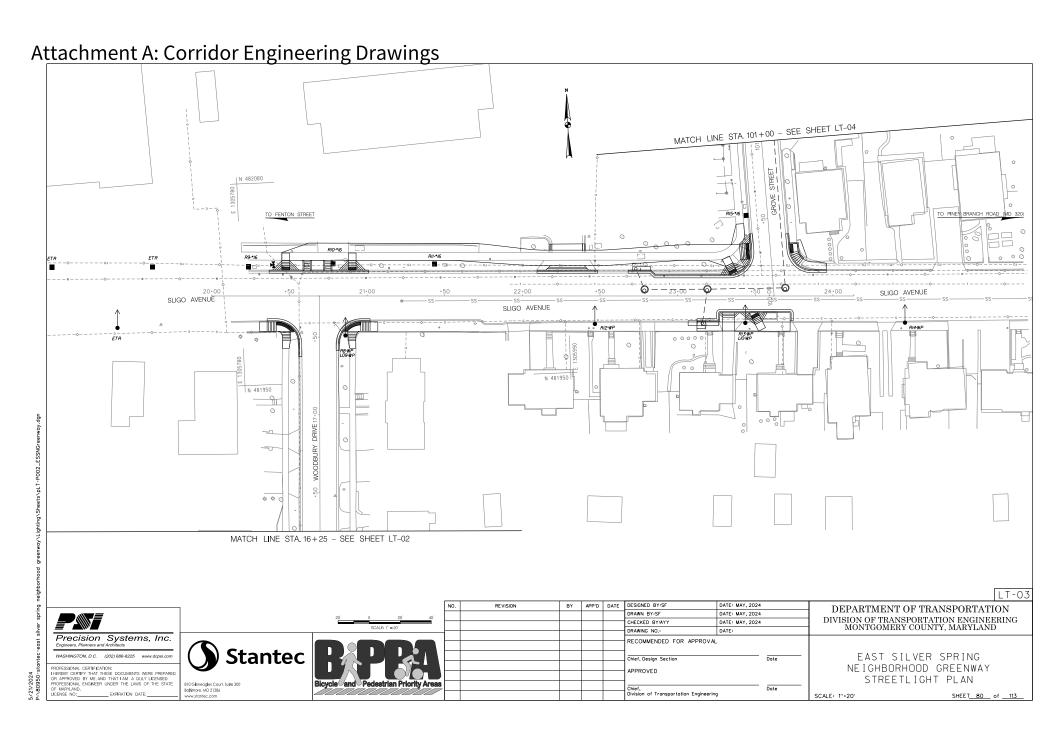

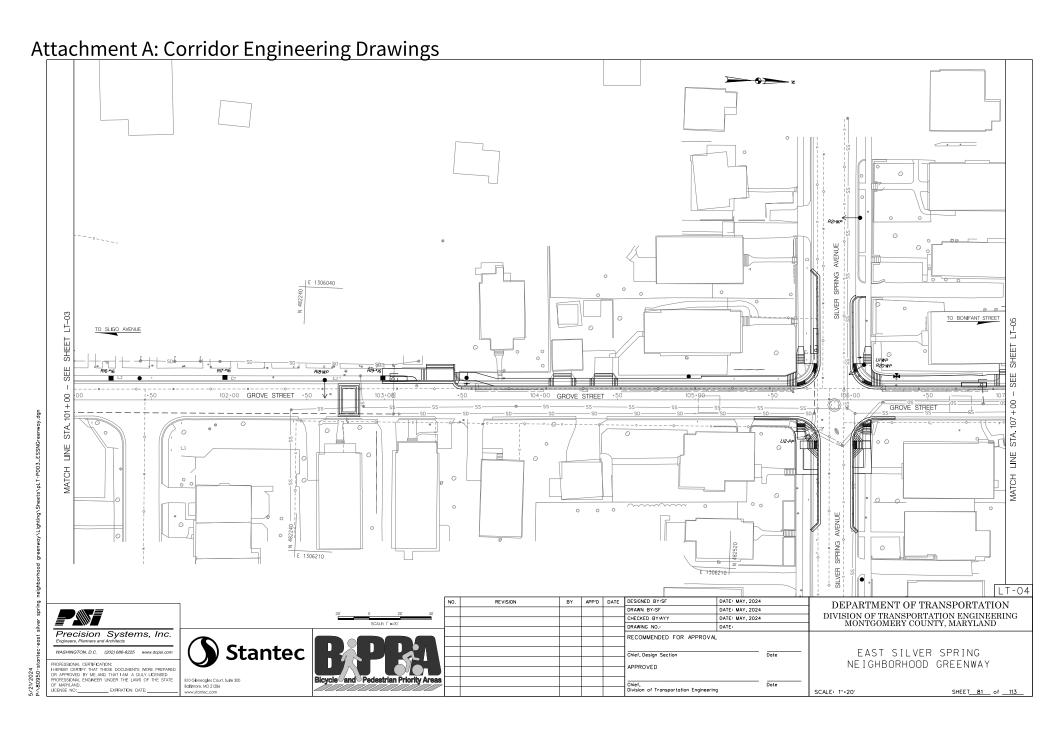

Attachment A: Corridor Engineering Drawings 00 9E 1306000 SEE SHEET TO BONIFANT STR GROVE STREET 50 SGROVE STREET LT-05 DEPARTMENT OF TRANSPORTATION DRAWN BY:SF DATE: MAY, 2024 DIVISION OF TRANSPORTATION ENGINEERING MONTGOMERY COUNTY, MARYLAND CHECKED BY:AYY DATE: MAY, 2024 DRAWING NO: Precision Systems, Inc.
Engineers, Planners and Architects RECOMMENDED FOR APPROVAL **Stantec** WASHINGTON, D.C. (202) 686-8225 www.dcpsi.com EAST SILVER SPRING Date Chief, Design Section NEIGHBORHOOD GREENWAY STREETLIGHT PLAN Chief, Division of Transportation Engineering SHEET_ 82_ of __113_ SCALE: 1"-20"

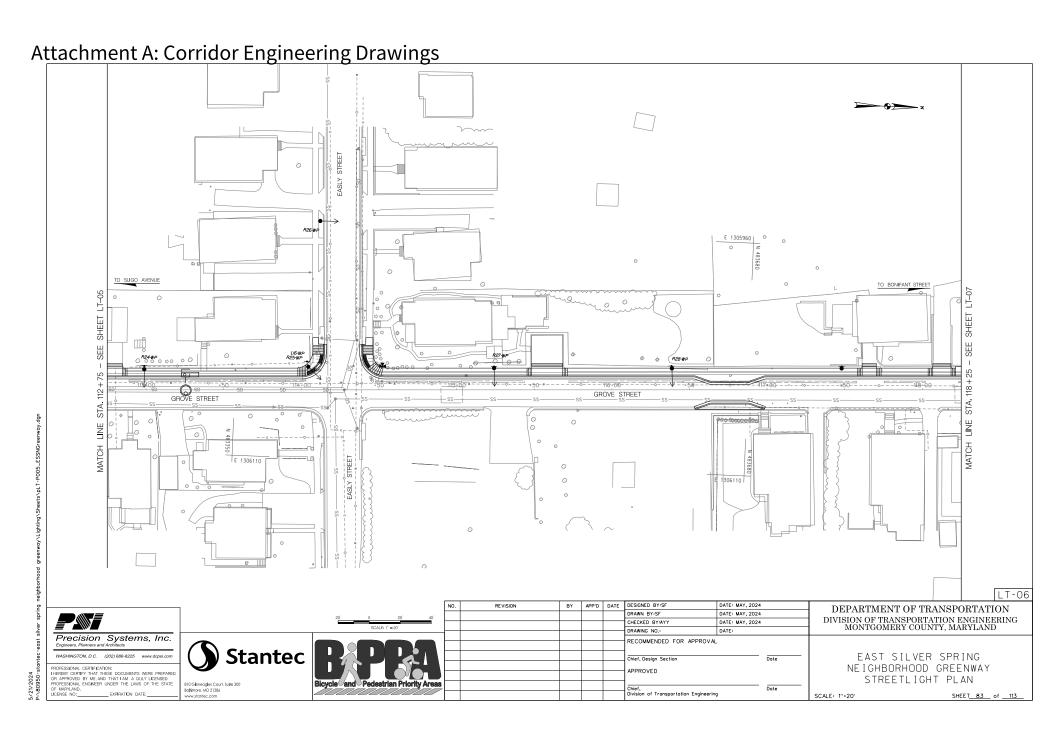

Attachment A: Corridor Engineering Drawings TO FENTON STREET LI9-PP BONIFANT STREET BONIFANT STREET DESIGNED BY:SF DEPARTMENT OF TRANSPORTATION DRAWN BY:SF DATE: MAY, 2024 DIVISION OF TRANSPORTATION ENGINEERING MONTGOMERY COUNTY, MARYLAND CHECKED BY:AYY DATE: MAY, 2024 DRAWING NO: Precision Systems, Inc.
Engineers, Planners and Architects RECOMMENDED FOR APPROVAL **Stantec** WASHINGTON, D.C. (202) 686-8225 www.dcpsi.com EAST SILVER SPRING Date NEIGHBORHOOD GREENWAY STREETLIGHT PLAN Chief, Division of Transportation Engineering EXPIRATION DATE: SHEET_ 84_ of __113_ SCALE: 1"-20"

Attachment A: Corridor Engineering Drawings *L2I-PP* 0 CEDAR STREET STA.53+50 LT-08 DESIGNED BY:SF DEPARTMENT OF TRANSPORTATION DRAWN BY:SF DATE: MAY, 2024 DIVISION OF TRANSPORTATION ENGINEERING MONTGOMERY COUNTY, MARYLAND CHECKED BY:AYY DATE: MAY, 2024 DRAWING NO: Precision Systems, Inc. RECOMMENDED FOR APPROVAL **Stantec** WASHINGTON, D.C. (202) 686-8225 www.dcpsi.com EAST SILVER SPRING NEIGHBORHOOD GREENWAY APPROVED STREETLIGHT PLAN Chief, Division of Transportation Engineering SHEET_ 85_ of __113_ SCALE: 1"-20"

Attachment A: Corridor Engineering Drawings REFER TO TRAFFIC SIGNAL PLAN FOR STREETLIGHT DESIGN FOR THIS INTERSECTION. 594-A TO BONIFANT STREET SHEET LT-08 SEE STA. 53+50 CEDAR STREET 0 MATCH LINE LT-09 DESIGNED BY:SF DEPARTMENT OF TRANSPORTATION DRAWN BY:SF DATE: MAY, 2024 DIVISION OF TRANSPORTATION ENGINEERING MONTGOMERY COUNTY, MARYLAND CHECKED BY:AYY DATE: MAY, 2024 DATE: DRAWING NO: Precision Systems, Inc.
Engineers, Planners and Architects RECOMMENDED FOR APPROVAL **Stantec** WASHINGTON, D.C. (202) 686-8225 www.dcpsi.com EAST SILVER SPRING Date Chief, Design Section PROFESSIONAL CERTIFICATION*
HERREST CERTIFY THAT THESE DOCUMENTS WERE PREPARED
OR APPROVED BY ME. AND THAT I AM A DULY UCENSED
PROFESSIONAL ENGINEER UNDER THE LAWS OF THE STATE
OF MARTIANIO.

LICENSE NO:
________EXPRATION DATE: NEIGHBORHOOD GREENWAY APPROVED STREETLIGHT PLAN Chief, Division of Transportation Engineering SHEET_ 86_ of __113_ SCALE: 1"-20"

Attachment A: Corridor Engineering Drawings E 1306500 E 1306500 HOUSTON STREET HOUSTON STREET E 1306650 LT-10 DESIGNED BY:SF DEPARTMENT OF TRANSPORTATION DRAWN BY:SF DATE: MAY, 2024 DIVISION OF TRANSPORTATION ENGINEERING MONTGOMERY COUNTY, MARYLAND CHECKED BY:AYY DATE: MAY, 2024 DATE: DRAWING NO: Precision Systems, Inc.
Engineers, Planners and Architects RECOMMENDED FOR APPROVAL **Stantec** WASHINGTON, D.C. (202) 686-8225 www.dcpsi.com EAST SILVER SPRING Date Chief, Design Section NEIGHBORHOOD GREENWAY APPROVED STREETLIGHT PLAN Chief, Division of Transportation Engineering SHEET_ 87_ of __113_ SCALE: 1"-20"

Attachment A: Corridor Engineering Drawings | E 1306450 SHEET LT-08 HOUSTON STREET HOUSTON STREET R43-WP . E 1306650 DESIGNED BY:SF DEPARTMENT OF TRANSPORTATION DRAWN BY:SF DATE: MAY, 2024 DIVISION OF TRANSPORTATION ENGINEERING MONTGOMERY COUNTY, MARYLAND CHECKED BY:AYY DATE: MAY, 2024 DATE: DRAWING NO: Precision Systems, Inc.
Engineers, Planners and Architects RECOMMENDED FOR APPROVAL **Stantec** WASHINGTON, D.C. (202) 686-8225 www.dcpsi.com EAST SILVER SPRING Date Chief, Design Section NEIGHBORHOOD GREENWAY APPROVED STREETLIGHT PLAN Chief, Division of Transportation Engineering EXPIRATION DATE: SHEET_ 88_ of __113_ SCALE: 1"-20"

Attachment A: Corridor Engineering Drawings Summary of Street Lighting Photometric Results - Roadway (Unit: Foot-Candle) Woodbury Dirve, Violet Place, and Richmond Avenue Intersection Design Criteria * Result (Existing) Result (Proposed) Average 0.70 0.58 1.90 Maximum N/A 2.8 3.4 Minimum N/A 0.0 0.5 3.80 Avg/Min Ratio < 6.0 N.A. *Design Criteria based on MDTA Streetlight Policy and Design Guidelines Summary of Street Lighting Photometric Results - Roadway (Unit: Foot-Candle) **Woodbury Drive and Gist Avenue Intersection** Result (Existing) Result (Proposed) Average N/A Maximum N/A Minimum 0.5 Avg/Min Ratio < 6.0 2.98 *Design Criteria based on MDTA Streetlight Policy and Design Guidelines SHEET LT-13 LINE STA. 16+25 WOODBURY DRIVE APP'D DATE DESIGNED BY:SF DATE: MAY, 2024 DEPARTMENT OF TRANSPORTATION DIVISION OF TRANSPORTATION ENGINEERING MONTGOMERY COUNTY, MARYLAND

	Precision Systems, Inc. Engineers, Planners and Architects							
	WASHINGTON, D.C. (202) 686-8225 www.dcpsi.com							
PROFESSIONAL CERTIFICATION: I HEREBY CERTIFY THAT THESE DOCUMENTS WERE PREPARED OR APPROVED BY ME AND THAT HAM A DUBY LICENSED.								

OH APPROVED BY ME, AND THAT IAM A DULY LICENSED PROFESSIONAL ENGINEER UNDER THE LAWS OF THE STATE OF MARYLAND.


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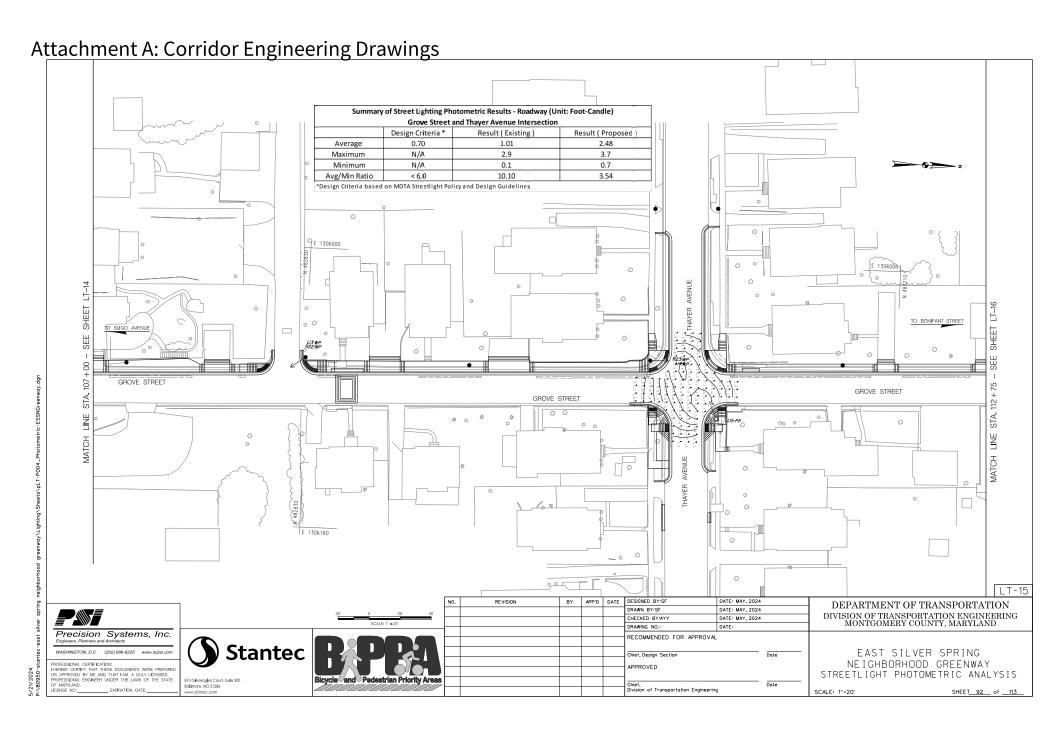
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		DRAWING NO.:	DATE:		
		RECOMMENDED FOR APPROVAL			
		Chief, Design Section		Date	
		APPROVED			
		Chief, Division of Transportation Engineering	Date		
			,		


EAST SILVER SPRING NEIGHBORHOOD GREENWAY STREETLIGHT PHOTOMETRIC ANALYSIS SCALE: 1"-20"



5/21/2024

Attachment A: Corridor Engineering Drawings Summary of Street Lighting Photometric Results - Roadway (Unit: Foot-Candle) **Grove Street and Silver Spring Avenue Intersection** Result (Existing) Result (Proposed) Average Maximum 1.7 3.5 N/A 0.1 0.9 2.89 *Design Criteria based on MDTA Streetlight Policy and Design Guidelines SHEET LT-13 SEE GROVE STREET STA 101+00 GROVE STREET I 3 GROVE STREET E 1306210 DESIGNED BY:SF DATE: MAY, 2024 DEPARTMENT OF TRANSPORTATION DRAWN BY:SF DATE: MAY, 2024 DIVISION OF TRANSPORTATION ENGINEERING MONTGOMERY COUNTY, MARYLAND CHECKED BY:AYY DATE: MAY, 2024 DATE: DRAWING NO: Precision Systems, Inc. RECOMMENDED FOR APPROVAL Stantec WASHINGTON, D.C. (202) 686-8225 www.dcpsi.com EAST SILVER SPRING NEIGHBORHOOD GREENWAY STREETLIGHT PHOTOMETRIC ANALYSIS Chief, Division of Transportation Engineering

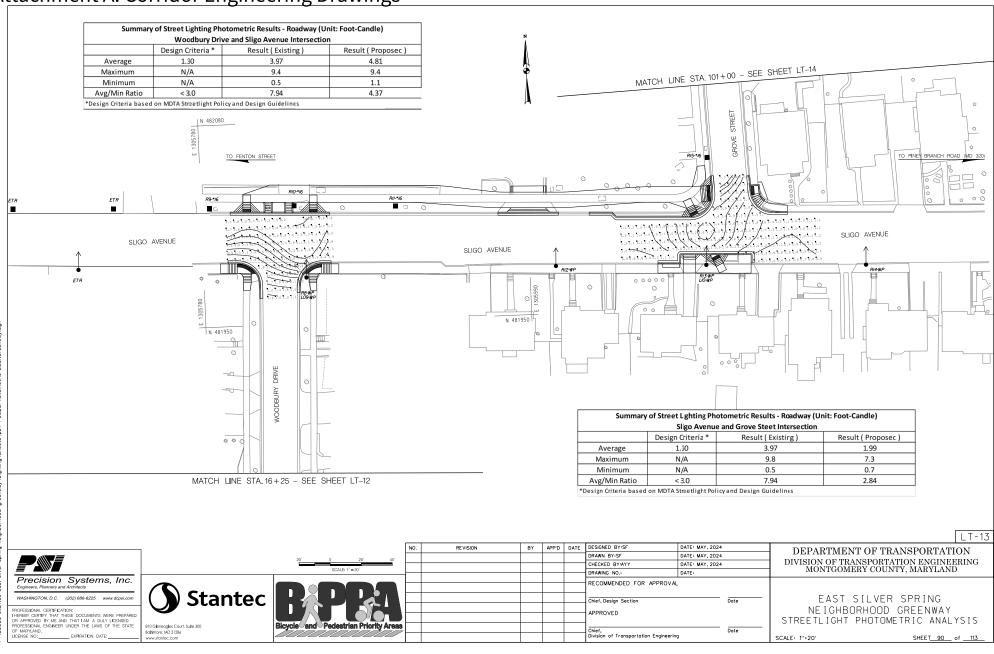

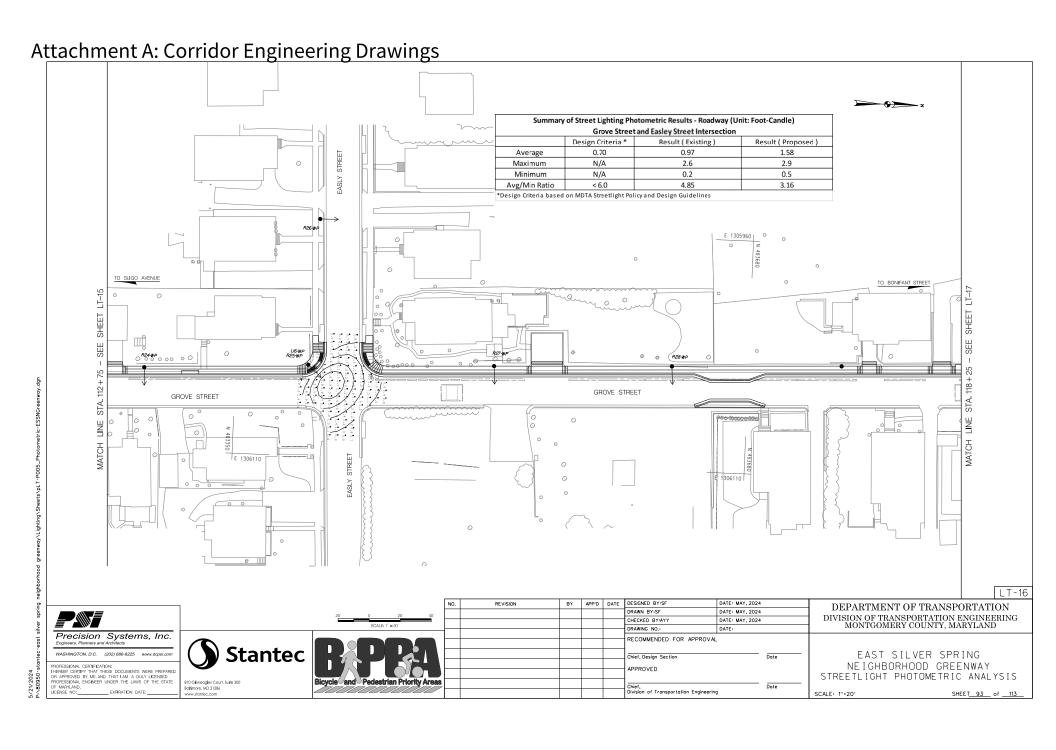


Attachment A: Corridor Engineering Drawings Summary of Street Lighting Photometric Results - Roadway (Unit: Foot-Candle) Grove Street, Hankin Street, and Bonifant Intersection Design Criteria * Result (Existing) Result (Proposec) 0.70 Average Maximum N/A 3.6 3.4 Minimum N/A 0.0 0.6 Avg/Min Ratio < 6.0 N.A. 3.58 *Design Criteria based on MDTA Streetlight Policy and Design Guidelines TO FENTON STREET BONIFANT STREET BONIFANT STREET DESIGNED BY:SF DEPARTMENT OF TRANSPORTATION DRAWN BY:SF DATE: MAY, 2024 DIVISION OF TRANSPORTATION ENGINEERING MONTGOMERY COUNTY, MARYLAND CHECKED BY:AYY DATE: MAY, 2024 DATE: DRAWING NO: Precision Systems, Inc. RECOMMENDED FOR APPROVAL Stantec WASHINGTON, D.C. (202) 686-8225 www.dcpsi.com EAST SILVER SPRING Chief, Design Section NEIGHBORHOOD GREENWAY STREETLIGHT PHOTOMETRIC ANALYSIS APPROVED Chief, Division of Transportation Engineering EXPIRATION DATE:

Attachment A: Corridor Engineering Drawings Summary of Street Lighting Photometric Results - Roadway (Unit: Foot-Candle) Bonifant Street, Cedar Street, and Houston Street Intersection Design Criteria * Result (Existing Result (Proposed) Average 0.55 1.93 3.5 Maximum N/A 2.8 N/A 0.0 0.6 Minimum Avg/Min Ratio < 6.0 N.A. 3.22 *Design Criteria based on MDTA Streetlight Policy and Design Guidelines CEDAR STREET CEDAR STREET 20 DESIGNED BY:SF DEPARTMENT OF TRANSPORTATION DRAWN BY:SF DATE: MAY, 2024 DIVISION OF TRANSPORTATION ENGINEERING MONTGOMERY COUNTY, MARYLAND CHECKED BY:AYY DATE: MAY, 2024 DATE: DRAWING NO: Precision Systems, Inc. RECOMMENDED FOR APPROVAL Stantec WASHINGTON, D.C. (202) 686-8225 www.dcpsi.com EAST SILVER SPRING Date NEIGHBORHOOD GREENWAY STREETLIGHT PHOTOMETRIC ANALYSIS APPROVED Chief, Division of Transportation Engineering


Attachment A: Corridor Engineering Drawings Summary of Street Lighting Photometric Results - Roadway (Unit: Foot-Candle) Cedar Street and Wayne Avenue Intersection Design Criteria * Result (Existing) 1.30 0.62 Average Maximum N/A 1.7 N/A 0.1 < 3.0 *Design Criteria based on MDTA Streetlight Policy and Design Guidelines TO BONIFANT STREET SHEET LT-18 SEE STA. 53+50 CEDAR STREET CEDAR STREET 0 REFER TO TRAFFIC SIGNAL PLAN FOR STREETLIGHT DESIGN FOR THIS INTERSECTION. MD 594-A (WAYNE AVENUE) LT-19 DESIGNED BY:SF DEPARTMENT OF TRANSPORTATION DRAWN BY:SF DATE: MAY, 2024 DIVISION OF TRANSPORTATION ENGINEERING MONTGOMERY COUNTY, MARYLAND CHECKED BY:AYY DATE: MAY, 2024 DATE: DRAWING NO: Precision Systems, Inc. RECOMMENDED FOR APPROVAL Stantec WASHINGTON, D.C. (202) 686-8225 www.dcpsi.com EAST SILVER SPRING Chief, Design Section NEIGHBORHOOD GREENWAY APPROVED STREETLIGHT PHOTOMETRIC ANALYSIS Chief, Division of Transportation Engineering

SHEET 96 of 113

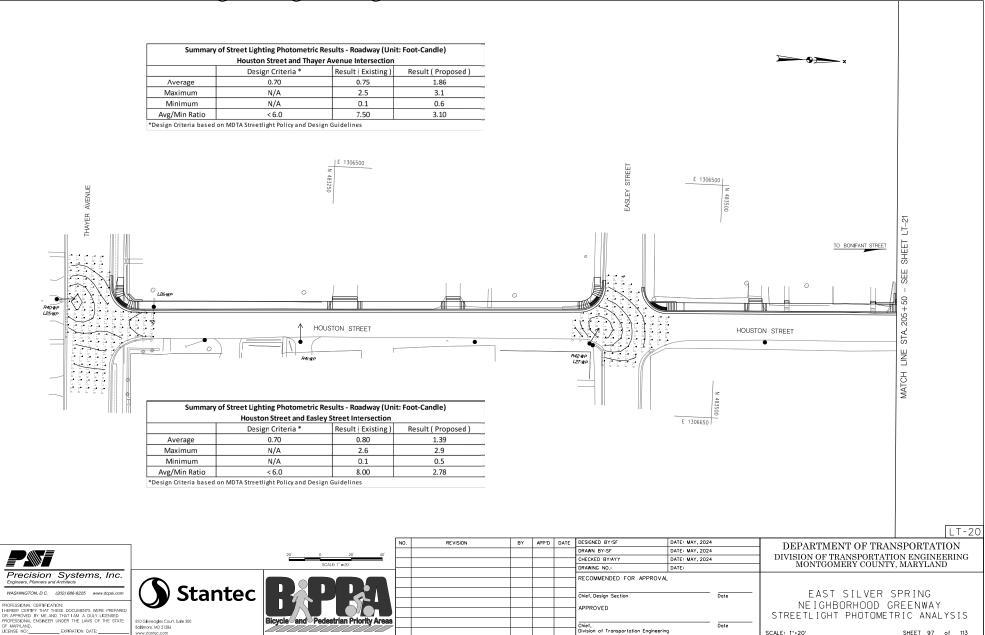

SHEET 97 of 113

EXPIRATION DATE:

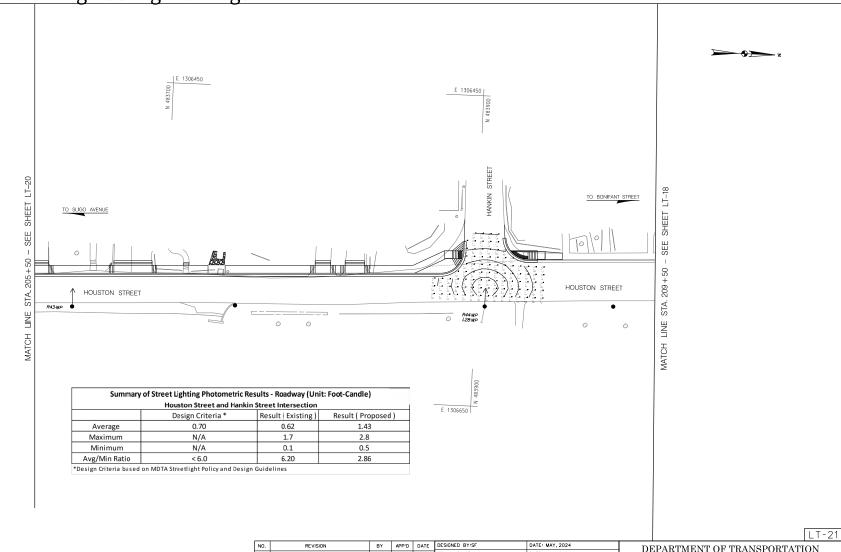



Stantec
810 Gleneagles Court, Suite 300 Bollimore, MD 21286 www.stantec.com

SCALE: 1 = 20	_
Bicycle and Pedestrian Priority Areas	_

	NO.	REVISION	BY	APP'D	DATE	DESIGNED BY:SF	DATE: MAY, 2024	
40'						DRAWN BY:SF	DATE: MAY, 2024	
40'						CHECKED BY:AYY	DATE: MAY, 2024	
	\vdash					DRAWING NO.:	DATE:	
						RECOMMENDED FOR APPROVAL		
						Chief, Design Section		Date
						APPROVED		
Areas						Chief,		Date
						Division of Transportation Engineerin	9	
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DEPARTMENT OF TRANSPORTATION
DIVISION OF TRANSPORTATION ENGINEERING
MONTGOMERY COUNTY, MARYLAND

EAST SILVER SPRING NEIGHBORHOOD GREENWAY STREETLIGHT PHOTOMETRIC ANALYSIS

SCALE: 1"-20' SHEET 98 of 113

97.217.2024 P:\80950-stootec-east

EXISTING STREETLIGHT POLE INFORMATION											
LIGHT	LOCATION			POLE	POLE	ARM	LIGHT	LAMP	REMARKS	REMARKS	DETAILS
NO.		STATION	OFFSET	TYPE	HEIGHT	LENGTH	SOURCE	WATTS			DE 17 (1120
R1-WP	E/S WOODBURY DRIVE S/O VIOLET PLACE	10+52.37	14.98 RT	WOOD POLE	20'	8 FT	HPS	100	COBRAHEAD	NON-CUT-OFF	
R2-WP	SE CORNER OF WOODBURY DRIVE & VIOLET PLACE	11+70.16	28.31 RT	WOOD POLE	20'	8 FT	HPS	100	COBRAHEAD	NON-CUT-OFF	
R3-WP	NE CORNER OF WOODBURY DRIVE & RICHMOND AVENUE	13+04.00	15.143 RT	WOOD POLE	20'	8 FT	HPS	100	COBRAHEAD	NON-CUT-OFF	
R4-WP	SE CORNER OF WOODBURY DRIVE & GIST AVENUE	14+77.80	15.61 RT	WOOD POLE	20'	8 FT	HPS	100	COBRAHEAD	NON-CUT-OFF	
R5-WP	NE CORNER OF WOODBURY DRIVE & GIST AVENUE	15+42.18	47.31 RT	WOOD POLE	20'	8 FT	HPS	100	COBRAHEAD	NON-CUT-OFF	
R6-WP	NW CORNER OF GIST AVENUE & WOODBURY DRIVE	15+42.73	86.59 LT	WOOD POLE	20'	8 FT	HPS	100	COBRAHEAD	NON-CUT-OFF	
R7-WP	E/S WOODBURY DRIVE N/O GIST AVENUE	16+13.36	14.43 RT	WOOD POLE	20'	8 FT	HPS	70	COBRAHEAD	NON-CUT-OFF	
R8-WP	SE CORNER OF WOODBURY DRIVE & SLIGO AVENUE	17+51.03	16.71 RT	WOOD POLE	20'	8 FT	HPS	70	COBRAHEAD	NON-CUT-OFF	
R9-#16	NW CORNER OF WOODBURY DRIVE & SLIGO AVENUE	20+23.69	18.87 LT	16 C1	13' 2"		LED	60	WASHINGTON GLOBE		
R10-#16	NE CORNER OF WOODBURY DRIVE & SLIGO AVENUE	20+78.12	20.76 LT	16 C1	13' 2"		LED	60	WASHINGTON GLOBE		
R11-#16	N/S SLIGO AVENUE N/O WOODBURY DRIVE	21+43.53	20.70 LT	16 C1	13' 2"		LED	60	WASHINGTON GLOBE		
R12-WP	S/S SLIGO AVENUE N/O WOODBURY DRIVE	22+46.75	18.03 RT	WOOD POLE	20'	8 FT	LED	70	COBRAHEAD	NON-CUT-OFF	
R13-WP	SW CORNER OF SLIGO AVENUE & GROVE STREET	23+43.61	17.35 RT	WOOD POLE	20'	15 FT	LED	70	COBRAHEAD	NON-CUT-OFF	
R14-WP	\$/S SLIGO AVENUE S/O GROVE STREET	24+46.46	17.17 RT	WOOD POLE	20'	8 FT	HPS	100	COBRAHEAD	NON-CUT-OFF	
R15-#16	1ST POLE W/S GROVE STREET N/O SLIGO AVENUE	100+53.15	13.82 LT	16 C1	13' 2"		LED	60	WASHINGTON GLOBE		
R16-#16	2ND POLE W/S GROVE STREET N/O SLIGO AVENUE	101+23.90	13.97 LT	16 C1	13' 2"		LED	60	WASHINGTON GLOBE		
R17-#16	3RD POLE W/S GROVE STREET N/O SLIGO AVENUE	101+97.26	14.50 LT	16 C1	13' 2"		LED	60	WASHINGTON GLOBE		
R18-WP	4TH POLE W/S GROVE STREET N/O SLIGO AVENUE	102+61.55	12.82 LT	WOOD POLE	20'	4 FT	HPS	70	COBRAHEAD	NON-CUT-OFF	
R19-#16	5TH POLE W/S GROVE STREET N/O SLIGO AVENUE	102+98.97	14.16 LT	16 C1	13' 2"		LED	60	WASHINGTON GLOBE		
R20-WP	NW CORNER OF SILVER SPRING AVENUE & GROVE STREET	106+08.86	22.64 LT	WOOD POLE	20'	8 FT	LED	40	COBRAHEAD	NON-CUT-OFF	
R21-WP	N/S SILVER SPRING AVENUE W/O GROVE STREET	106+06.31	117.27 LT	WOOD POLE	20'	8 FT	LED	40	COBRAHEAD	NON-CUT-OFF	
R22-WP	NW CORNER OF GROVE STREET AND RIPLEY STREET	108+36.74	18.43 LT	WOOD POLE	20'	4 FT	HPS	70	COBRAHEAD	CUT-OFF	
R23-WP	SW CORNER OF GROVE STREET AND THAYER AVENUE	110+58.72	16.28 LT	WOOD POLE	20'	8 FT	HPS	170	COBRAHEAD	NON-CUT-OFF	
R24-WP	W/S GROVE STREET S/O EASLEY STREET	112+98.85	13.29 LT	WOOD POLE	20'	4 FT	HPS	70	COBRAHEAD	NON-CUT-OFF	
R25-WP	SW CORNER OF GROVE STREET & EASLEY STREET	114+04.49	14.88 LT	WOOD POLE	20'	8 FT	HPS	100	COBRAHEAD	NON-CUT-OFF	
R26-WP	S/S EASLEY STREET W/O GROVE STREET	114+12.20	108.75 LT	WOOD POLE	20'	8 FT	HPS	100	COBRAHEAD	NON-CUT-OFF	
R27-WP	W/S GROVE STREET N/O EASLEY STREET	115+24.09	13.95 LT	WOOD POLE	20'	8 FT	HPS	70	COBRAHEAD	NON-CUT-OFF	
R28-WP	W/S GROVE STREET S/O BONIFANT STREET	116+36.69	13.78 LT	WOOD POLE	20'	4 FT	HPS	70	COBRAHEAD	CUT-OFF	
R29-WP	SW CORNER OF GROVE STREET AND BONIFANT STREET	118+63.41	13.65 LT	WOOD POLE	20'	15 FT	HPS	150	COBRAHEAD	NON-CUT-OFF	
R30-WP	1ST POLE N/S BONIFANT STREET E/O GROVE STREET	43+67.05	15.06 LT	WOOD POLE	20'	4 FT	HPS	70	COBRAHEAD	NON-CUT-OFF	
R31-WP	2ND POLE N/S BONIFANT STREET E/O GROVE STREET	45+58.10	14.40 LT	WOOD POLE	20'	8 FT	HPS	70	COBRAHEAD	CUT-OFF	
R32-WP	S/S BONIFANT STREET W/C CEDAR STREET	46+78.67	13.20 RT	WOOD POLE	20'	4 FT	HPS	70	COBRAHEAD	CUT-OFF	
R33-WP	SE CORNER OF CEDAR STREET & BONIFANT STREET	50+63.86	24.46 RT	WOOD POLE	20'	4 FT	HPS	100	COBRAHEAD	NON-CUT-OFF	
R34-WP R35-WP	NE CORNER OF CEDAR STREET & DARTMOUTH AVENUE	51+94.19	23.8 RT	WOOD POLE	20' 20'	4 FT	HPS	100 70	COBRAHEAD	NON-CUT-OFF	
R35-WP R36-WP	E/S CEDAR STREET N/O DARTMOUTH AVENUE	53+42.97	22.65 RT	WOOD POLE	20'	4 FT	HPS HPS		COBRAHEAD	NON-CUT-OFF	
R36-WP	SE CORNER CEDAR STREET & WAYNE AVENUE S/S WAYNE AVENUE W/O CEDAR STREET	55+92.78 55+96.17	29.80 RT 102.84 LT	WOOD POLE	20'	15 FT 15 FT	HPS	70 100	COBRAHEAD	NON-CUT-OFF CUT-OFF	
				WOOD POLE			HPS	100	COBRAHEAD	CUT-OFF CUT-OFF	
R38-WP R39-WP	E/S CEDAR STREET N/O WAYNE AVENUE W/S CEDAR STREET N/O WAYNE AVENUE	3252+36.61 3252+40.41	28.85 RT 25.44 LT	WOOD POLE	20' 20'	15 FT 15 FT	HPS	150	COBRAHEAD COBRAHEAD	CUT-OFF CUT-OFF	
R39-WP		200+09.17	16.05 LT	WOOD POLE	20'	4 FT	HPS	100	COBRAHEAD	NON-CUT-OFF	
R40-WP	S/S THAYER AVENUE S/O HOUSTON STREET	200+09.17	16.05 LT	WOOD POLE	20'	4 FT	HPS	70	COBRAHEAD	NON-CUT-OFF NON-CUT-OFF	
R41-WP R42-WP	E/S HOUSTON STREET N/O THAYER AVENUE SE CRONER OF HOUSTON STREET & EASLEY STREET	201+56.08	11.44 RT	WOOD POLE	20'	4 FT	HPS	100	COBRAHEAD	NON-CUT-OFF	
R42-WP	E/S HOUSTON STREET N/O EASLEY STREET	203+52.29	12.54 RT	WOOD POLE	20'	4 FT	HPS	70	COBRAHEAD	NON-CUT-OFF	
R44-WP	E/S HOUSTON STREET E/O HANKIN STREET STREET	208+37.22	16.44 RT	WOOD POLE	20'	4 FT	HPS	70	COBRAHEAD	NON-CUT-OFF	

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DEPARTMENT OF TRANSPORTATION
DIVISION OF TRANSPORTATION ENGINEERING
MONTGOMERY COUNTY, MARYLAND

EAST SILVER SPRING NEIGHBORHOOD GREENWAY STREETLIGHT TABLES

SCALE: NTS SHEET 99 of 113

PROPOSED STREETLIGHT POLE INFORMATION											
LIGHT	LOCATION			POLE	POLE	ARM	LIGHT	LAMP	REMARKS	DETAILS	
NO.		STATION	OFFSET	TYPE	HEIGHT	LENGTH	SOURCE	WATTS	KEWAKKO		
L01-WP	SE CORNER OF WOODBURY DRIVE & VIOLET PLACE	11+70.16	28.31 RT	WOOD POLE	25 FT	8 FT	LED	100	COBRAHEAD	EXISTING WOOD POLE TO REMAIN, REPLACE	
L02-PP	WS WOODBURY DRIVE N/O VIOLET PLACE	12+50.25	45.63 RT	PENDANT POLE	28.5 FT	8 FT	LED	100	COBRAHEAD	LIGHTING ARM AND FIXTURE INSTALL NEW POLE, LIGHTING ARM AND FIXTURE	
L03-PP	E/S WOODBURY DRIVE N/O VIOLET PLACE	12+08.59	45.48 LT	PENDANT POLE	28.5 FT	8 FT	LED	100	COBRAHEAD	INSTALL NEW POLE, LIGHTING ARM AND FIXTURE	
										EXISTING WOOD POLE TO REMAIN, REPLACE	
L04-WP	NE CORNER OF WOODBURY DRIVE & RICHMOND AVENUE	13+04.00	15.43 RT	WOOD POLE	25 FT	8 FT	LED	100	COBRAHEAD	LIGHTING ARM AND FIXTURE	
L05-WP	SE CORNER OF WOODBURY DRIVE & GIST AVENUE	14+77.80	15.61 RT	WOOD POLE	25 FT	8 FT	LED	100	COBRAHEAD	EXISTING WOOD POLE TO REMAIN, REPLACE	
E03-441	SE CONNER OF WOODBORT BRIVE & ODT AVENUE	14.77.00	13.011(1	WOODTOLL	2311	011	LLU	100	COBINATILAD	LIGHTING ARM AND FIXTURE	
L06-WP	NE CORNER OF WOODBURY DRIVE & GIST AVENUE	15+42.18	47.31 RT	WOOD POLE	25 FT	8 FT	LED	100	COBRAHEAD	EXISTING WOOD POLE TO REMAIN, REPLACE	
										LIGHTING ARM AND FIXTURE	
L07-WP	NW CORNER OF GIST AVENUE & WOODBURY DRIVE	15+42.73	86.59 LT	WOOD POLE	25 FT	8 FT	LED	100	COBRAHEAD	EXISTING WOOD POLE TO REMAIN, REPLACE LIGHTING ARM AND FIXTURE	
										EXISTING WOOD POLE TO REMAIN, REPLACE	
L08-WP	E/S WOODBURY DRIVE N/O GIST AVENUE	16+13.36	14.43 RT	WOOD POLE	25 FT	8 FT	LED	100	COBRAHEAD	LIGHTING ARM AND FIXTURE	
L09-WP	SE CORNER OF WOODBURY DRIVE & SLIGO AVENUE	17+51.03	16.71 RT	WOOD POLE	25 FT	8 FT	LED	100	COBRAHEAD	EXISTING WOOD POLE TO REMAIN, REPLACE	
L03-VVF	SE CORNER OF WOODBORT DRIVE & SEIGO AVENUE	17+31.03	10.71101	WOODFOLL	2311	011	LLU	100	COBRATILAD	LIGHTING ARM AND FIXTURE	
L10-WP	SW CORNER OF SLIGO AVENUE & GROVE STREET	23+43.61	17.35 RT	WOOD POLE	25 FT	15 FT	LED	100	COBRAHEAD	EXISTING WOOD POLE TO REMAIN, REPLACE	
										LIGHTING ARM AND FIXTURE	
L11-WP	NW CORNER OF SILVER SPRING AVENUE & GROVE STREET	106+08.86	22.64 LT	WOOD POLE	25 FT	8 FT	LED	100	COBRAHEAD	EXISTING WOOD POLE TO REMAIN, REPLACE LIGHTING ARM AND FIXTURE	
L12-PP	SE CORNER OF SILVER SPRING AVENUE & GROVE STREET	105+72.69	24.02 RT	PENDANT POLE	28.5 FT	8 FT	LED	100	COBRAHEAD	INSTALL NEW POLE, LIGHTING ARM AND FIXTURE	
										EXISTING WOOD POLE TO REMAIN, REPLACE	
L13-WP	NW CORNER OF GROVE STREET AND RIPLEY STREET	108+36.74	18.43 LT	WOOD POLE	25 FT	4 FT	LED	100	COBRAHEAD	LIGHTING ARM AND FIXTURE	
L14-WP	SW CORNER OF GROVE STREET AND THAYER AVENUE	110+58.72	16.28 LT	WOOD POLE	25 FT	8 FT	LED	100	COBRAHEAD	EXISTING WOOD POLE TO REMAIN, REPLACE	
										LIGHTING ARM AND FIXTURE	
L15-PP	NE CORNER OF GROVE STREET AND THAYER AVENUE	110+91.05	21.23 RT	PENDANT POLE	28.5 FT	8 FT	LED	100	COBRAHEAD	INSTALL NEW POLE, LIGHTING ARM AND FIXTURE	
L16-WP	SW CORNER OF GROVE STREET & EASLEY STREET	114+04.48	14.87 LT	WOOD POLE	25 FT	15 FT	LED	100	COBRAHEAD	EXISTING WOOD POLE TO REMAIN, REPLACE	
										LIGHTING ARM AND FIXTURE EXISTING WOOD POLE TO REMAIN, REPLACE	
L17-WP	SW CORNER OF GROVE STREET AND BONIFANT STREET	118+63.41	13.65 LT	WOOD POLE	25 FT	15 FT	LED	100	COBRAHEAD	LIGHTING ARM AND FIXTURE	
L18-PP	SE CORNER OF GROVE STREET AND BONIFANT STREET	42+19.03	17.58 RT	PENDANT POLE	28.5 FT	8 FT	LED	100	COBRAHEAD	INSTALL NEW POLE, LIGHTING ARM AND FIXTURE	
L19-WP	N/S BONIDANT STREET E/C GROVE STREET	42+80.78	14.45 RT	WOOD POLE	25 FT	8 FT	LED	100	COBRAHEAD	EXISTING WOOD POLE TO REMAIN, INSTALL LIGHTING	
										ARM AND FIXTURE	
L20-PP	NW CORNER OF CEDAR STREET & BONIFANT STREET	47+30.37	17.78 LT	PENDANT POLE		8 FT	LED	100	COBRAHEAD	INSTALL NEW POLE, LIGHTING ARM AND FIXTURE	
L21-PP	W/S CEDAR STREET N/O BONIFANT STREET	51+41.49	15.00 LT	PENDANT POLE	28.5 FT	8 FT	LED	100	COBRAHEAD	INSTALL NEW POLE, LIGHTING ARM AND FIXTURE	
L22-PP	SW CORNER OF CEDAR STREET & BONIFANT STREET	210+63.08	12.68 RT	PENDANT POLE	28.5 FT	8 FT	LED	100	COBRAHEAD	INSTALL NEW POLE, LIGHTING ARM AND FIXTURE	
L23-WP	SE CORNER OF CEDAR STREET & BONIFANT STREET	50+63.86	24.46 RT	WOOD POLE	25 FT	4 FT	LED	100	COBRAHEAD	EXISTING WOOD POLE TO REMAIN, REPLACE LIGHTING ARM AND FIXTURE	
										EXISTING WOOD POLE TO REMAIN, REPLACE	
L24-WP	NE CORNER OF CEDAR STREET & DARTMOUTH AVENUE	51+94.18	23.28 RT	WOOD POLE	25 FT	4 FT	LED	100	COBRAHEAD	LIGHTING ARM AND FIXTURE	
1.05.14/D	C/C THANED AVENUE C/O HOUGTON CTDEET	200:00 47	40.04 LT	WOOD DOLE	05.57	4 FT	1.55	400	CODDALIEAD	EXISTING WOOD POLE TO REMAIN, REPLACE	
L25-WP	S/S THAYER AVENUE S/O HOUSTON STREET	200+09.17	16.04 LT	WOOD POLE	25 FT	4 F I	LED	100	COBRAHEAD	LIGHTING ARM AND FIXTURE	
L26-WP	W/S HOUSTON STREET N/O THAYER AVENUE	200+71.65	11.11 LT	WOOD POLE	25 FT	8 FT	LED	100	COBRAHEAD	EXISTING WOOD POLE TO REMAIN, INSTALL LIGHTING	
	1,1011000101101112211110111111111111111	200111100		11005 1 022		• • • •			5051011275	ARM AND FIXTURE	
L27-WP	SE CRONER OF HOUSTON STREET & EASLEY STREET	203+52.29	12.54 RT	WOOD POLE	25 FT	4 FT	LED	100	COBRAHEAD	EXISTING WOOD POLE TO REMAIN, REPLACE	
										LIGHTING ARM AND FIXTURE EXISTING WOOD POLE TO REMAIN, REPLACE	
L28-WP	E/S HOUSTON STREET E/O HANKIN STREET STREET	208+37.22	16.44 RT	WOOD POLE	25 FT	4 FT	LED	100	COBRAHEAD	LIGHTING ARM AND FIXTURE	
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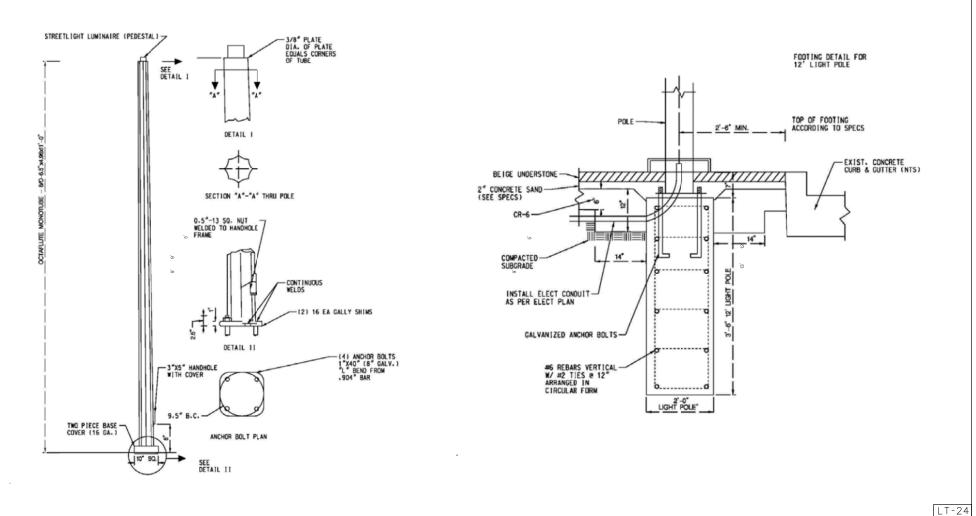
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DEPARTMENT OF TRANSPORTATION
DIVISION OF TRANSPORTATION ENGINEERING
MONTGOMERY COUNTY, MARYLAND

EAST SILVER SPRING NEIGHBORHOOD GREENWAY STREETLIGHT TABLES

SCALE: NTS SHEET 100 of 113

5/21/2024



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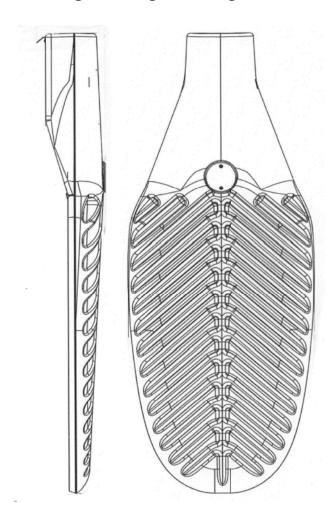
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DEPARTMENT OF TRANSPORTATION DIVISION OF TRANSPORTATION ENGINEERING MONTGOMERY COUNTY, MARYLAND

> EAST SILVER SPRING NEIGHBORHOOD GREENWAY STREETLIGHT DETAILS

SCALE: NTS SHEET 101 of 113

5/21/2024



ROADWAY COBRA-HEAD (PENDANT) FIXTURE

DATE: MAY, 2024

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REVISION

DEPARTMENT OF TRANSPORTATION DIVISION OF TRANSPORTATION ENGINEERING MONTGOMERY COUNTY, MARYLAND

> EAST SILVER SPRING NEIGHBORHOOD GREENWAY STREETLIGHT DETAILS

SHEET 102 of 113 SCALE: NTS

Attachment A: Corridor Engineering Drawings UT-01 UT-06 UT-08 UT-10 DRAWN BY: DHM III DATE: MAY, 2024 DIVISION OF TRANSPORTATION ENGINEERING MONTGOMERY COUNTY, MARYLAND CHECKED BY: SJZ DATE: MAY, 2024 DRAWING NO.: RECOMMENDED FOR APPROVAL **Stantec** EAST SILVER SPRING NEIGHBORHOOD GREENWAY UTILITY PLAN KEY Chief, Division of Transportation Engineering SCALE: 1"=200" SHEET_ 103_ of __113

Attachment A: Corridor Engineering Drawings © CONSTRUCTION WOODBURY DRIVE E 1305750 CONSTRUCTION SHEET UT-02 |E 1305750/ STA. 16+25 +50 WOODBURY DRIVE 14+00 WOODBURY DRIVE MTCH E 1305880 DEPARTMENT OF TRANSPORTATION DRAWN BY: DHM III DATE: MAY, 2024 DIVISION OF TRANSPORTATION ENGINEERING MONTGOMERY COUNTY, MARYLAND CHECKED BY: SJZ DATE: MAY, 2024 DRAWING NO.: RECOMMENDED FOR APPROVAL **Stantec** EAST SILVER SPRING NEIGHBORHOOD GREENWAY PROFESSIONAL CERTIFICATION:
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OF MARRIAND. UTILITY PLAN Chief, Division of Transportation Engineering SCALE: 1"=20"

Attachment A: Corridor Engineering Drawings MATCH LINE STA. 101+00 - SEE SHEET UT-03 TO FENTON STREET RELOCATE FIRE HYDRANT (BY OTHERS) -18"RCP 20+00 22+00 SLIGO AVENUE 24+00 SLIGO AVENUE SLIGO AVENUE N 481950 € CONSTRUCTION WOODBURY DRIVE MATCH LINE STA. 16+25 - SEE SHEET UT-01 UT-02 DEPARTMENT OF TRANSPORTATION DRAWN BY: DHM III DATE: MAY, 2024 DIVISION OF TRANSPORTATION ENGINEERING MONTGOMERY COUNTY, MARYLAND CHECKED BY: SJZ DATE: MAY, 2024 DRAWING NO.: RECOMMENDED FOR APPROVAL **Stantec** EAST SILVER SPRING Chief, Design Section NEIGHBORHOOD GREENWAY PROFESSIONAL CERTIFICATION:
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LICENSE NO. DOPPRATION DATE: APPROVED UTILITY PLAN Chief, Division of Transportation Engineering SHEET_<u>105</u> of <u>113</u> SCALE: 1"=20"

Attachment A: Corridor Engineering Drawings 010 - RELOCATE UTILITY UT-02 102+00 GROVE STREET 18"RCP GROVE STREET 101 STA. B CONSTRUCTION GROVE STREET MATCH HOLLY LANE E 1306210 ŪT-03 DATE: MAY, 2024 DEPARTMENT OF TRANSPORTATION DRAWN BY: DHM III DATE: MAY, 2024 DIVISION OF TRANSPORTATION ENGINEERING MONTGOMERY COUNTY, MARYLAND CHECKED BY: SJZ DATE: MAY, 2024 DRAWING NO.: RECOMMENDED FOR APPROVAL **Stantec** EAST SILVER SPRING Chief, Design Section NEIGHBORHOOD GREENWAY PROFESSIONAL CERTIFICATION:
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OF MARYLAND.
DEPRATION DATE: UTILITY PLAN Chief, Division of Transportation Engineering SHEET_106_ of_113 SCALE: 1"=20"

Attachment A: Corridor Engineering Drawings 00 9E 1306000 - RELOCATE UTILITY POLE (BY OTHERS) E 1306000 SHEET RELOCATE UTILITY POLE -SHEET RELOCATE FIRE HYDRAN 108+00 GROVE STREET 054 GROVE STREET GROVE STREET STA. € CONSTRUCTION = GROVE STREET EX-MH 14 N 482830 E 1306180 UT-04 DEPARTMENT OF TRANSPORTATION DRAWN BY: DHM III DATE: MAY, 2024 DIVISION OF TRANSPORTATION ENGINEERING MONTGOMERY COUNTY, MARYLAND CHECKED BY: SJZ DATE: MAY, 2024 DRAWING NO.: RECOMMENDED FOR APPROVAL **Stantec** EAST SILVER SPRING Chief, Design Section NEIGHBORHOOD GREENWAY PROFESSIONAL CERTIFICATION:
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LICENSE NO. DAPPRATION DATE: UTILITY PLAN Chief, Division of Transportation Engineering SHEET_107_ of __113 SCALE: 1"=20"

Attachment A: Corridor Engineering Drawings TO SLIGO AVENUE E 1305960 J - RELOCATE UTILITY TO BONIFANT STREET 0T-06 SHEET SHEET BELOCATE LITHITY POLE RELOCATE UTILITY POLE GROVE STREET STA. € CONSTRUCTION -GROVE STREET E 1306110 CONSTRUCTION GROVE STREET UT-05 APP'D DATE DEPARTMENT OF TRANSPORTATION DRAWN BY: DHM III DATE: MAY, 2024 DIVISION OF TRANSPORTATION ENGINEERING MONTGOMERY COUNTY, MARYLAND CHECKED BY: SJZ DATE: MAY, 2024 DATE DRAWING NO.: RECOMMENDED FOR APPROVAL **Stantec** EAST SILVER SPRING Chief, Design Section NEIGHBORHOOD GREENWAY PROFESSIONAL CERTIFICATION:
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Attachment A: Corridor Engineering Drawings TO FENTON STREET CONSTRUCTION BONIFANT STREET 44+00 BONIFANT STREET BONIFANT STREET RELOCATE UTILITY POLE (BY OTHERS) € CONSTRUCTION BONIFANT STREET & CONSTRUCTION -GROVE STREET REVISION DESIGNED BY: DHM III DATE: MAY, 2024 DEPARTMENT OF TRANSPORTATION DRAWN BY: DHM III DATE: MAY, 2024 DIVISION OF TRANSPORTATION ENGINEERING MONTGOMERY COUNTY, MARYLAND CHECKED BY: SJZ DATE: MAY, 2024 DRAWING NO.: RECOMMENDED FOR APPROVAL **Stantec** EAST SILVER SPRING Chief, Design Section NEIGHBORHOOD GREENWAY PROFESSIONAL CERTIFICATION:
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Attachment A: Corridor Engineering Drawings CONSTRUCTION BONIFANT STREET € CONSTRUCTION + HOUSTON STREET CEDAR STREET 52+00 UT-07 DESIGNED BY: DHM III DEPARTMENT OF TRANSPORTATION DRAWN BY: DHM III DATE: MAY, 2024 DIVISION OF TRANSPORTATION ENGINEERING MONTGOMERY COUNTY, MARYLAND CHECKED BY: SJZ DATE: MAY, 2024 DRAWING NO.: RECOMMENDED FOR APPROVAL **Stantec** EAST SILVER SPRING Chief, Design Section NEIGHBORHOOD GREENWAY UTILITY PLAN Chief, Division of Transportation Engineering SHEET_IIO_ of __II3_ SCALE: 1"=20"

Attachment A: Corridor Engineering Drawings TO BONIFANT STREET CEDAR STREET CEDAR STREET DEPARTMENT OF TRANSPORTATION DRAWN BY: DHM III DATE: MAY, 2024 DIVISION OF TRANSPORTATION ENGINEERING MONTGOMERY COUNTY, MARYLAND CHECKED BY: SJZ DATE: MAY, 2024 DRAWING NO.: RECOMMENDED FOR APPROVAL **Stantec** EAST SILVER SPRING NEIGHBORHOOD GREENWAY UTILITY PLAN Chief, Division of Transportation Engineering SHEET_III_ of __II3_ SCALE: 1"=20"

Attachment A: Corridor Engineering Drawings | E 1306500 E 1306500 J. - RELOCATE FIRE HYDRANT RELOCATE UTILITY POLE 202+00 HOUSTON STREET HOUSTON STREET STA. 6 CONSTRUCTION HOUSTON STREET € CONSTRUCTION HOUSTON STREET E 1306650 UT-09 DESIGNED BY: DHM III APP'D DATE DEPARTMENT OF TRANSPORTATION DRAWN BY: DHM III DATE: MAY, 2024 DIVISION OF TRANSPORTATION ENGINEERING MONTGOMERY COUNTY, MARYLAND CHECKED BY: SJZ DATE: MAY, 2024 DATE DRAWING NO.: RECOMMENDED FOR APPROVAL **Stantec** EAST SILVER SPRING Chief, Design Section NEIGHBORHOOD GREENWAY APPROVED UTILITY PLAN Chief, Division of Transportation Engineering SCALE: 1"=20"

Attachment A: Corridor Engineering Drawings E 1306450 209 + 50206+00 207+00 HOUSTON STREET HOUSTON STREET STA. R43-WP . € CONSTRUCTION -HOUSTON STREET € CONSTRUCTION HOUSTON STREET E 1306650 DESIGNED BY: DHM III APP'D DATE DEPARTMENT OF TRANSPORTATION DRAWN BY: DHM III DATE: MAY, 2024 DIVISION OF TRANSPORTATION ENGINEERING MONTGOMERY COUNTY, MARYLAND CHECKED BY: SJZ DATE: MAY, 2024 DRAWING NO.: RECOMMENDED FOR APPROVAL **Stantec** EAST SILVER SPRING Chief, Design Section NEIGHBORHOOD GREENWAY APPROVED UTILITY PLAN Chief, Division of Transportation Engineering SHEET_II3_ of _II3 SCALE: 1"=20"