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**MONTGOMERY COUNTY
DEPARTMENT OF TRANSPORTATION**

**NORWOOD ROAD
SHARED USE PATH**

C. I. P. PROJECT NO. 502313

RELATED REQUIRED PERMITS					
IT IS THE RESPONSIBILITY OF PERMITTEE/OWNER OF THIS SITE TO OBTAIN ALL REQUIRED PERMITS PRIOR TO ISSUANCE OF THE APPROVED SEDIMENT CONTROL PERMIT					
TYPE OF PERMIT	REQD	NOT REQD	PERMIT #	EXPIRATION DATE	WORK RESTRICTION DATES
MCDPS Floodplain District		X			
WATERWAYS/WETLAND(S):					
a. Corps of Engineers	X				
b. MDE	X				
c. MDE Water Quality Certification		X			
MDE Dam Safety		X			
*DPS Roadside Trees Protection Plan	X		MCDOT BLANKET PERMIT NO. 361405	Approval Date	DATE FILED
N.P.D.E.S. NOTICE OF INTENT		X			
TOW LUMP (Required Post Construction)		X			
OTHERS:					
DPS Erosion and Sediment Control	X				
MDCPPC Permit		X			
* A copy of the Roadside Trees Protection Plan must be delivered to the sediment control inspector at the preconstruction meeting.					
OWNER/PERMIT APPLICANT INFORMATION					
NAME: MONTGOMERY COUNTY DEPARTMENT OF TRANSPORTATION					
ADDRESS: 100 EDISON PARK DRIVE, 4TH FLOOR, GAITHERSBURG, MD 20878					
PHONE NUMBER: (240) 777-7263					
CONTACT PERSON: REBECCA PARK, P.E.					


DRAINAGE STATEMENT

I understand that DPS approval of this sediment control/stormwater management plan is for demonstrated compliance with required environmental runoff treatment standards. This DPS sediment control/stormwater management plan approval does not relieve me of professional responsibility. I have analyzed the proposed design for sediment control permit no. _____ and hereby certify that, based upon my background, training and experience, I have determined that the proposed improvements shown on this plan meet relevant laws and regulations. I further acknowledge that I have analyzed the post development drainage patterns for this project from the standpoint of my responsibilities under current Maryland Law and have determined that if permission is required from adjacent property owners, I have obtained it and have made copies of those permissions available to DPS.

Engineer's Signature _____ Date _____

Printed Name _____

**LIMIT OF WORK
CONTR. NO. 502313
SHARED USE PATH**

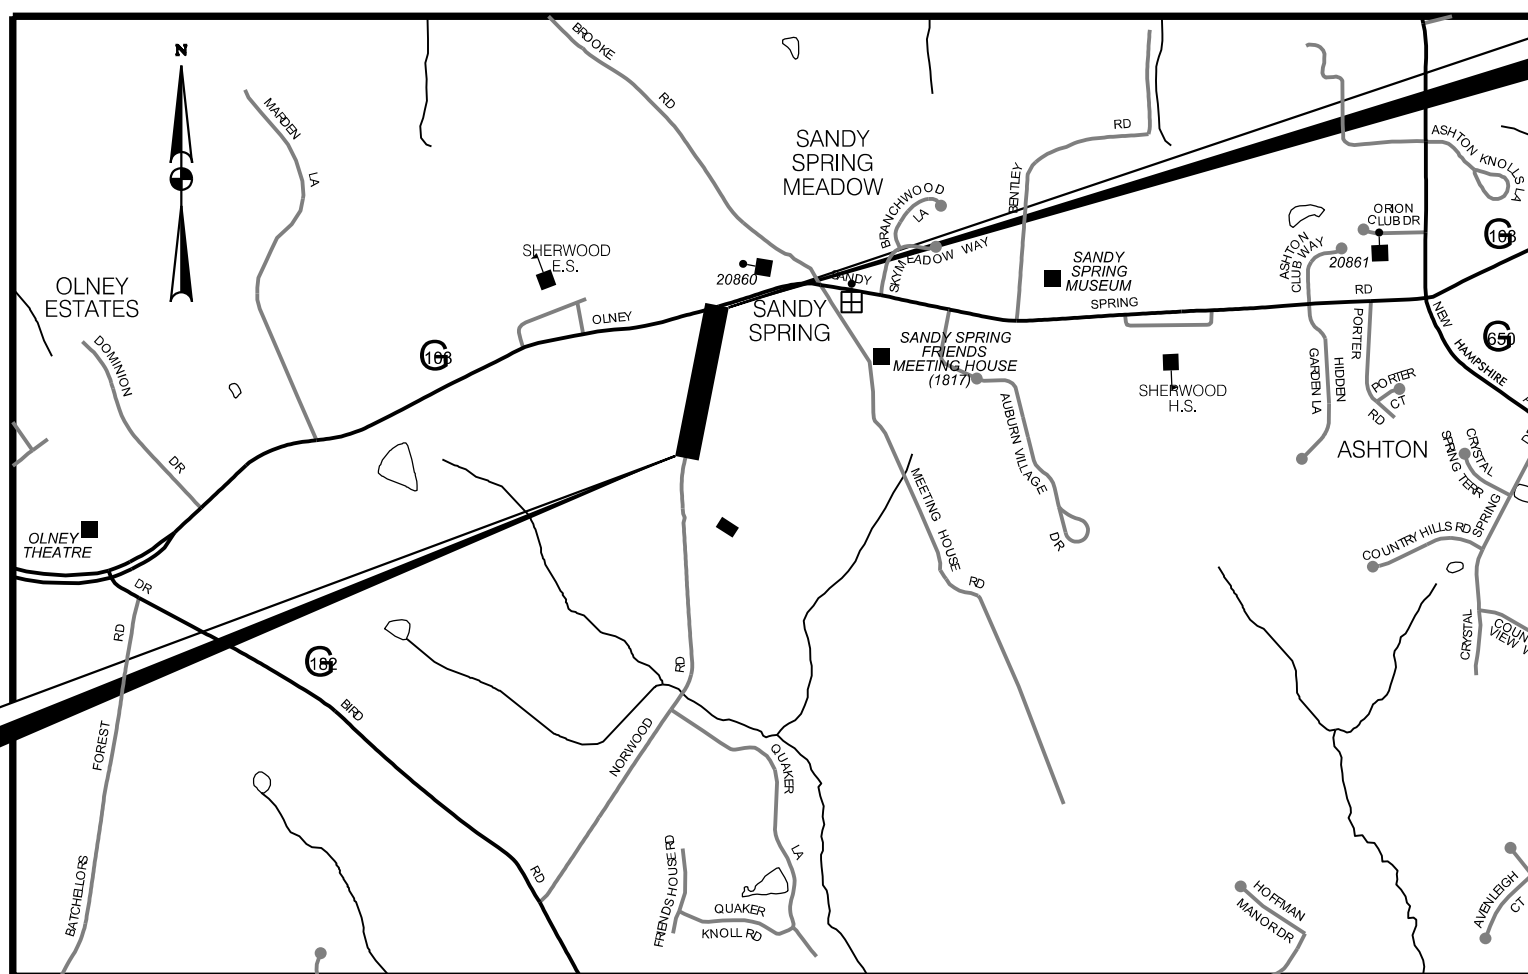

VICINITY MAP
MONTGOMERY COUNTY
LENGTH OF PROJECT:
NORWOOD ROAD = 0.30 MILES
SCALE : 1" = 2000'

**LIMIT OF WORK
CONTR. NO. 502313
SHARED USE PATH**

GENERAL NOTES

- ALL CONSTRUCTION SHALL BE DONE IN ACCORDANCE WITH THE LATEST EDITION OF THE STANDARD SPECIFICATIONS OF THE MARYLAND STATE HIGHWAY ADMINISTRATION JULY 2023 AND MONTGOMERY COUNTY DESIGN STANDARDS.
- INFORMATION CONCERNING UNDERGROUND UTILITIES WAS OBTAINED FROM AVAILABLE RECORDS, BUT THE CONTRACTOR MUST DETERMINE THE EXACT LOCATIONS AND ELEVATIONS OF THE LINES BY DIGGING TEST PITS BY HAND AT ALL UTILITY CROSSINGS, WELL IN ADVANCE OF TRENCHING. IF CLEARANCES ARE LESS THAN SHOWN OR SIX (6) INCHES, WHICHEVER IS LESS, CONTACT MONTGOMERY COUNTY DEPARTMENT OF TRANSPORTATION'S PROJECT INSPECTOR AND THE APPROPRIATE UTILITY OWNER BEFORE PROCEEDING WITH CONSTRUCTION.
- REPAIRS TO UTILITIES OR PROPERTY DAMAGE AS A RESULT OF THE CONTRACTOR'S NEGLIGENCE OR METHOD OF OPERATION MUST BE MADE AT THE CONTRACTOR'S EXPENSE BEFORE PROCEEDING WITH CONSTRUCTION.
- CALL "MISS UTILITY" AT 1-800-257-7777 FORTY-EIGHT (48) HOURS PRIOR TO BEGINNING EXCAVATION TO DETERMINE THE EXACT LOCATION OF EXISTING UTILITIES.
- CLEARING IS TO BE LIMITED TO THE "LIMIT OF GRADING" AS SHOWN ON THE PLANS.
- ALL GRADING SHALL BE DONE IN SUCH A MANNER AS TO PROVIDE POSITIVE DRAINAGE.
- ALL DISTURBED AREAS TO BE SEEDED AND MULCHED UNLESS OTHERWISE NOTED.
- THE CONTRACTOR SHALL OBTAIN A ROADSIDE TREE PERMIT FOR ANY MAINTENANCE, TREATMENT, PLANTING, REMOVAL, OR ROOT CUTTING ON TREES WITHIN THE PUBLIC RIGHT OF WAY. PERMIT REQUIREMENTS MAY BE OBTAINED FROM THE DEPARTMENT OF NATURAL RESOURCES, MARYLAND FOREST, PARK AND WILDLIFE SERVICE, TELEPHONE 301-854-6060.
- THE PERMITTEE SHALL REFER TO THE ATTACHED TEMPORARY TRAFFIC CONTROL PLAN (TTCP) DRAWINGS TO SELECT THE APPROPRIATE WORK ZONE TEMPORARY TRAFFIC CONTROLS FOR EACH PHASE OF CONSTRUCTION. WORK ZONE SITUATIONS WHICH ARE NOT ADDRESSED IN THE ATTACHED TTCP SHALL CONFORM TO THE GUIDELINES SET FORTH IN SECTION 6 OF THE MANUAL ON UNIFORM TRAFFIC CONTROL DEVICES FOR STREETS AND HIGHWAYS (MUTCD), MOST RECENT EDITION.
- FOR CONSTRUCTION, ALL HORIZONTAL AND VERTICAL CONTROLS SHALL BE NAD 83 (2007) AND NAVD 88 DATUM.

OWNER'S/DEVELOPER'S CERTIFICATION

I/We hereby certify that all clearing, grading, construction, and or development will be done pursuant to this plan and that any responsible personnel involved in the construction project will have a Certificate of Attendance at a Department of Natural Resources approved training program for the control of sediment and erosion before beginning the project.

DATE _____ JOSE THOMMANA
CHIEF, DIVISION OF TRANSPORTATION ENGINEERING

DESIGN CERTIFICATION

I hereby certify that this plan has been prepared in accordance with the "2011 Maryland Standards and Specification for Soil Erosion and Sediment Control," Montgomery County Department of Permitting Services Executive Regulations 5-90, 7-02AM and 36-90, and Montgomery County Department of Public Works and Transportation "Storm Drain Design Criteria" dated August 1988.

DATE _____ MICHAEL MERCADO, P.E.
MERCADO CONSULTANTS, INC.

CERTIFICATION OF THE QUANTITIES

I hereby certify that the estimated total yards of excavation and fill as shown on this plan has been computed to 250 cubic yards of excavation, 70 cubic yards of fill and the total area to be disturbed as shown on these plans has been determined to be 39,184 square feet.

SIGNATURE _____ DATE _____
MICHAEL MERCADO, P.E. 38931
PRINTED NAME AND TITLE REGISTRATION NUMBER

MR2025012
WSSC MAP # 224NW01
TAX MAP ID: JT122/JT342

65% DESIGN SUBMISSION 11-20-2023

TECHNICAL REVIEW OF SEDIMENT CONTROL	ADMINISTRATIVE REVIEW	DPS APPROVAL OF A SEDIMENT CONTROL OR STORMWATER MANAGEMENT PLAN IS FOR DEMONSTRATED COMPLIANCE WITH MINIMUM ENVIRONMENTAL RUNOFF TREATMENT STANDARDS AND DOES NOT CREATE OR IMPLY ANY RIGHT TO DIVERT OR CONCENTRATE RUNOFF ONTO ANY ADJACENT PROPERTY WITHOUT THAT PROPERTY OWNER'S PERMISSION. IT DOES NOT RELIEVE THE DESIGN ENGINEER OR OTHER RESPONSIBLE PERSON OF PROFESSIONAL LIABILITY OR ETHICAL RESPONSIBILITY FOR THE ADEQUACY OF THE DRAINAGE DESIGN AS IT AFFECTS UPHILL OR DOWNHILL PROPERTIES.
REVIEWED _____ DATE _____	REVIEWED _____ DATE _____	
TECHNICAL REVIEW OF STORMWATER MANAGEMENT	SMALL LOT DRAINAGE APPROVAL	SM. FILE NO. _____ STORMWATER MANAGEMENT
REVIEWED _____ DATE _____	REVIEWED _____ DATE _____	
MCDPS APPROVAL OF THIS PLAN WILL EXPIRE TWO YEARS FROM THE DATE OF APPROVAL IF THE PROJECT HAS NOT STARTED.	NOTE: MCDPS APPROVAL DOES NOT NEGATE THE NEED FOR A MCDPS ACCESS PERMIT.	
MONTGOMERY COUNTY DEPARTMENT OF TRANSPORTATION DIVISION OF TRANSPORTATION ENGINEERING GAITHERSBURG, MARYLAND		NORWOOD ROAD SHARED USE PATH
RECOMMENDED FOR APPROVAL		
Chief, Design Section _____ Date _____ APPROVED	Chief, Division of Transportation Engineering _____ Date _____	TITLE SHEET
Designed by : MWM Drawn by : NL Checked by : MWM		SCALE : AS SHOWN DATE : NOVEMBER, 2023 Project No. : 502313 SHEET 1 of 20

TREE CANOPY REQUIREMENTS TABLE	
To be completed by the consultant and placed on the first sheet of the Sediment Control / Stormwater Management plan set for all projects.	
Exempt: Yes <input type="checkbox"/> No <input checked="" type="checkbox"/> If exempt under Section 55-5 of the Code, please check the applicable exemption category below.	
Total Property Area	Total Disturbed Area
505,778 square feet	39,184 square feet
Shade Trees Required	Shade Trees Proposed to be Planted
15	0
Fee in Lieu (Trees Required - Trees Planted) x \$250	\$ 3,750
Required Number of Shade Trees	
Area (sq. ft.) of the Limits of Disturbance	Number of Shade Trees Required
FROM TO	
1 6,000	3
6,001 8,000	6
8,001 12,000	9
12,001 14,000	12
14,001 40,000	15
If the square footage of the limits of disturbance is more than 40,000, then the number of shade trees required must be calculated using the following formula: (Number of Square Feet in Limits of Disturbance ÷ 40,000) x 15	
EXEMPTION CATEGORIES:	
<input type="checkbox"/> 55-5(a) any activity that is subject to Article II of Chapter 22A; <input type="checkbox"/> 55-5(b) any commercial logging or timber harvesting operation with an approved exemption from Article II of Chapter 22A; <input type="checkbox"/> 55-5(f) any activity conducted by the County Parks Department; <input type="checkbox"/> 55-5(g) routine or emergency maintenance of an existing stormwater management facility, including an existing access road, if the person performing the	maintenance has obtained all required permits; <input type="checkbox"/> 55-5(h) any stream restoration project if the person performing the work has obtained all necessary permits; <input type="checkbox"/> 55-5(i) cutting or clearing any tree to comply with applicable provisions of any federal, state, or local law governing safety of dams; <input type="checkbox"/> OTHER: Specify per Section 55-5 of the Code.



NO.	REVISION	DATE	BY

PROFESSIONAL CERTIFICATION:
I HEREBY CERTIFY THAT THESE DOCUMENTS WERE PREPARED OR APPROVED BY ME, AND THAT I AM A DULY LICENSED PROFESSIONAL ENGINEER UNDER THE LAWS OF THE STATE OF MARYLAND.
LICENSE NO: 38931 EXPIRATION DATE: 12-22-2023

ABBREVIATIONS

AASHTO..... American Association of State Highway Transportation Officials	HP..... High Point	R.Q.D..... Rock Quality Designation
ADT..... Average Daily Traffic	IN..... Inch	R.M..... Rootmat
AHD..... Ahead	INV..... Invert	S..... South
APPROX..... Approximate	J.B..... Junction Box	SAN..... Sanitary Sewer
□ or B/L..... Baseline	K..... K Inlet	SB or S/B..... Southbound
BK..... Back / Book	L..... Length	S.D..... Storm Drain
BIT..... Bituminous	LF..... Linear Feet	S.D.D..... Surface Drain Ditch
B.C..... Bituminous Concrete	LL..... Liquid Limit	S/E..... Super Elevation
B.M..... Bench Mark	LOD..... Limit of Disturbance	SF..... Silt Fence
BOT..... Bottom	LP..... Low Point	SF..... Square Feet
C.C..... Center of Curve	L.P..... Light Pole	SHT..... Sheet
CAP..... Corrugated Aluminum Pipe	LT..... Left	SPP..... Structural Steel Plate Pipe
CAPA..... Corrugated Aluminum Pipe Arch	MAC..... Macadam	SPPA..... Structural Steel Plate Pipe Arch
CATV..... Cable Television	M.C..... Moisture Content	S.P.T..... Standard Penetration Testing
C.B.R..... California Bearing Ratio	MAX..... Maximum	SRP..... Steel Spiral Rib Pipe -
□ or C/L..... Centerline	M.D.D..... Maximum Dry Content	Aluminized Type 2
CL..... Class	MOD..... Modified	SRPA..... Steel Spiral Rib Pipe Arch -
CLF..... Chainlink Fence	MIN..... Minimum	Aluminized Type 2
CMP..... Corrugated Metal Pipe	N..... North	SSD..... Stopping Sight Distance
C.O..... Cleanout	NB..... Northbound	SSF..... Super Silt Fence
COMB..... Combination	NE..... Northeast	STD..... Standard
CONC..... Concrete	N.P..... Non-Plastic	STA..... Station
CONSTR..... Construction	O.C..... On Center	SO..... Single Opening
COR..... Corner	OHE..... Overhead Electric	SY..... Square Yards
CORR..... Correction	O.M..... Optimum Moisture	SWM..... Stormwater Management
CPP-S..... Corrugated Polyethylene Pipe - Type 'S'	PAV'T..... Pavement	T..... Tangent
CSP..... Corrugated Steel Pipe - Aluminized Type 2	PC..... Point of Curvature	T..... Telephone
CSPA..... Corrugated Steel Pipe Arch -	PCC..... Point of Compound Curvature	T.C..... Top of Cover
Aluminized Type 2	P/C..... Point of Crown	T.G..... Top of Grate
DC..... Degree of Curve	P/GE..... Profile Grade Elevation	T or TL..... Traverse Line
D.H.V..... Design Hourly Volume	P.G.E..... Profile Ground Elevation	T.M..... Top of Manhole
D.I..... Drop Inlet	P.G.L..... Profile Grade Line	TRAV..... Traverse
DIA..... Diameter	P/GL..... Profile Ground Line	TS..... Temporary Swale
D.O..... Double Opening	P/R..... Point of Rotation	T.S..... Top of Slab
E..... East	P.I..... Plasticity Index	T.S..... Topsoil
E..... Electric	PI..... Point of Intersection	TYP..... Typical
E..... External Distance	POC..... Point On Curve	U.D..... Under Drain
EA..... Each	POT..... Point On Tangent	U.G..... Underground
EB..... Eastbound	PPWP..... Polyvinyl Chloride Profile Wall Pipe	U.P..... Utility Pole
ELEV..... Elevation	PROP..... Proposed	US EPA..... United States Environmental
ES..... End Section	PRC..... Point of Reverse Curve	Protection Agency
ESC..... Erosion and Sediment Control	PT..... Point	USDA..... United States Department
EX or EXIST..... Existing	PT..... Point of Tangency	of Agriculture
FT..... Feet	PVC..... Point of Vertical Curve	VCL..... Vertical Clearance
F or FL..... Flowline	PVC..... Polyvinyl Chloride	V.C.L..... Vertical Curve Length
F.B.D..... Flat Bottom Ditch	PVI..... Point of Vertical Intersection	W..... Water
F.H..... Fire Hydrant	PVRC..... Point of Vertical Reverse Curve	W..... West
FWD..... Forward	PVT..... Point of Vertical Tangency	WB..... Westbound
G..... Gas	R..... Radius	WB..... Wetland Buffer
G.V..... Gas Valve	R.F..... Rock Fragments	W.M..... Water Meter
H.B..... Handbox	RT..... Right	W.S..... Wrapped Steel
HDWL..... Headwall	RW or R/W..... Right of Way	WUS..... Waters of the United States
HERCP..... Horizontal Elliptical Reinforced	RCP..... Reinforced Concrete Pipe	W.V..... Water Valve
Concrete Pipe	RCP..... Reinforced Concrete Pressure Pipe	

SOILS LEGEND

A-3 SAND	A-2-7 CLAYEY SAND	A-7-4 SILTY CLAY
A-2 SAND & FINES	A-7-2 SANDY CLAY	A-7 CLAY
A-2-4 SILTY SAND	A-4 SILT	A-6 COLLOIDAL CLAY
A-4-2 SANDY SILT	A-4-7 CLAYEY SILT	A-5 MICA, DIATOMS

PLAN LOCATION OF SOIL BORINGS BORING TARGETS AND PROFILES SCALE:
HORIZONTAL - NONE
VERTICAL - SEE PROFILE SHEETS

A0-ABOVE OPTIMUM
SAT-SATURATED
LIQ-LIQUEFIED

LL-LIQUID LIMIT (%)
PI-PLASTICITY INDEX (%)
NP-NON-PLASTIC
OMC-OPTIMUM MOISTURE CONTENT (%)
USC-UNIFIED SOIL CLASSIFICATION
USDA-UNITED STATES DEPARTMENT OF AGRICULTURE CLASSIFICATION


TS-TOPSOIL
RM-ROOT MAT
BC-BITUMINOUS CONCRETE
SB-STONE BASE
PCC-PORTLAND CEMENT CONCRETE

W/GR-WITH GRAVEL
W/R-F-WITH ROCK FRAGMENTS

NOTES: SOIL SYMBOLS DENOTE MSMT CLASSIFICATIONS
ALL DIMENSIONS, DEPTHS AND ELEVATIONS ARE NOTED IN FEET
AN ASTERISK AT THE TOP DEPTH OF STRATA INDICATES THAT STRATA WAS VISUALLY CLASSIFIED BY DRILLER
MDD & OMC PER A.A.S.H.T.O. DESIGNATION T-180
N PER A.A.S.H.T.O. DESIGNATION T-206

UNLESS OTHERWISE NOTED ON PLANS, ALL SOIL SURVEY BORINGS FOR ROADWAY CONSTRUCTION WERE LEFT OPEN FOR 24 HOURS WITH NO EXCESS MOISTURE OR FREE WATER ENCOUNTERED DURING TIME OF SOIL SURVEY (09/2000 TO 06/2002)

SOIL BORING PROFILE EXAMPLE

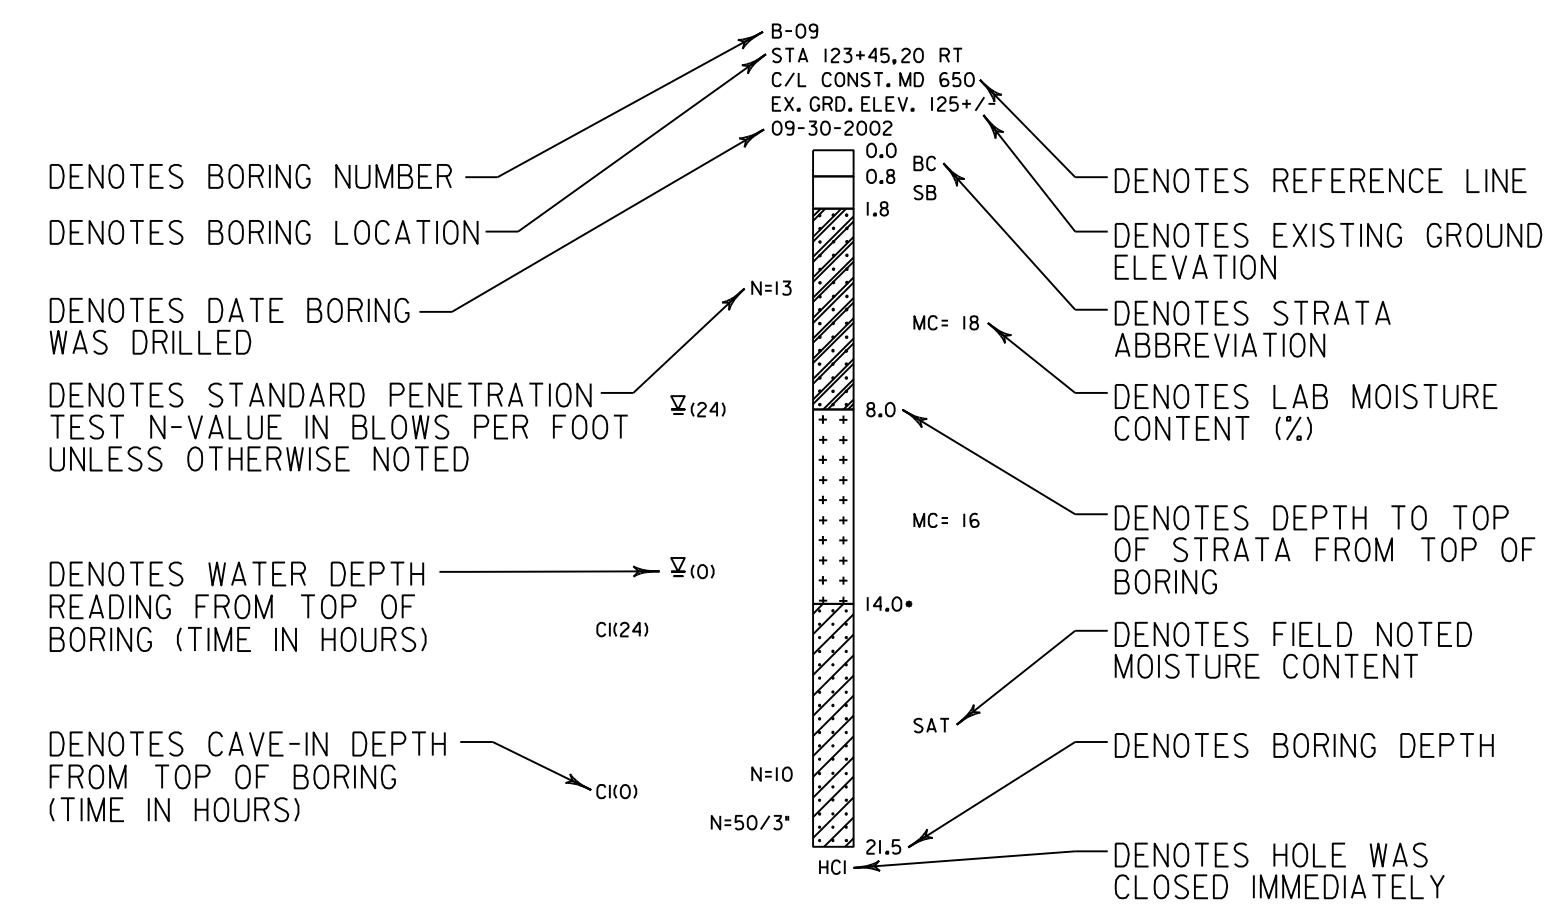












SOILS TEST DATA								
BORING NUMBER	SAMPLE DEPTH	LL	PI	USDA	USC	MDD	OMC	REMARKS
B-09	1.8 - 8.0	18	NP	Sandy Loam	-	-	-	with Gravel
B-09	8.0 - 14.0	41	22	Silty Clay Loam	CL	121	12	-

CONVENTIONAL SIGNS


PROPOSED MEDIAN BARRIER		EXISTING 100 YEAR FLOODPLAIN BOUNDARY	
ELECTRICAL HAND BOX - SIGNALS		PROPOSED 100 YEAR FLOODPLAIN BOUNDARY	
FLOW LINE		WETLAND BOUNDARY	
STATE, COUNTY OR CITY LINES		PROPOSED PIPE / CULVERT	
PROPOSED TRAFFIC BARRIER W-BEAM		EXISTING PIPE / CULVERT	
EXISTING TRAFFIC BARRIER W-BEAM		EXISTING DROP INLET	
PROPOSED FENCE LINE		UTILITY POLE	
EXISTING FENCE LINE		EXISTING WATER	
PROPOSED CURB AND GUTTER		EXISTING SANITARY SEWER	
R/W LINE		EXISTING ELECTRIC	
TEMPORARY CONSTRUCTION EASEMENT		EXISTING OVERHEAD ELECTRIC	
EXISTING ROADWAY		EXISTING FIBER OPTIC	
BASE LINE OR SURVEY LINE		EXISTING TELEPHONE	
FIRE HYDRANT		WETLAND	
HISTORIC BOUNDARY		WETLAND BUFFER	
PARK BOUNDARY		WATERS OF THE U.S.	
WATER LINE		HEDGE /TREE LINE	
OVERHEAD ELECTRIC		BUSH /TREE	
TRAFFIC BARRIER		CONIFEROUS TREE	
		GROUND ELEVATION	
		GRADE ELEVATION	
		PIPE TO BE REMOVED	
		PIPE TO BE ABANDONED	
		DIRECTION OF TRAFFIC FLOW	

<p>MONTGOMERY COUNTY DEPARTMENT OF TRANSPORTATION ROCKVILLE, MARYLAND</p>				<p>MONTGOMERY COUNTY DEPARTMENT OF TRANSPORTATION DIVISION OF TRANSPORTATION ENGINEERING</p>			
				<p>NORWOOD ROAD SHARED USE PATH</p>			
<p>RECOMMENDED FOR APPROVAL</p> <p>Chief, Transportation Planning and Design Section _____ Date _____</p> <p>APPROVED</p> <p>Chief, Division of Transportation Engineering _____ Date _____</p>				<p>NOTES AND ABBREVIATIONS</p> <p>SCALE NONE DATE NOVEMBER, 2023</p>			
NO.	REVISION	DATE	BY	DESIGNED BY RA	DRAWN BY NM	CHECKED BY MWM	SHEET NO. 2 OF 20




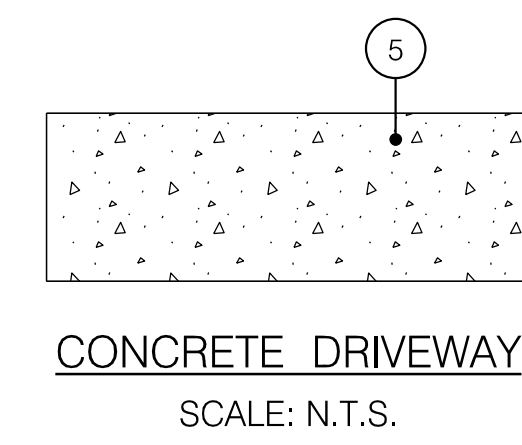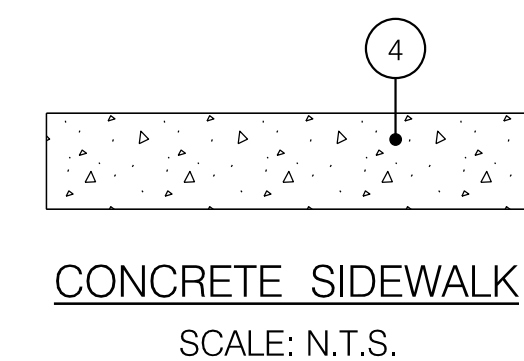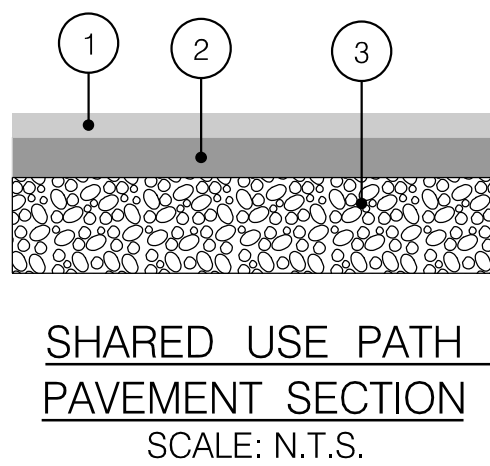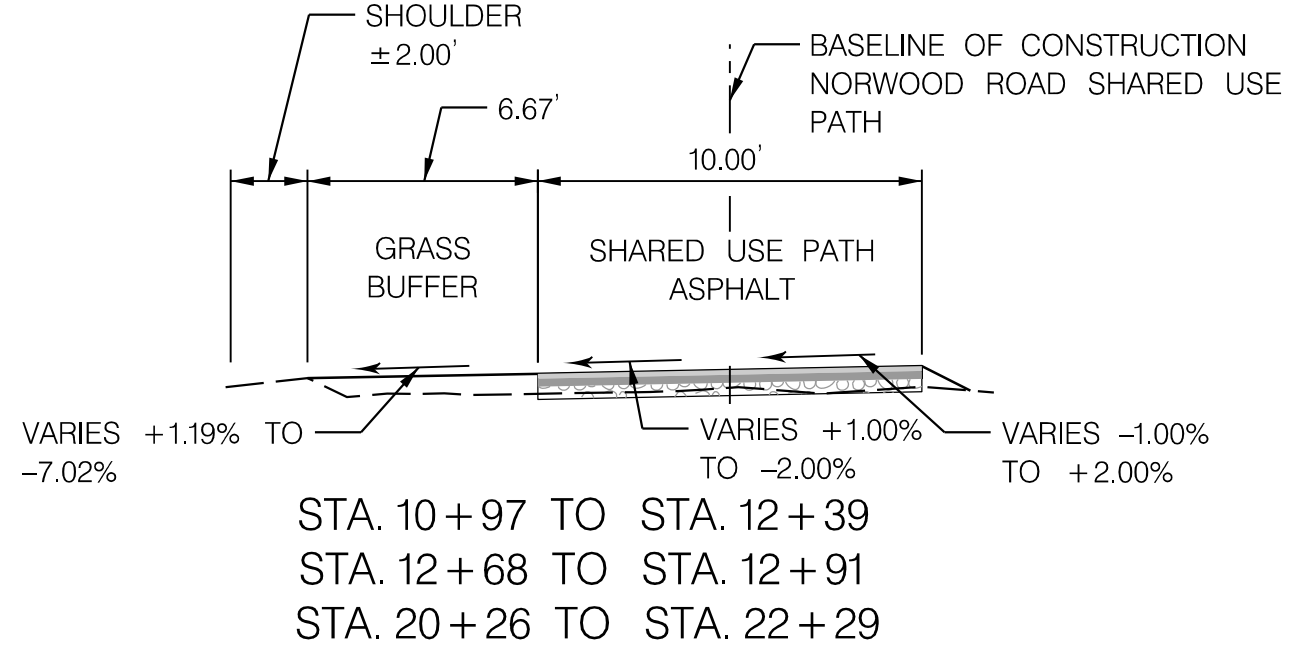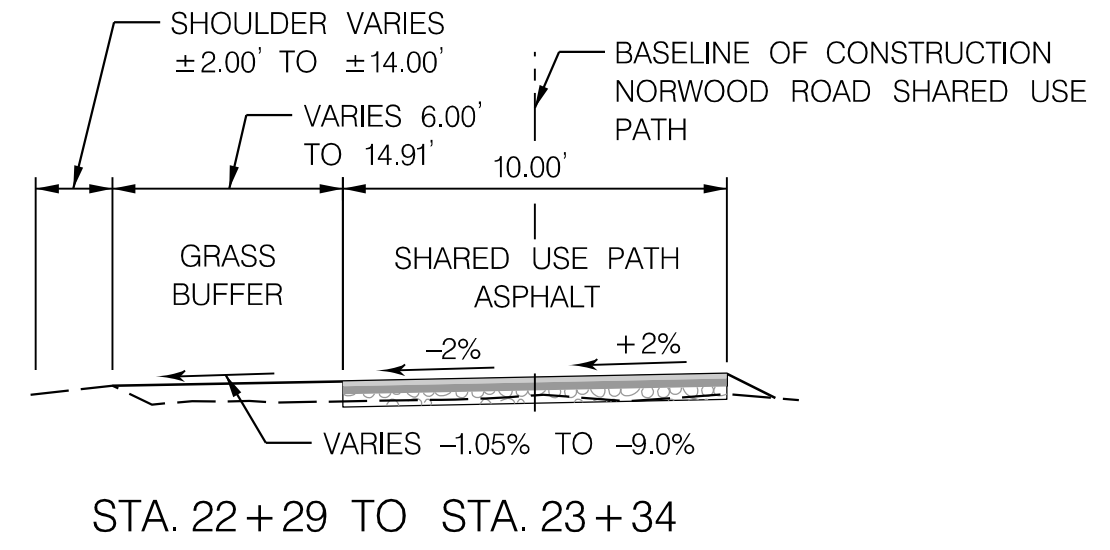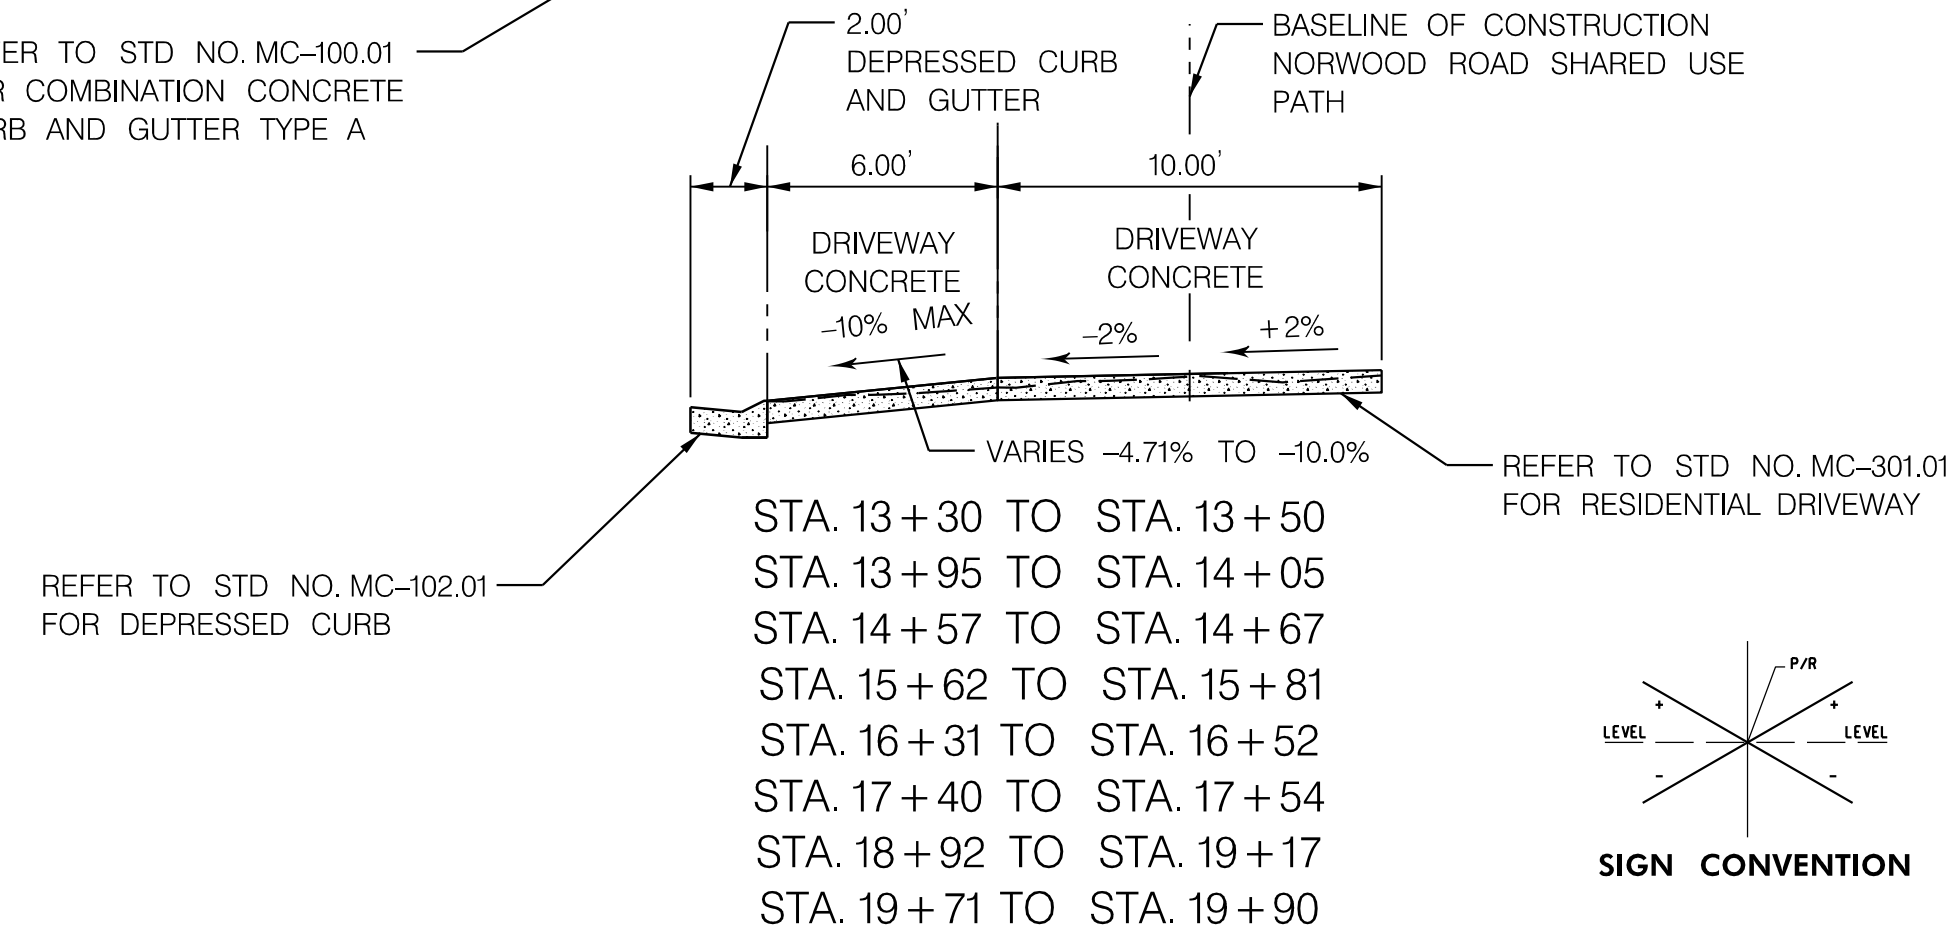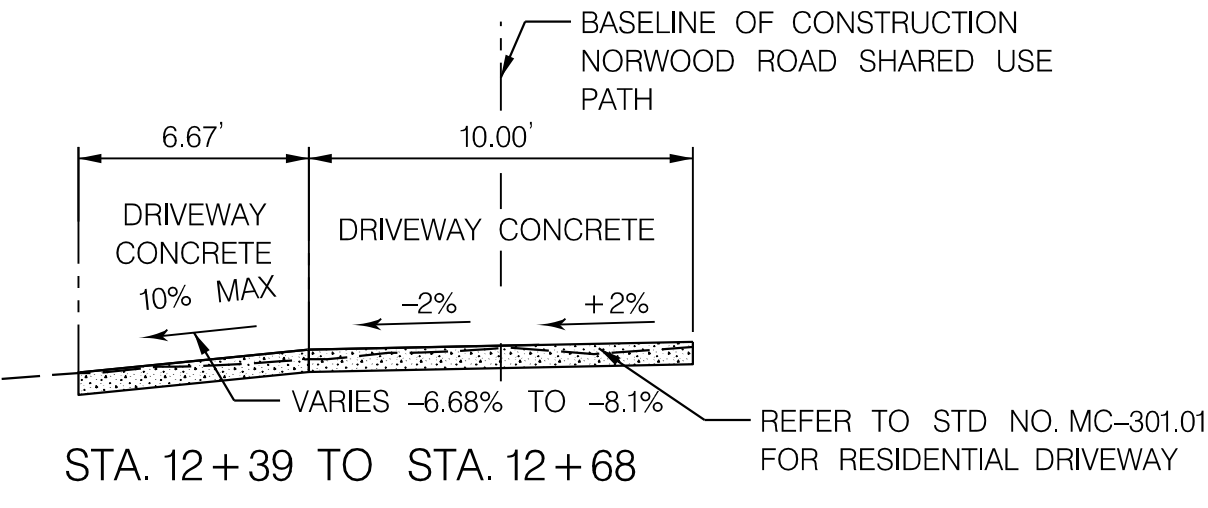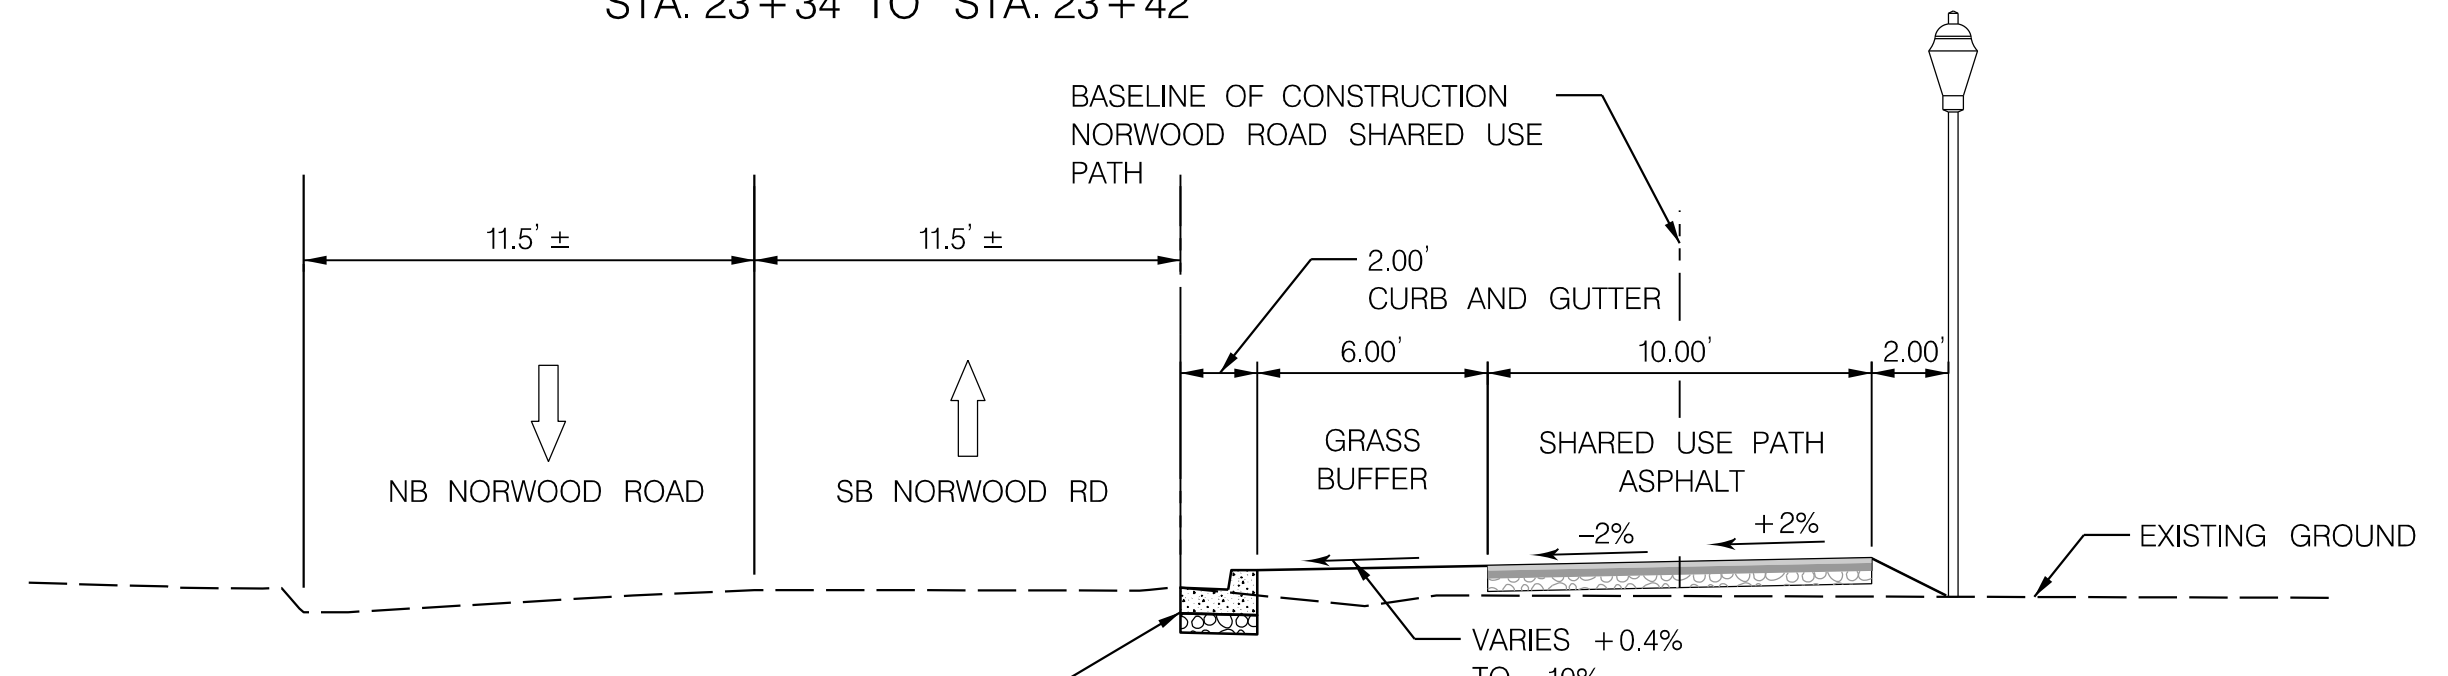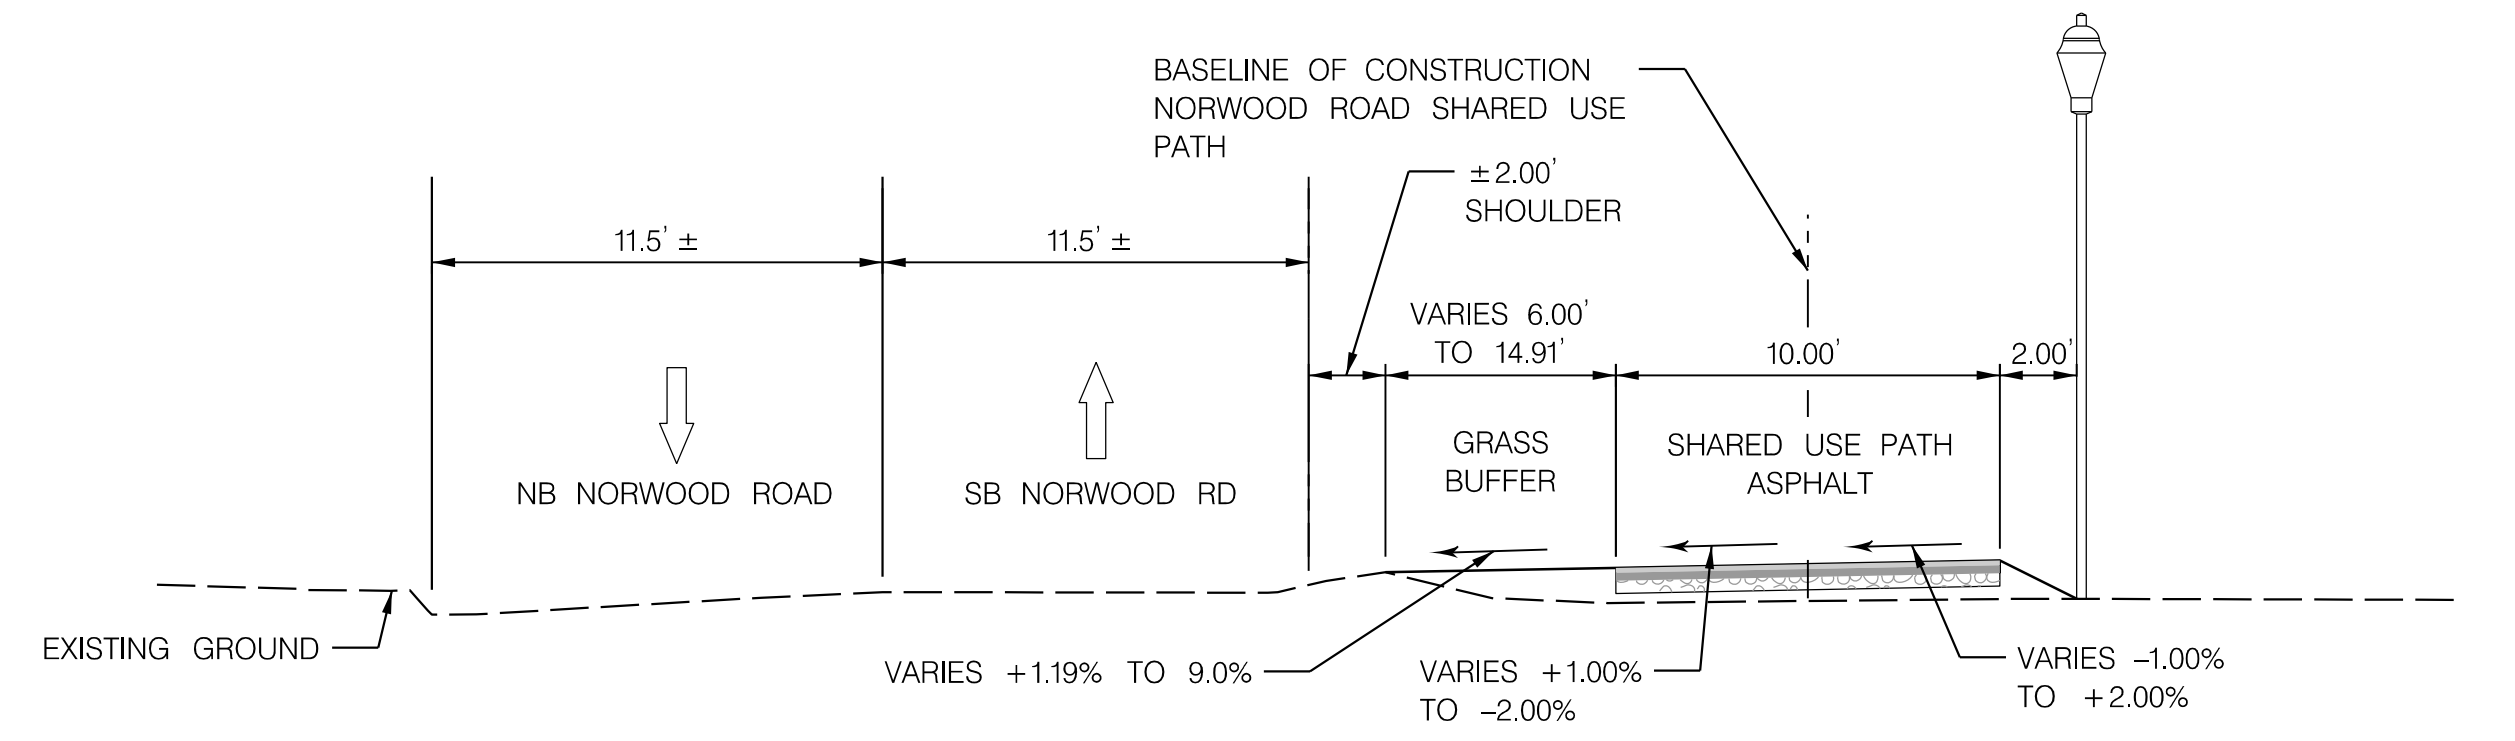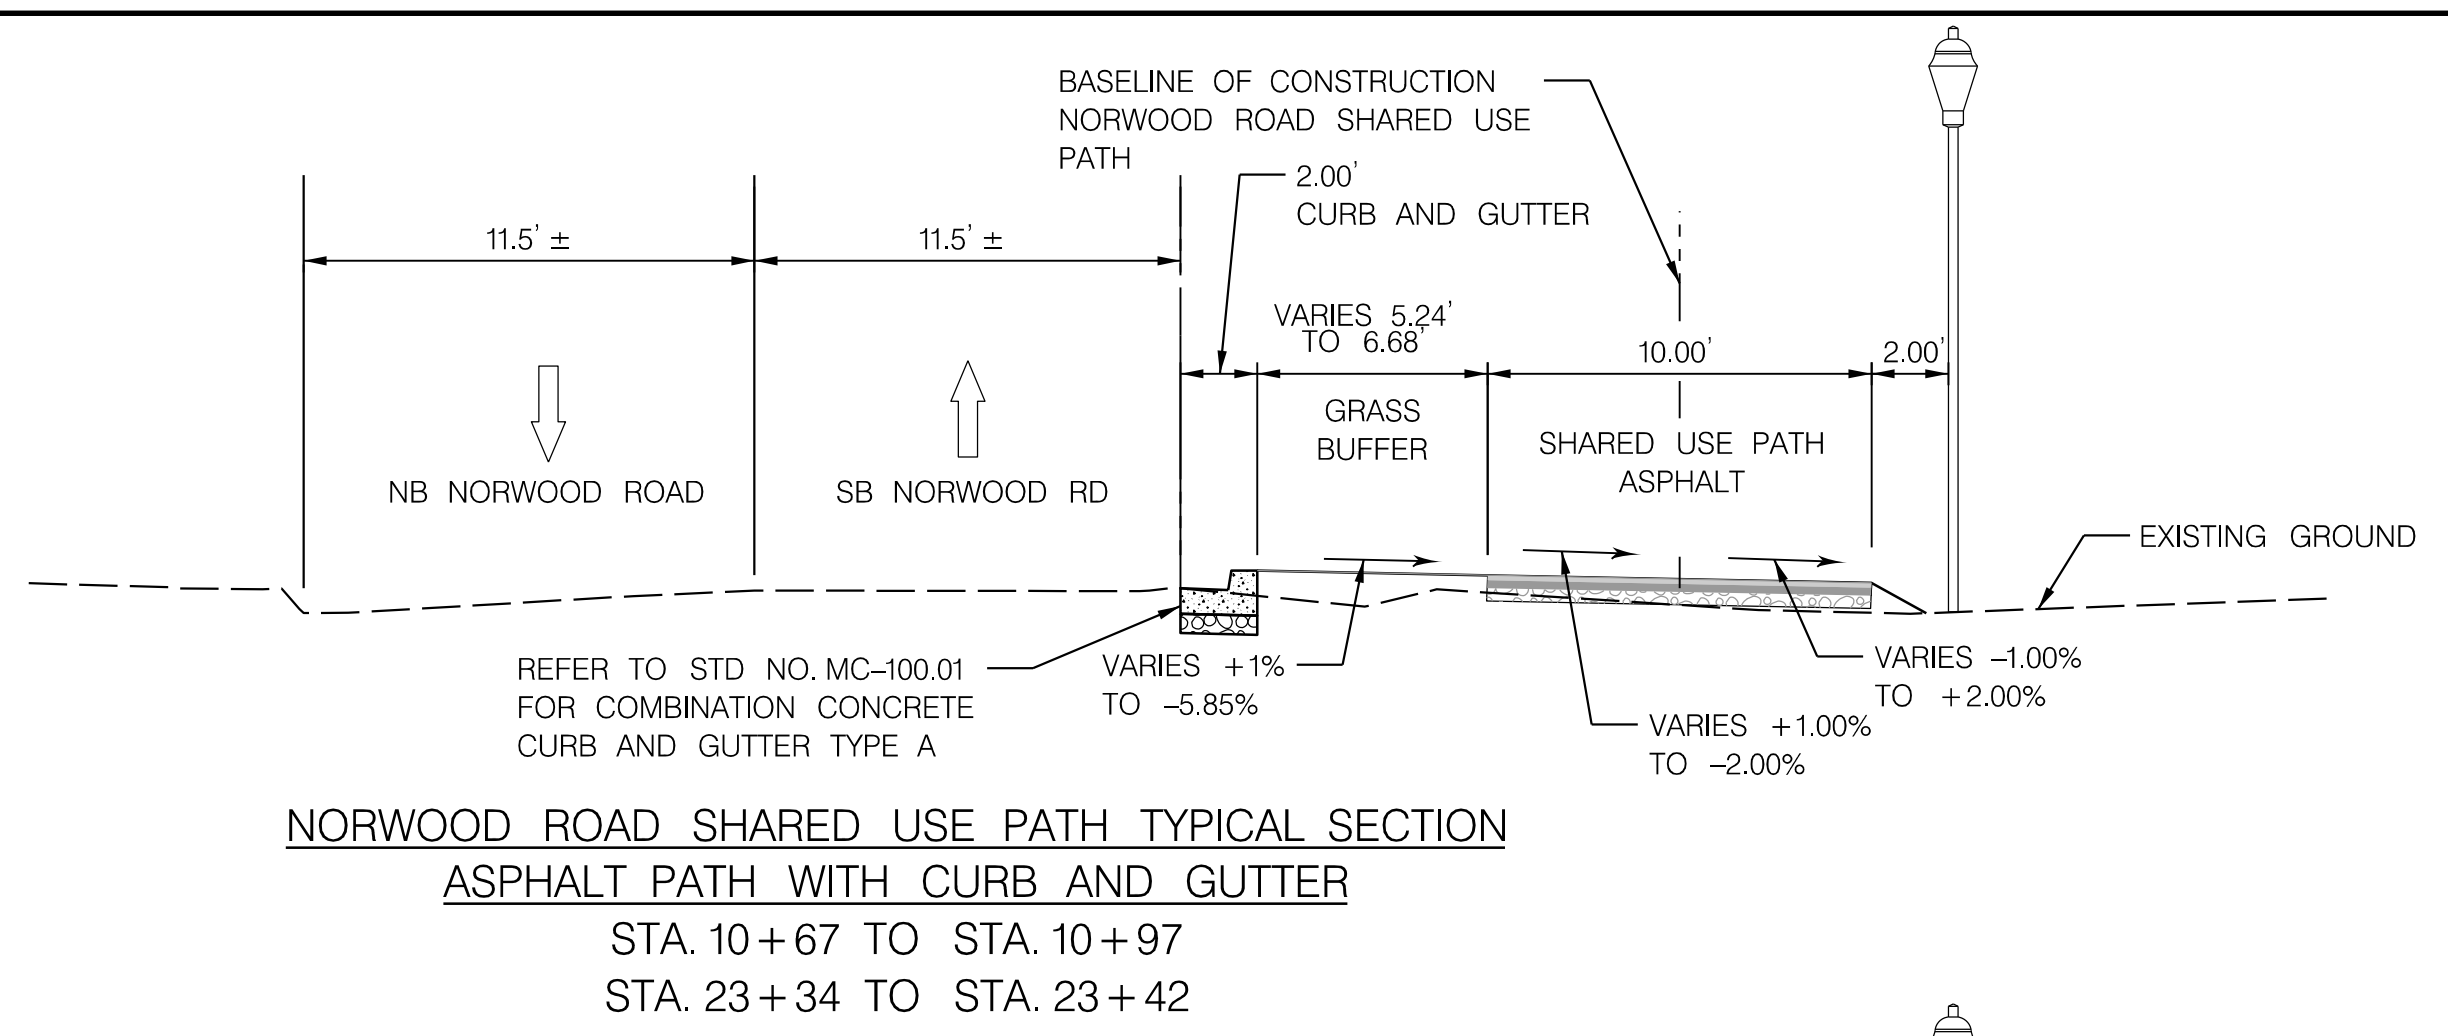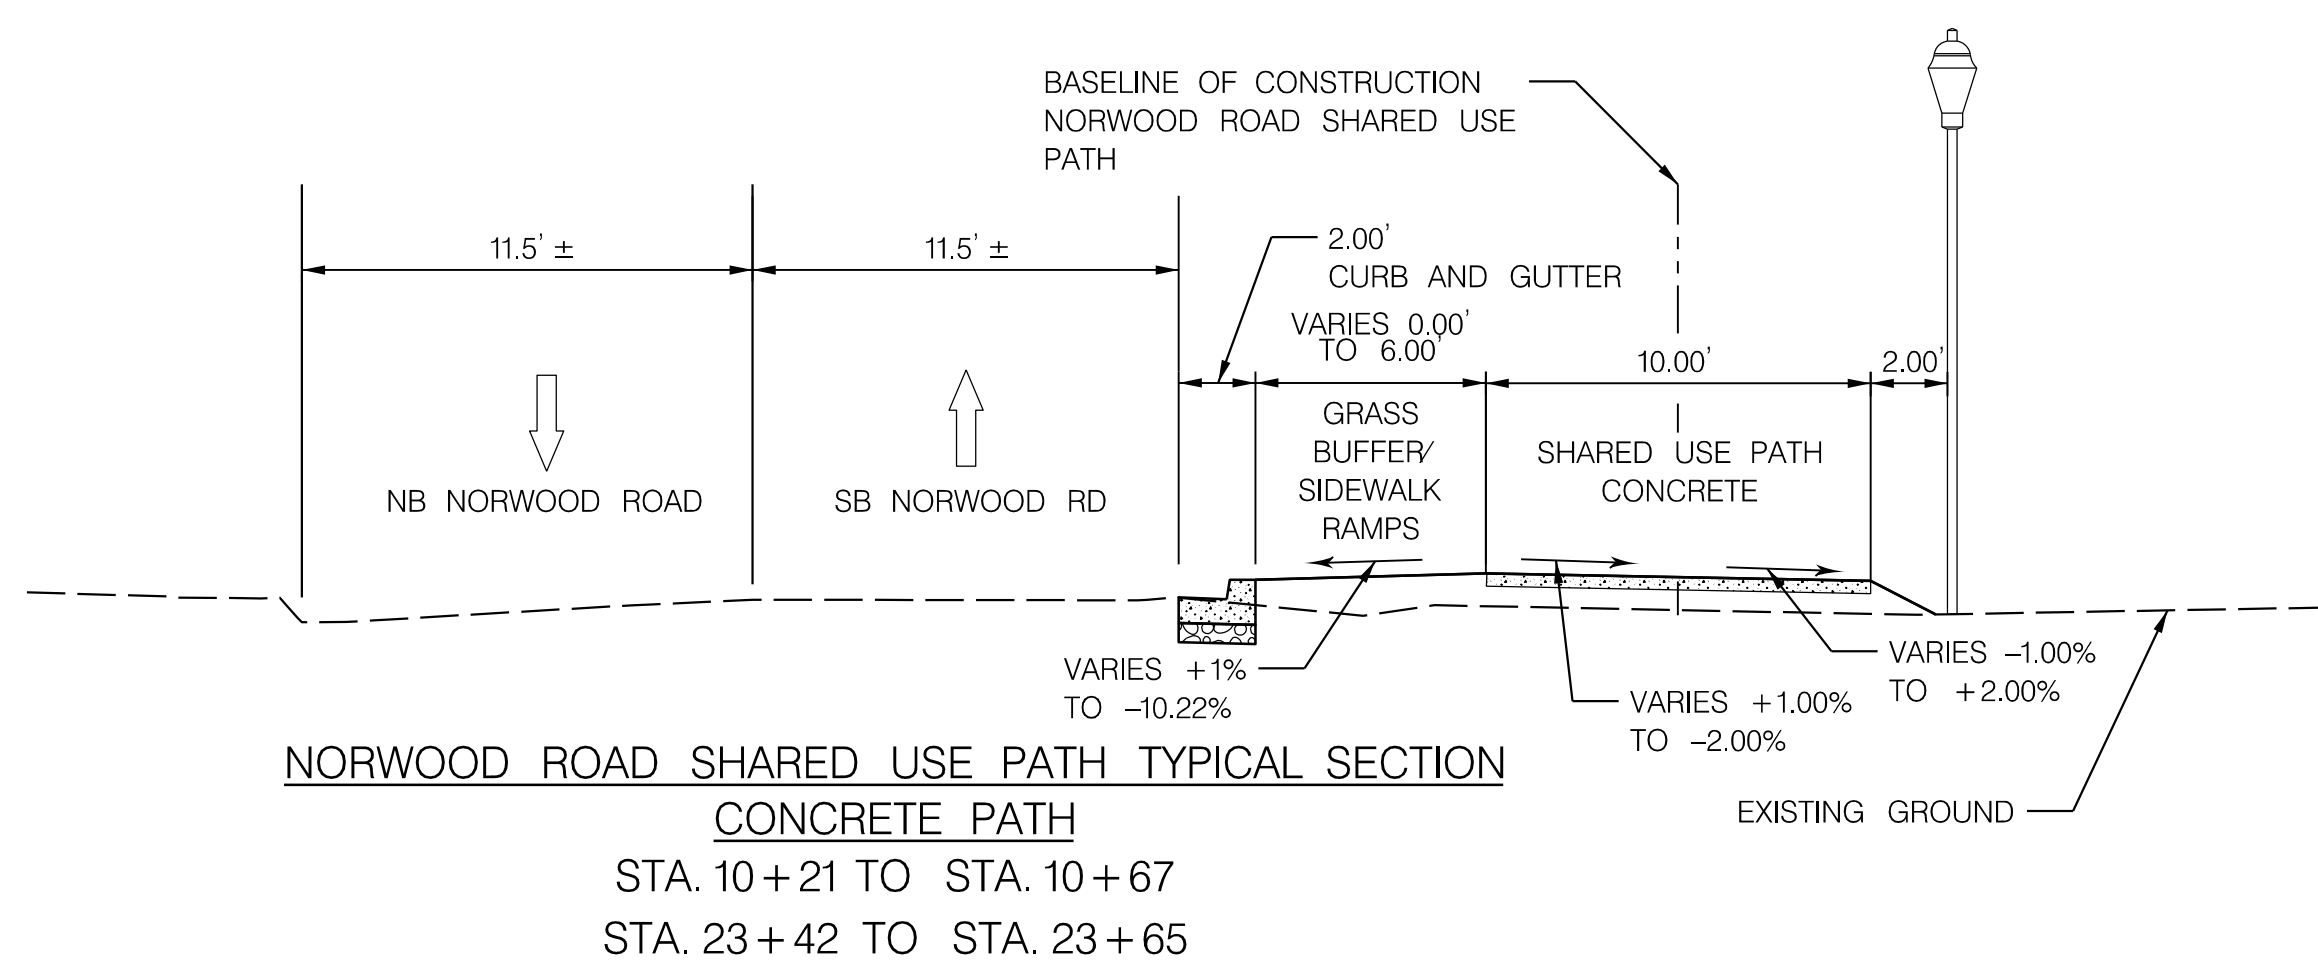

- PAVEMENT LEGEND**
- ① 1.5" BITUMINOUS CONCRETE SURFACE COURSE (ASPHALT)
 - ② 2.5" BITUMINOUS CONCRETE BASE COURSE (ASPHALT)
 - ③ 4" GRADED AGGREGATE BASE
 - ④ 4" CONCRETE FOR SIDEWALK
 - ⑤ 7" CONCRETE FOR DRIVEWAY

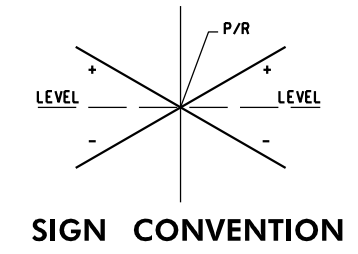

NORWOOD ROAD SHARED USE PATH TYPICAL SECTION ASPHALT PATH AND CONCRETE DRIVEWAY
 STA. 10+97 TO STA. 12+39
 STA. 12+68 TO STA. 12+91
 STA. 20+26 TO STA. 22+29

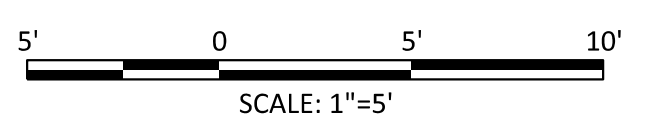

NORWOOD ROAD SHARED USE PATH TYPICAL SECTION ASPHALT PATH AND CONCRETE DRIVEWAY WITH CURB AND GUTTER
 STA. 12+91 TO STA. 20+26

NO.	REVISION	DATE	BY

MONTGOMERY COUNTY
 DEPARTMENT OF TRANSPORTATION
 ROCKVILLE, MARYLAND

RECOMMENDED FOR APPROVAL

Chief, Transportation Planning and Design Section _____ Date _____

APPROVED

Chief, Division of Transportation Engineering _____ Date _____

DESIGNED BY RA DRAWN BY NM CHECKED BY MWM

MONTGOMERY COUNTY
 DEPARTMENT OF TRANSPORTATION
 DIVISION OF TRANSPORTATION ENGINEERING

NORWOOD ROAD SHARED USE PATH

TYPICAL SECTIONS



SCALE 1"=5' DATE NOVEMBER, 2023

SHEET NO. 3 OF 20



PLOTTER: 11x17s24s
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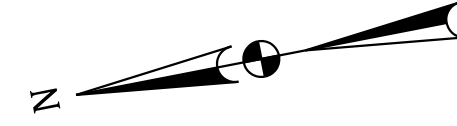
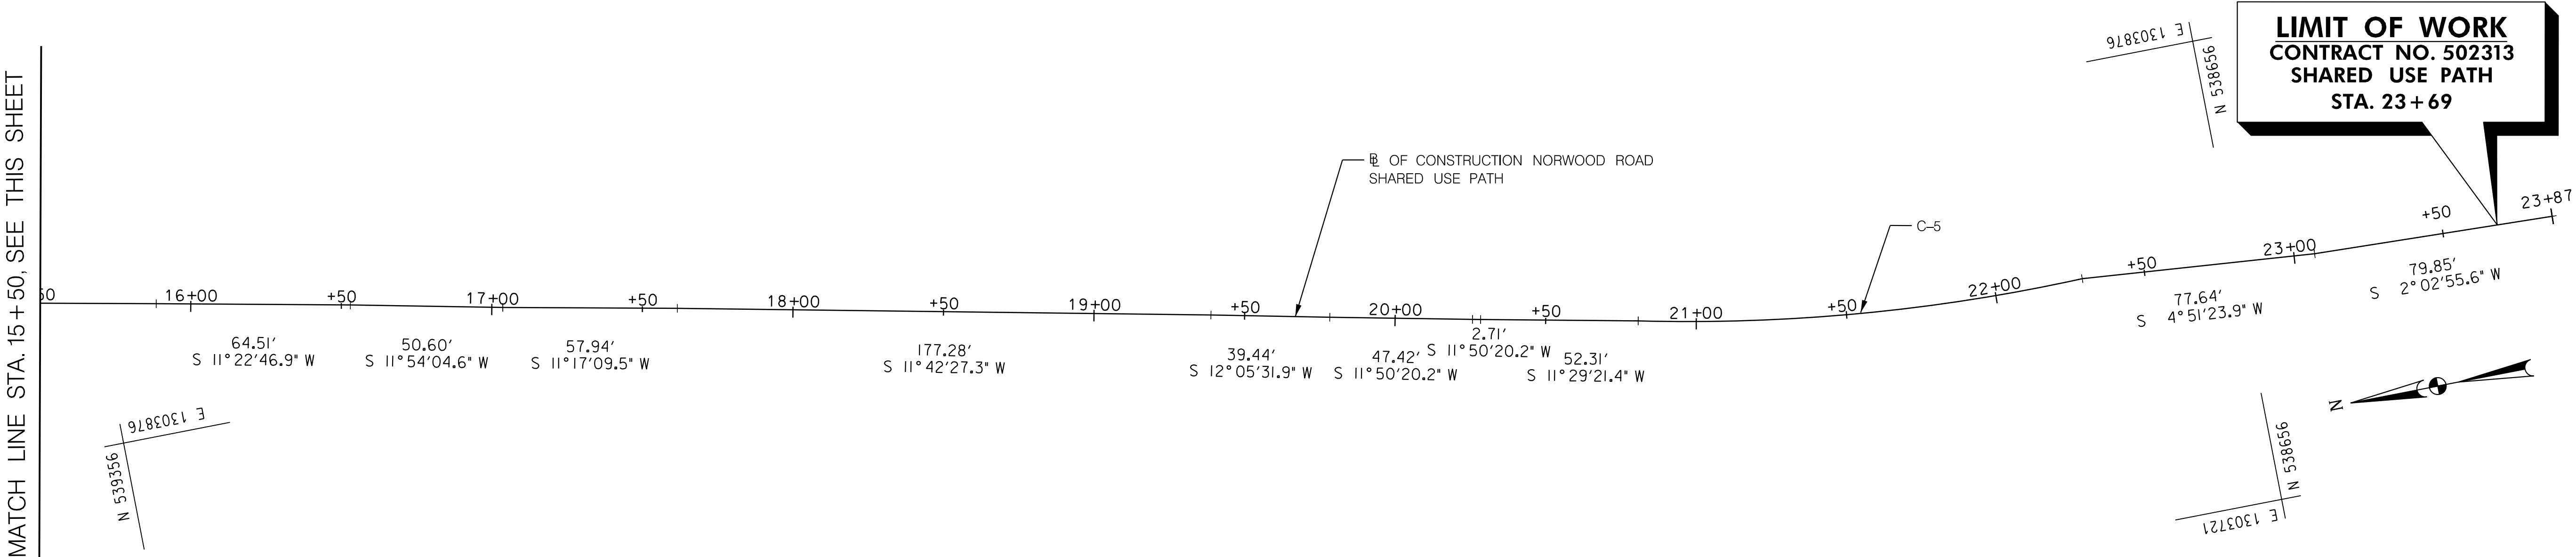
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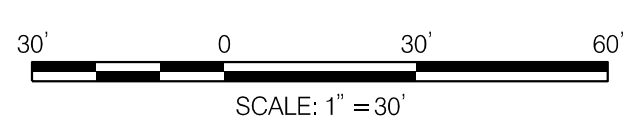
CURVE	POINT NO.	STATION	NORTH	EAST	BEARING
			BASELINE OF CONSTRUCTION	SANDY SPRING BIKE PATH	
C-1	POB	10+00.00	539860.8066	1303964.5451	N 74° 44' 43.77" E
	PC	10+36.67	539870.4539	1303999.9199	
	PI	10+46.17	539872.9534	1304009.0852	
C-2	PCC	10+51.59	539863.7941	1304011.5829	S 15° 15' 16.2274" E
	PI	10+59.13	539856.5191	1304013.5796	
C-3	PCC	10+66.65	539849.0396	1304014.5644	S 7° 30' 02.9937" E
	PI	10+82.10	539833.7293	1304016.5803	
C-4	PCC	10+97.34	539818.4557	1304014.3026	S 8° 28' 54.2865" W
	PI	10+99.56	539816.254	1304013.9743	
	PT	11+01.79	539814.0673	1304013.5571	
	PT	12+75.79	539643.154	1303980.9523	
	PT	12+91.14	539628.0995	1303977.9244	
C-5	PT	13+63.70	539556.9678	1303963.6174	S 11° 22' 20.5893" W
	PT	14+73.30	539449.5692	1303941.7627	
	PT	15+88.52	539336.543	1303919.3764	
	PT	16+53.03	539273.3023	1303906.6482	
	PT	17+03.63	539223.7891	1303896.213	
	PT	17+61.57	539166.9657	1303884.873	
	PT	19+38.85	538993.374	1303848.8999	
	PT	19+78.29	538954.8138	1303840.6388	
	PT	20+25.71	538908.4044	1303830.9105	
	PT	20+28.41	538905.7546	1303830.355	
	PC	20+80.73	538854.4896	1303819.935	
	PI	21+55.34	538781.6667	1303803.7018	
	PT	22+29.20	538707.0803	1303805.589	
	PT	23+06.85	538629.7156	1303799.0155	
	POE	23+86.70	538549.9122	1303796.1607	

MATCH LINE STA. 15 + 50, SEE THIS SHEET

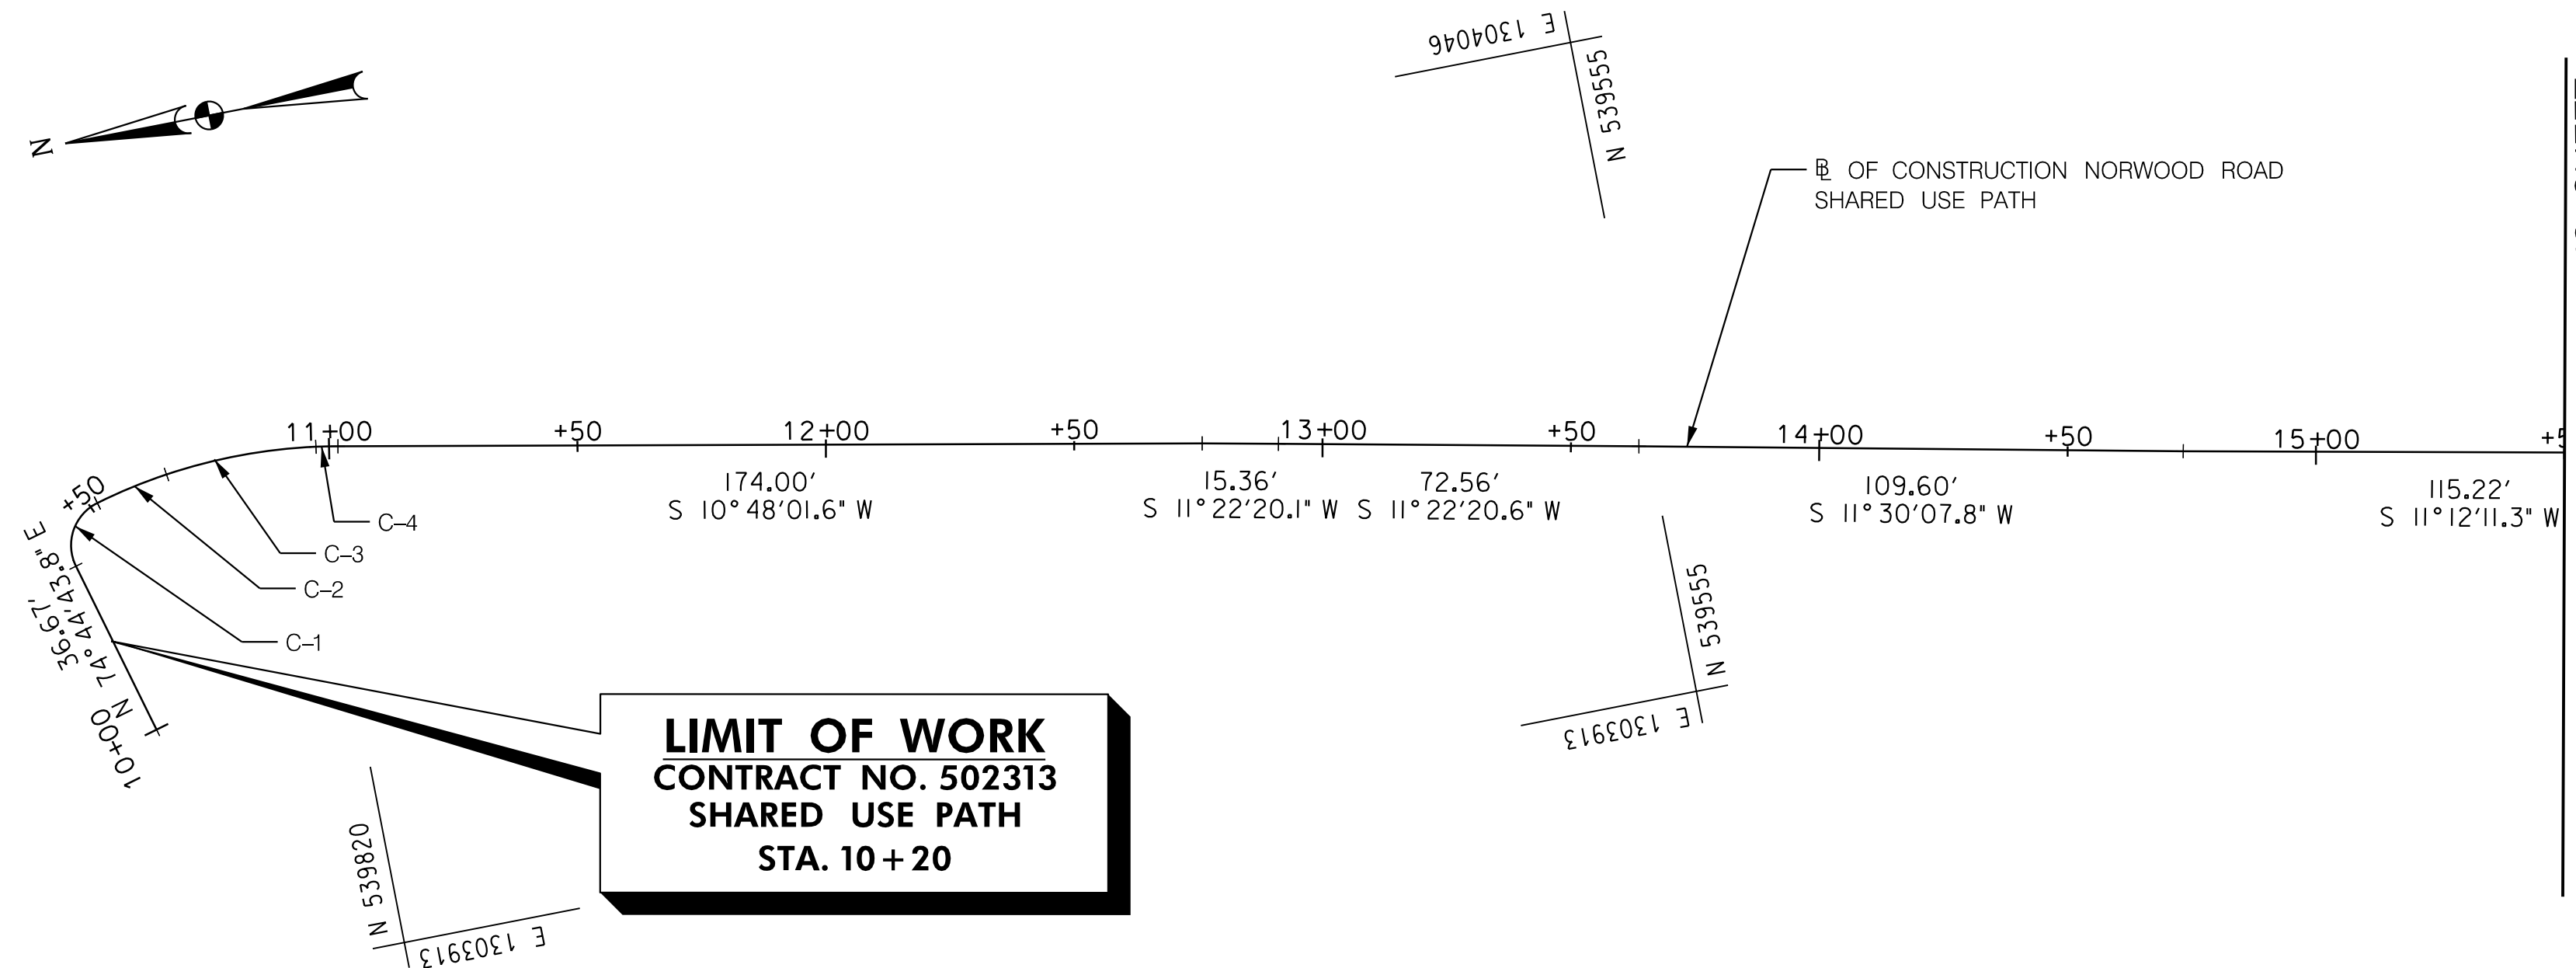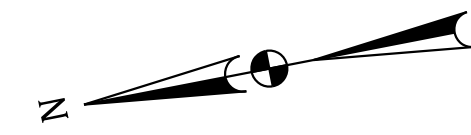MATCH LINE STA. 15 + 50, SEE THIS SHEET




CURVE DATA						
CURVE	DELTA	Dc	RADIUS	TANGENT	LENGTH	EXTERNAL
C-1	90° 00' 00.00" RT	603' 06" 55.34'	9.50	14.9225	14.9225	3.9350
C-2	7° 50' 48.07" RT	52' 05" 13.51"	110.00	7.5441	15.0646	0.2584
C-3	15° 58' 57.28" RT	52' 05" 13.51"	110.00	15.4424	30.6843	1.0787
C-4	2° 19' 07.27" RT	52' 05" 13.51"	110.00	2.2261	4.4516	0.0225
C-5	14° 00' 57.23" LT	9° 26' 23.50"	606.96	74.6103	148.4757	4.5686




MR2025012
WSSC MAP # 224NW01
TAX MAP ID: JT122/JT342

MONTGOMERY COUNTY DEPARTMENT OF TRANSPORTATION ROCKVILLE, MARYLAND		RECOMMENDED FOR APPROVAL Chief, Transportation Planning and Design Section _____ Date _____ APPROVED		
		Chief, Division of Transportation Engineering _____ Date _____		
DESIGNED BY <u>BA</u> DRAWN BY <u>NM</u> CHECKED BY <u>MMM</u>		MONTGOMERY COUNTY DEPARTMENT OF TRANSPORTATION DIVISION OF TRANSPORTATION ENGINEERING NORWOOD ROAD SHARED USE PATH GEOMETRIC SHEET SCALE <u>1" = 30'</u> DATE <u>NOVEMBER, 2023</u>		
NO.	REVISION	DATE	BY	SHEET NO. <u>4</u> OF <u>20</u>

PLOTTER: 11625626
 FILE: \\sveve01\reduced_data\1\Project\19081908\04_Sandy_Spring_Bikeway\05_Roadway\CADD\GIS-P02_Norwood.dgn

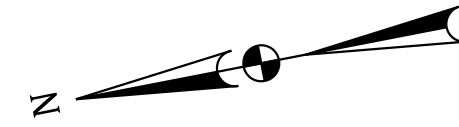

MATCH LINE STA. 17+00, SEE SHEET 5

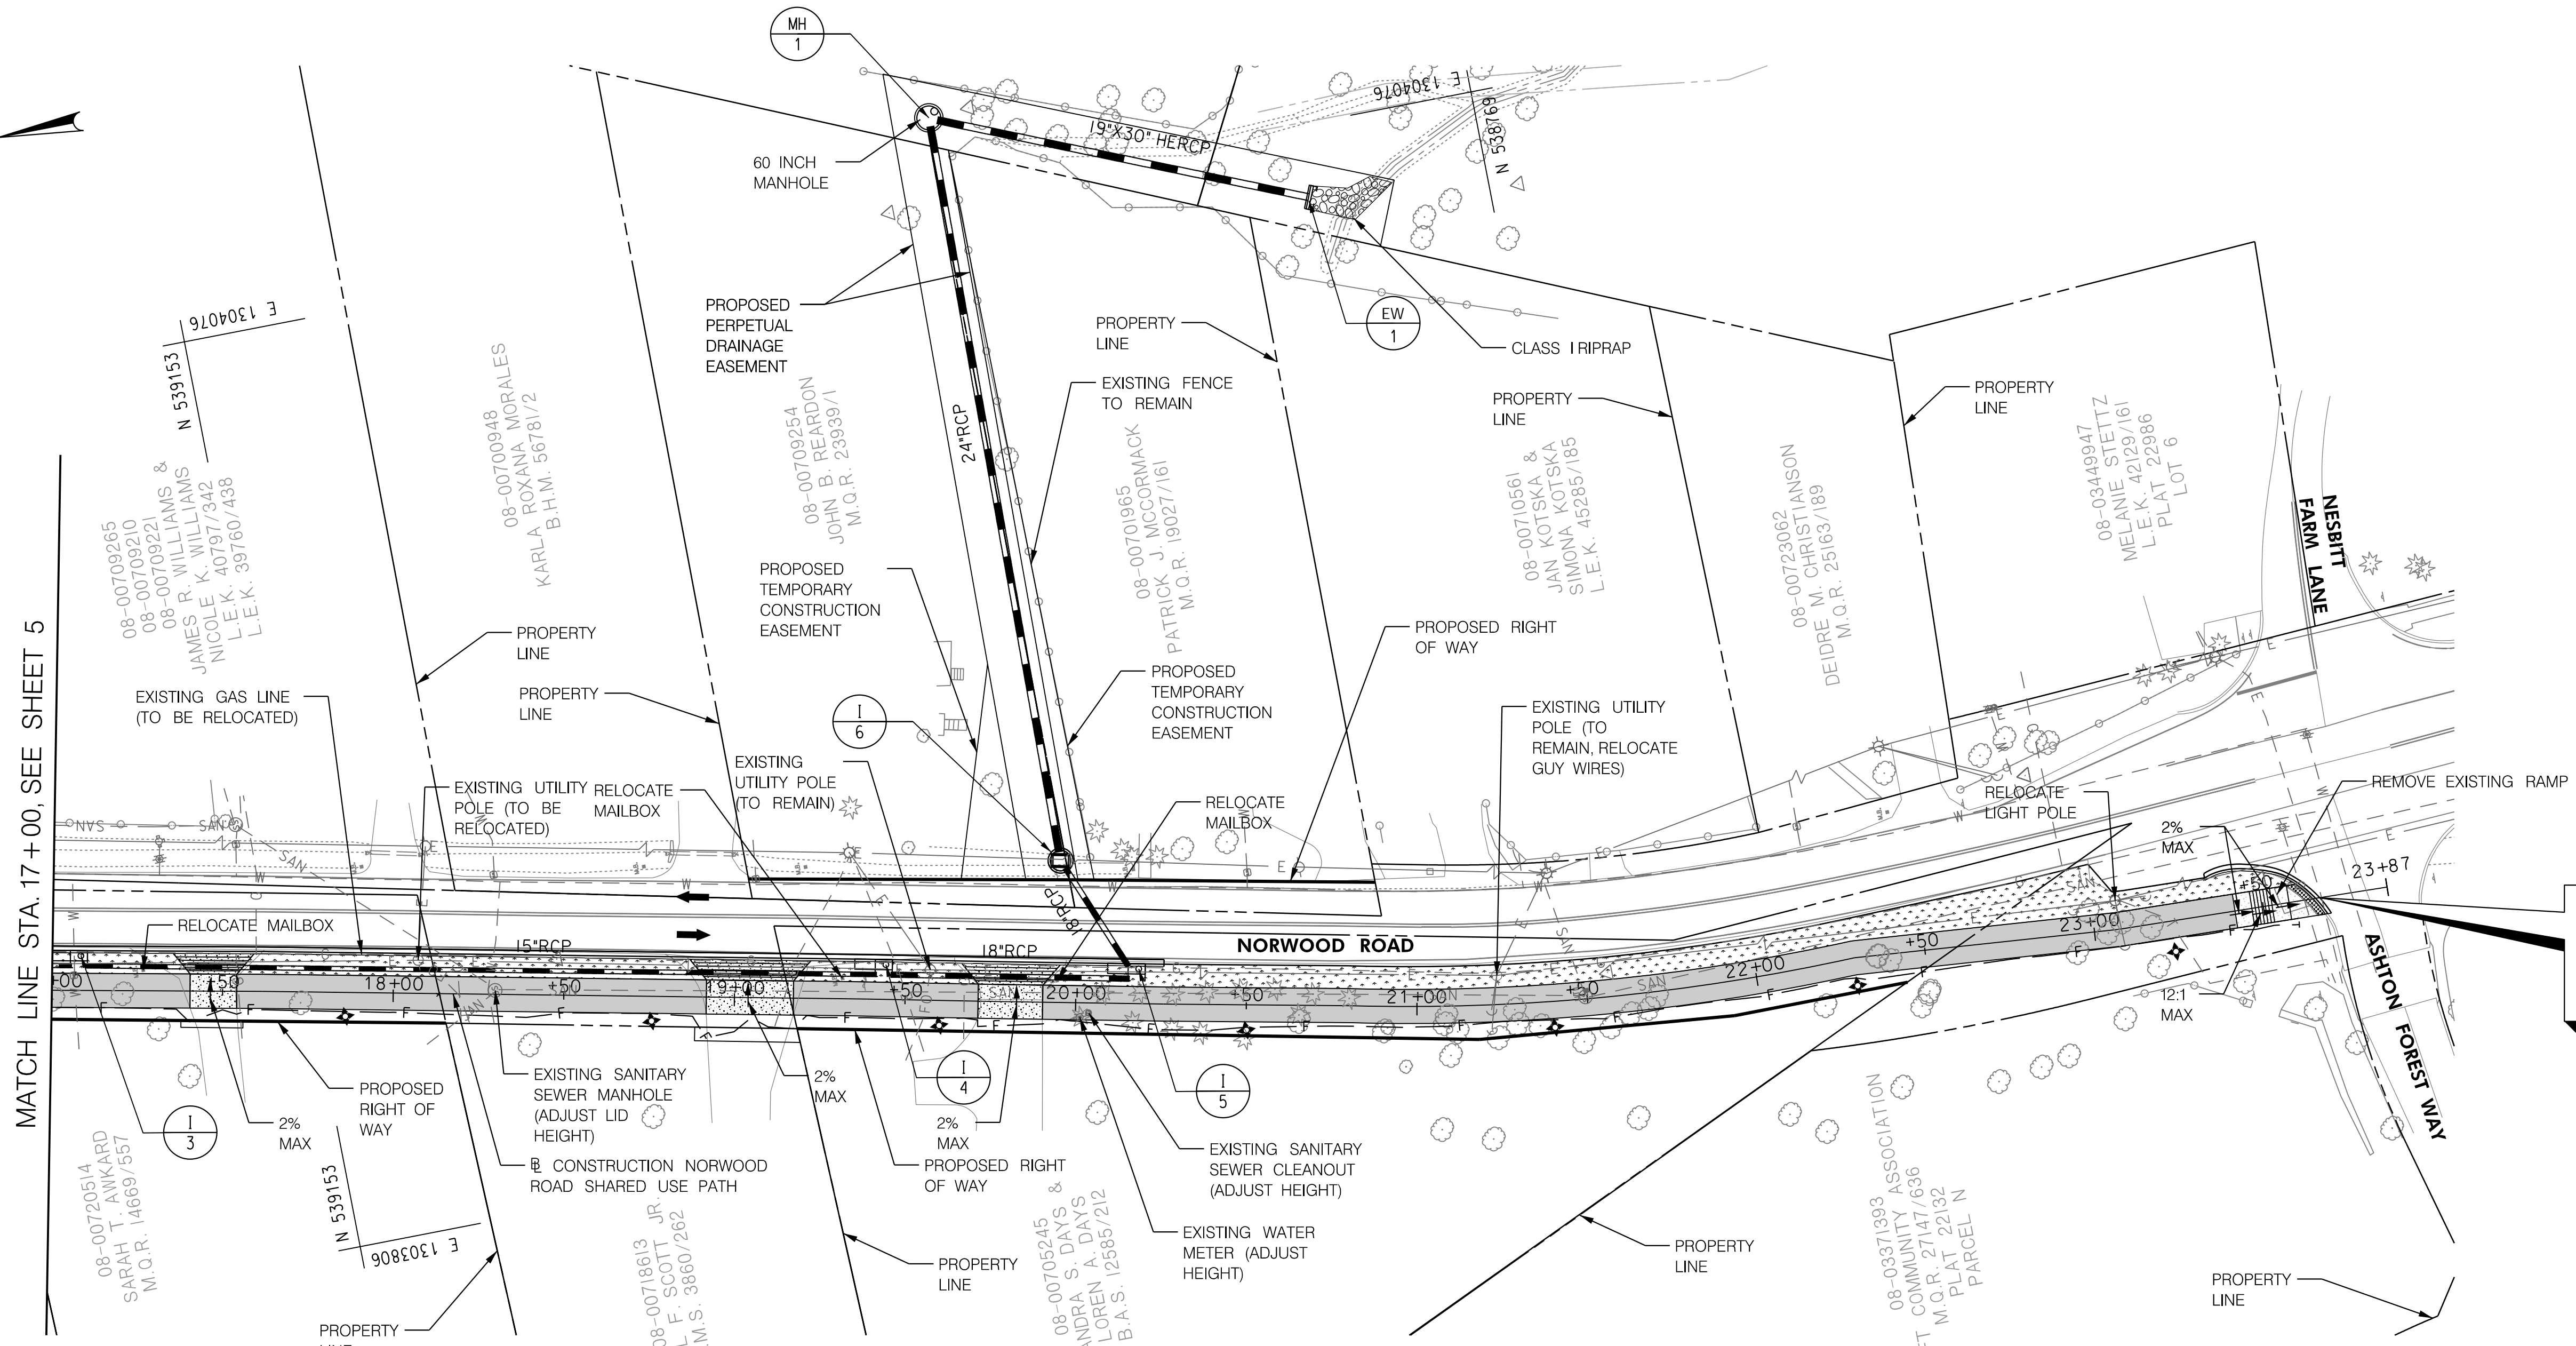

LIMIT OF WORK
CONTRACT NO. 502313
SHARED USE PATH
STA. 23+67

SHARED USE PATH PLAN
 SCALE: 1" = 30'

LEGEND

- CONCRETE DRIVEWAY
- ASPHALT SHARED USE PATH
- GRASS BUFFER
- CLASS I RIPRAP
- DETECTABLE WARNING SURFACE
- CUTFILL LINE
- PROPOSED LIGHT POLE
- EX. RIGHT OF WAY OR PROPERTY LINE
- PROPOSED RIGHT OF WAY
- EASEMENT
- 24 INCH WHITE THERMOPLASTIC PAVEMENT MARKINGS (SOLID)

TYPE A COMBINATION CURB AND GUTTER ANY HEIGHT OR DEPTH	
326	LF NORWOOD ROAD - STA. 17+00 TO STA. 20+26, LT
43	LF NORWOOD ROAD - STA. 23+34 TO STA. 23+69, LT

4 INCH CONCRETE SIDEWALK (STD MC-112.01)	
163	SF NORWOOD ROAD - STA. 23+42 TO STA. 23+65, LT

MR2025012
 WSSC MAP # 224NW01
 TAX MAP ID: JT122/JT342



MONTGOMERY COUNTY
 DEPARTMENT OF TRANSPORTATION
 ROCKVILLE, MARYLAND

MONTGOMERY COUNTY
 DEPARTMENT OF TRANSPORTATION
 DIVISION OF TRANSPORTATION ENGINEERING
NORWOOD ROAD SHARED USE PATH

RECOMMENDED FOR APPROVAL

Chief, Transportation Planning and Design Section _____ Date _____
 APPROVED

Chief, Division of Transportation Engineering _____ Date _____



SHARED USE PATH PLAN-2

SCALE 1"=30' DATE NOVEMBER, 2023


NO.	REVISION	DATE	BY

DESIGNED BY RA DRAWN BY NM CHECKED BY MWM

SHEET NO. 6 OF 20

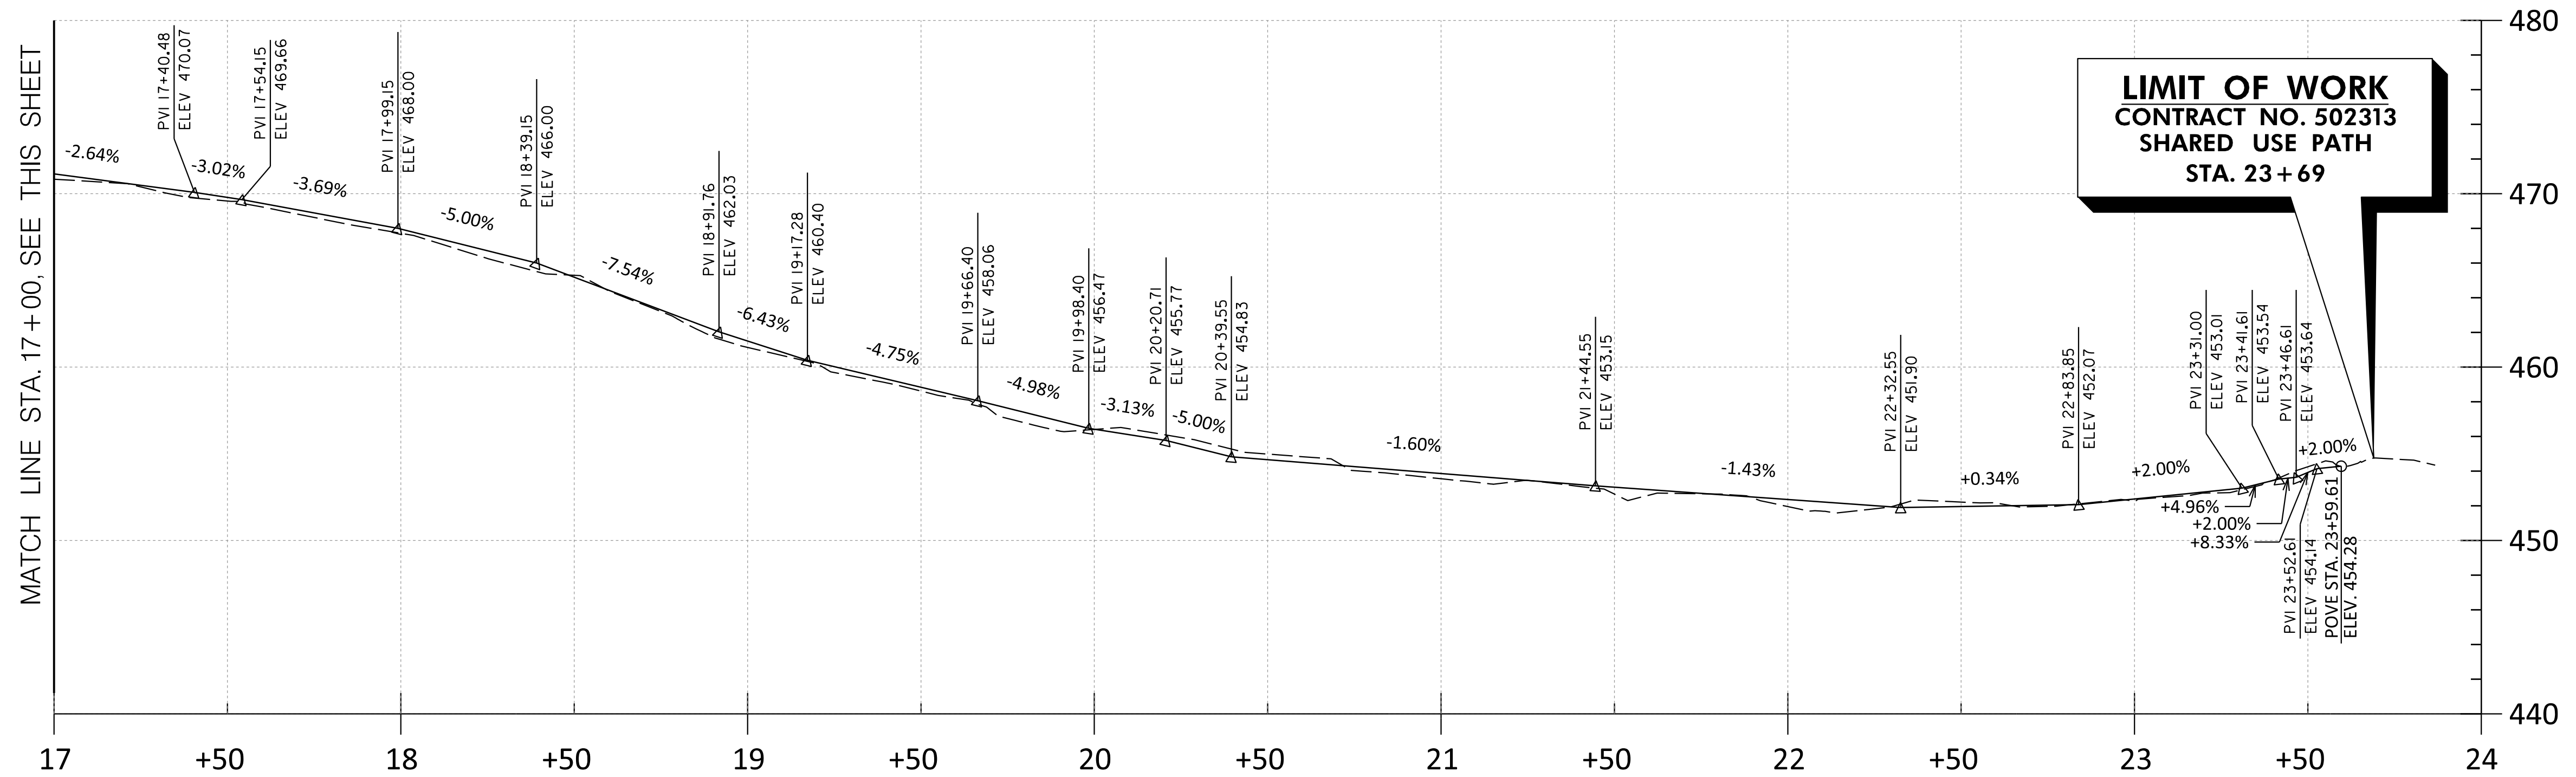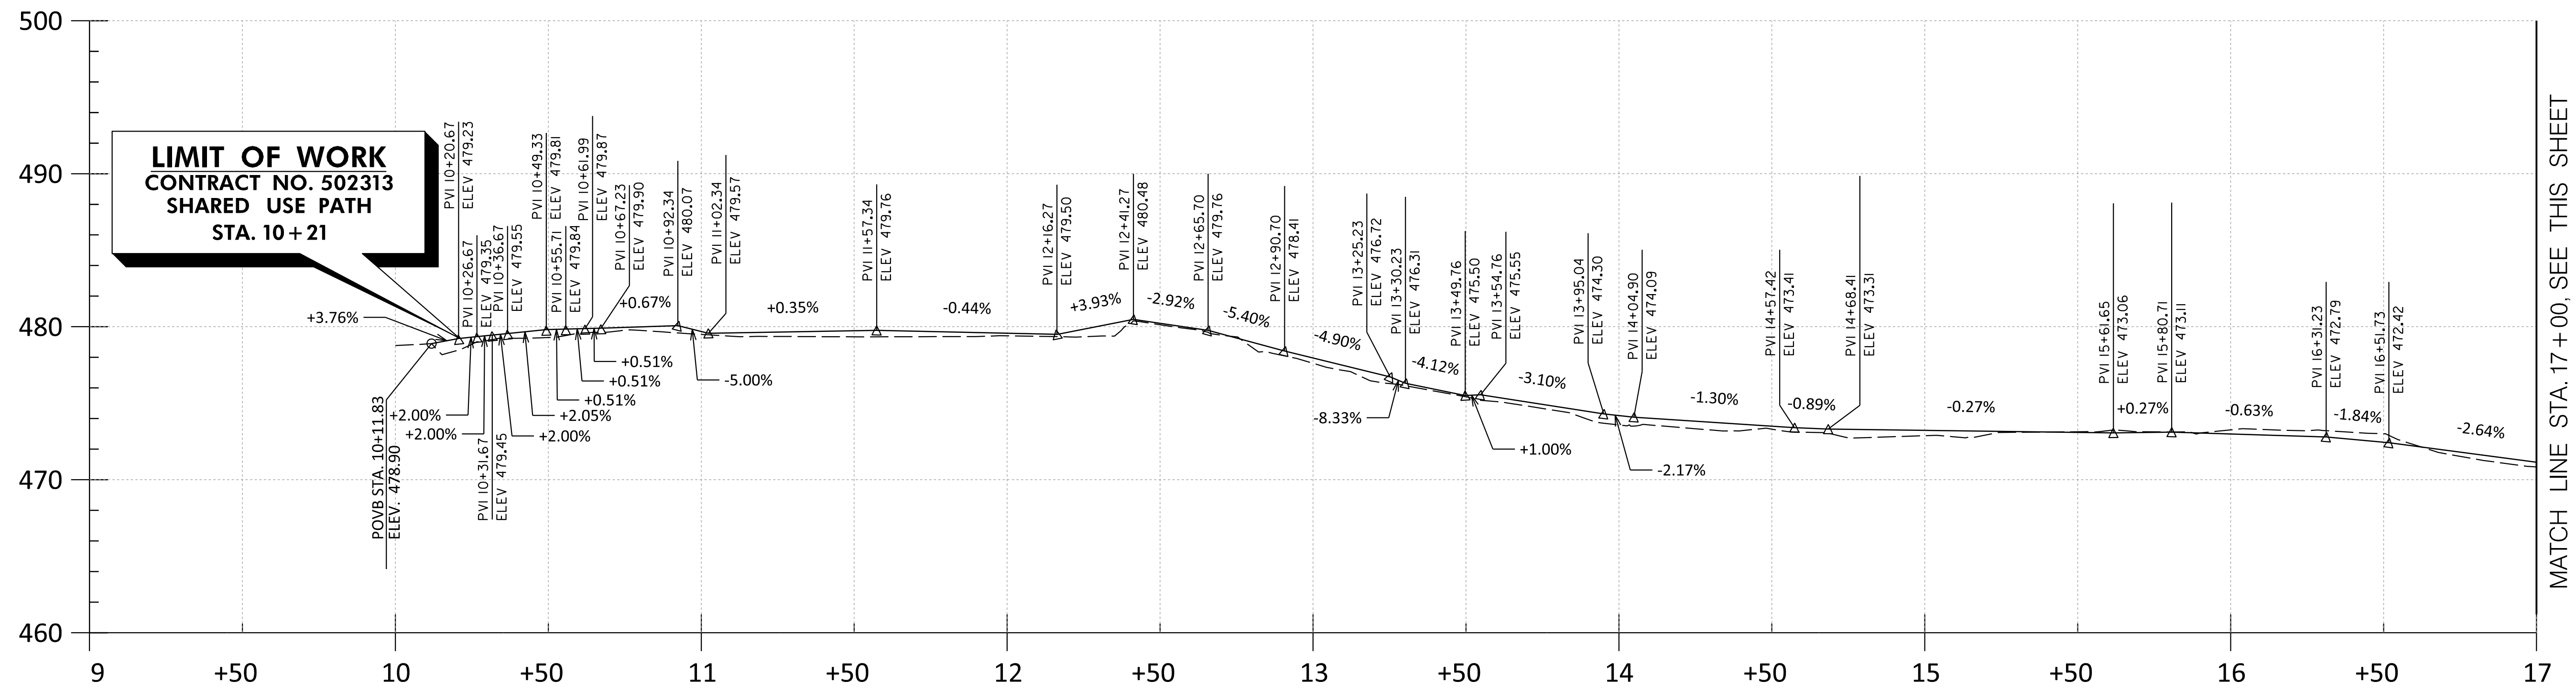

ROADWAY PROFILE
 HORIZONTAL: 1" = 30'
 VERTICAL: 1" = 6'

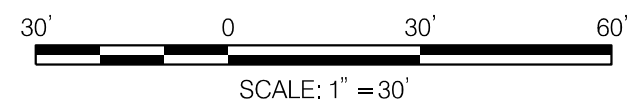

PLT0725 - 11/16/2023
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 WSSC MAP # 224NW01
 TAX MAP ID: JT122/JT342

NO.	REVISION	DATE	BY

MONTGOMERY COUNTY DEPARTMENT OF TRANSPORTATION ROCKVILLE, MARYLAND	
RECOMMENDED FOR APPROVAL	
Chief, Transportation Planning and Design Section	Date
APPROVED	
Chief, Division of Transportation Engineering	Date
DESIGNED BY <u>KBJ</u>	DRAWN BY <u>KBJ</u> CHECKED BY <u>XXX</u>

MONTGOMERY COUNTY DEPARTMENT OF TRANSPORTATION DIVISION OF TRANSPORTATION ENGINEERING	
NORWOOD ROAD SHARED USE PATH	
SHARED USE PATH PROFILES	
HORIZONTAL: 1" = 30' SCALE VERTICAL: 1" = 5' DATE <u>NOVEMBER, 2023</u>	
SHEET NO. <u>7</u> OF <u>20</u>	

I. TRAFFIC CONTROL PLAN GENERAL REQUIREMENTS

- A. A PRIME REQUIREMENT OF THIS CONTRACT IS THAT TWO (2) WAY TRAFFIC BE MAINTAINED AT ALL TIMES ALONG NORWOOD ROAD IN AN ORDERLY, EXPEDITIOUS AND SAFE MANNER UNLESS OTHERWISE NOTED IN THE PLANS. FLAGGER CONTROL SHALL BE UTILIZED AS A METHOD OF MAINTAINING ONE LANE TWO WAY TRAFFIC DURING WORKING HOURS. THE WIDTH OF ANY LANE SHALL REMAIN AT LEAST A MINIMUM OF NINE (9) FEET WIDE DURING NON-WORKING HOURS.
- B. UNLESS OTHERWISE APPROVED BY THE TRAFFIC ENGINEERING AND OPERATIONS SECTION, THE NUMBER OF LANES OF TRAFFIC ON NORWOOD ROAD SHOWN ON THE T.C.P. SHALL BE MAINTAINED DURING NON-WORKING HOURS.
- C. THE SEQUENCE OF OPERATIONS OF THE CONSTRUCTION REFERS SPECIFICALLY TO THE CRITICAL ITEMS OF WORK WHICH MUST BE COMPLETED. THE LISTED ITEMS ARE A SUGGESTED SEQUENCE OF WORK TO BE FOLLOWED TO PROVIDE FOR ORDERLY COMPLETION OF WORK. THE MANY OTHER ITEMS OF WORK WHICH ARE NOT LISTED AND WHICH MAY BE PERFORMED WITHOUT INTERRUPTING TRAFFIC OR AFFECTING THE CONSTRUCTION SCHEDULING AND DO NOT CONTROL THE OVERALL SCHEDULE FOR COMPLETING THE PROJECT ARE NOT LISTED.
- D. ALL SIDEWALK CLOSURES SHALL REQUIRE THE APPROVAL OF DIVISION OF TRAFFIC ENGINEERING AND OPERATIONS. ANY SIDEWALK CLOSURE GREATER THAN TWO (2) WEEKS SHALL REQUIRE THE SUBMITTAL OF A WRITTEN REQUEST TO THE DIVISION OF TRAFFIC ENGINEERING AND OPERATIONS AND MAY REQUIRE ADDITIONAL TRAFFIC CONTROLS. SIDEWALK CLOSURES SHALL BE LIMITED TO OCCUR ONLY DURING THE ACTUAL WORK ACTIVITY. DURING CLOSURE, SIDEWALKS SHALL BE BARRICADED TO PHYSICALLY PREVENT PEDESTRIAN PASSAGE AND APPROPRIATE DETOURS SHALL BE POSTED. DURING ALL OTHER TIMES, PROVISIONS FOR SAFE PEDESTRIAN ACCESS THROUGH THE WORK AREA, VIA A TEMPORARY WALKWAY SHALL BE PROVIDED.
- E. ANY WORK WITHIN THE TRAVELED PORTION OF THE ROADWAY WILL BE RESTRICTED TO THE HOURS OF 9:00 A.M. TO 3:30 P.M., MONDAY THRU FRIDAY. NO WORK ON HOLIDAYS OR WEEKENDS UNLESS WRITTEN EXCEPTION IS GRANTED IN WRITING BY THE COUNTY'S DPS INSPECTOR.
- F. CONSTRUCTION ACTIVITY, LOADING OR UNLOADING OF EQUIPMENT SHALL NOT BLOCK ANY TRAFFIC LANE OTHER THAN THOSE DELINEATED WITHIN THE WORK ZONE.
- G. EXCLUSIVE OF EMERGENCY WORK, THE CONTRACTOR SHALL CONTACT OCCUPANTS OF ALL ADJOINING PROPERTIES AND INFORM THEM OF THE SCOPE AND THE TIMING OF CONSTRUCTION. A MINIMUM OF 24 HOURS NOTIFICATION SHALL BE REQUIRED PRIOR TO THE COMMENCEMENT OF ANY ACTIVITY ON THE SITE.
- H. ACCESS SHALL BE MAINTAINED TO ALL DRIVEWAYS UNLESS PERMISSION FOR CLOSURE IS GRANTED BY THE PROPERTY OWNER/MANAGER. HOWEVER, ACCESSIBILITY FOR EMERGENCY VEHICLES SHALL BE MAINTAINED AT ALL TIMES.
- I. IF ANY TRAFFIC CONTROL SIGNS ARE TO BE PLACED ALONG A MDT SHA ROADWAY, OR WITHIN THE LIMITS OF AN INCORPORATED AREAS, THE PERMITTEE SHALL NOTIFY THE APPROPRIATE AGENCY OF SIGNAGE TO BE INSTALLED.
- J. NO HAZARDOUS MATERIALS SHALL BE STORED WITHIN PUBLIC RIGHT-OF-WAY. NO MATERIALS OR EQUIPMENT SHALL BE STORED ON THE ROADWAY SURFACE OR SIDEWALK DURING NON-WORK PERIODS. ALL STORED MATERIALS AND EQUIPMENT SHALL BE SET BACK AT LEAST SIX (6) FEET BEHIND THE CURB ALONG A CLOSED SECTION ROADWAY AND AT LEAST TWELVE (12) FEET FROM EDGE OF OPEN SECTION ROADWAY.
- K. ANY EXCAVATION(S) IN THE ROADWAY SHALL BE PAVED TO LEVEL GRADE OR PLATED AND THE ROADWAY REOPENED TO ITS FULL CROSS-SECTION PRIOR TO THE END OF EACH WORK DAY. "STEEL PLATES AHEAD" (W21-9) SIGNS SHALL BE PLACED APPROXIMATELY 250 FEET IN ADVANCE OF ANY STEEL PLATE. ANY EXCAVATIONS IN THE SIDEWALK SHALL BE BACKFILLED OR PLATED PRIOR TO THE END OF EACH WORKDAY AND SIDEWALK REOPENED TO ITS FULL CROSS SECTION.

- L. TRAFFIC SHALL NOT BE PERMITTED WITHIN TEN (10) FEET OF ANY EXCAVATION THAT RESULTS IN A VERTICAL DROP-OFF OF MORE THAN FIVE (5) INCHES IN THE LEVEL OF PAVEMENT DURING NON-WORKING HOURS UNLESS PROTECTED BY TEMPORARY CONCRETE BARRIERS OR RAMPED WITH AGGREGATE MATERIAL AT A 3:1 OR FLATTER SLOPE FROM THE EDGE OF PAVEMENT. WHEN RAMPING IS UTILIZED, TTC DRUMS SHALL BE POSITIONED ADJACENT TO THE EDGE OF THE WORK AREA ON THE TRAFFIC SIDE OF THE SLOPE. REFER TO MCDOT STD NO. TCP-108.01 FOR DETAILS.
- M. TRAFFIC SHALL NOT BE PERMITTED WITHIN TWO (2) FEET OF ANY EXCAVATION THAT RESULTS IN A VERTICAL DROP-OFF OF MORE THAN TWO (2) INCHES BUT NO MORE THAN FIVE (5) INCHES IN THE LEVEL OF PAVEMENT DURING NON-WORKING HOURS UNLESS EITHER RAMPED WITH AGGREGATE MATERIAL AT 3:1 OR FLATTER SLOPE, PROVIDED WITH AN ABUTTING WEDGE OF BITUMINOUS MATERIAL AT 3:1 OR FLATTER SLOPE OR PROTECTED BY TRAFFIC DRUMS.
- N. IN AREAS WHERE A DROP-OFF IN THE LEVEL OF PAVEMENT IS TWO (2) INCHES OR LESS, TRAFFIC MAY BE ALLOWED TO FREELY CROSS UNDER THE FOLLOWING CONDITIONS:
 - 1. WHERE LONGITUDINAL PAVING JOINTS OF TWO (2) INCHES OR LESS ARE EXPOSED TO TRAFFIC, WARNING SIGNS SHALL BE POSTED INDICATING "UNEVEN PAVEMENT" (W8-II MOD.). THESE SIGNS SHOULD BE PLACED 250 FEET IN ADVANCE OF THE UNEVEN JOINT AND BE SPACED AT APPROPRIATE INTERVALS THROUGHOUT THE AREA OF THE UNEVEN JOINT.
 - 2. WHERE LATERAL PAVING JOINTS OF TWO (2) INCHES OR LESS ARE EXPOSED TO TRAFFIC, A "BUMP" (W8-1) SIGN SHALL BE POSTED 100 FEET IN ADVANCE OF THE JOINT.
 - 3. WHEN MILLED PAVEMENT IS LEFT EXPOSED TO TRAFFIC, A "ROUGH ROAD (W8-8) OR "GROOVED PAVEMENT" (W8-8A) SIGN SHALL BE PLACED 250 FEET IN ADVANCE OF THE MILLED AREA.
- O. TEMPORARY TRAFFIC CONTROL SIGNS SHALL BE FLUORESCENT ORANGE HIGH PERFORMANCE WIDE ANGLE RETROREFLECTIVE SHEETING. PLACEMENT OF ALL SIGNS SHALL NOT INTERFERE WITH TRAVELED WAYS OR SIGHT DISTANCES OF ANY ROADWAY, STREET OR DRIVEWAY AS PER AASHTO POLICY ON GEOMETRIC DESIGN OF HIGHWAYS AND STREETS, LATEST EDITION.
- P. ALL EXISTING TRAFFIC CONTROL DEVICES THAT MUST BE REMOVED SHALL BE REPLACED IN THEIR PROPER LOCATION PRIOR TO THE COMPLETION OF THE PROJECT. COST FOR THE REPLACEMENT AND/OR REPAIR OF DEVICES DAMAGED AS A RESULT OF THE PROJECT SHALL BE ASSESSED TO THE CONTRACTOR.
- Q. ALL TRAFFIC CONTROL DEVICES SHALL CONFORM TO THE MOST RECENT EDITION OF THE MANUAL ON UNIFORM TRAFFIC CONTROL DEVICES (MUTCD).
- R. THE IMPLEMENTATION DATE AND CONTINUANCE OF THIS PROJECT MAY BE ALTERED AT THE DISCRETION OF THE COUNTY'S INSPECTOR IN THE EVENT OF CONFLICTS WITH PREVIOUSLY APPROVED OR EMERGENCY ACTIVITIES.
- S. AT THE COMPLETION OF THE PERMITTED WORK ACTIVITY, CONDITIONS WITHIN THE PUBLIC SPACE SHALL BE FULLY RESTORED TO THOSE WHICH EXISTED PRIOR TO THE WORK ACTIVITY.
- T. THE CONTRACTOR SHALL BE RESPONSIBLE FOR MAINTAINING ALL TEMPORARY TRAFFIC CONTROL DEVICES AT THE SITE.
- U. ANY CHANGES TO TEMPORARY TRAFFIC CONTROL PLANS SHALL BE MADE IN WRITING AND APPROVED BY THE MONTGOMERY COUNTY TRAFFIC ENGINEERING AND OPERATIONS DIVISION.
- V. ALL TTC DEVICES SHALL BE REMOVED AS SOON AS PRACTICAL WHEN THEY ARE NO LONGER NEEDED. WHEN WORK IS SUSPENDED FOR SHORT PERIODS OF TIME, TTC DEVICES THAT ARE NO LONGER APPROPRIATE SHALL BE REMOVED OR COVERED.

II. SPECIFIC TRAFFIC CONTROL REQUIREMENTS

- A. MAINTENANCE OF TRAFFIC
 - 1. FLAGGERS SHALL BE USED AT THE DIRECTION OF THE COUNTY INSPECTOR.
 - 2. FLAGGERS SHALL USE STOP/SLOW PADDLES TO DIRECT TRAFFIC.
 - 3. FLAGGERS SHALL BE MARYLAND STATE HIGHWAY ADMINISTRATION OR AATS APPROVED FLAGGERS.
 - 4. RADIO COMMUNICATION SHALL BE REQUIRED BETWEEN FLAGGERS AT THE DISCRETION OF THE COUNTY INSPECTOR OR UNDER THE FOLLOWING CONDITIONS:
 - a. IF THE FLAGGERS CANNOT SEE EACH OTHER.
 - b. IF THE LANE CLOSURE EXCEEDS 200 FEET.
 - 5. AT LEAST ONE 10 FOOT TRAVEL LANE SHALL BE AVAILABLE FOR TRAFFIC AT ALL TIMES.
 - 6. PROVISION SHALL BE MADE FOR SAFE MAINTENANCE OF PEDESTRIAN AND BICYCLE TRAFFIC, SUBJECT TO THE APPROVAL OF THE COUNTY'S DPS INSPECTOR.

B. INSTALLATION OF TRAFFIC CONTROL DEVICES

- 1. SIGNAGE, TRAFFIC DRUMS, AND ARROW PANELS SHALL BE PLACED IN ACCORDANCE WITH THE APPROPRIATE TYPICAL SPACING CHART AND AS LISTED ON THE TRAFFIC CONTROL PLANS.
- 2. ALL SIGNS AND TRAFFIC DRUMS SHALL BE FULLY REFLECTORIZED WITH HIGH INTENSITY, REFLECTIVE SHEETING AS PER THE MUTCD.
- 3. ALL WARNING SIGNS, UNLESS OTHERWISE SPECIFIED, SHALL BE A MINIMUM OF 48 " X 48", BLACK SYMBOL OR LEGEND ON ORANGE BACKGROUND AND DIAMOND SHAPED. PLACEMENT OF ALL SIGNS SHALL NOT INTERFERE WITH TRAVELED WAYS OR SIGHT DISTANCES OF ANY ROADWAY, STREET OR DRIVEWAY AS PER AASHTO POLICY ON GEOMETRIC DESIGN OF HIGHWAYS AND STREETS, LATEST EDITION. ALL WARNING SIGNS NOT APPLICABLE TO THE ACTUAL SITUATION SHALL BE REMOVED OR COVERED DURING NON-APPLICABLE PERIODS.
- 4. VARIABLE MESSAGE SIGNS (IF REQUIRED) SHALL BE PROVIDED TWO WEEKS BEFORE AFTER AND DURING CONSTRUCTION. LOCATION AND MESSAGE TO BE DETERMINED BY ENGINEER.
- 5. DURING NIGHTTIME OPERATIONS, REFLECTORIZED TRAFFIC DRUMS SHOULD BE USED. HOWEVER, FOR EMERGENCY WORK ACTIVITIES, WHERE TRAFFIC DRUMS ARE NOT READILY AVAILABLE, REFLECTORIZED TRAFFIC CONES THAT ARE A MINIMUM OF TWENTY EIGHT (28) INCHES IN HEIGHT AND HAVING SIX (6) INCH AND FOUR (4) INCH REFLECTIVE COLLARS WITHIN THE TOP SIXTEEN (16) INCHES OF THE CONE MAY BE USED. ALL WORK AREAS LEFT UNATTENDED AT NIGHT SHALL BE DELINEATED WITH REFLECTORIZED TRAFFIC DRUMS.
- 6. CONTRACTOR SHALL EXCAVATE ONLY AS MUCH AS IS TO BE WORKED IN A DAY. IN CASE ANY EXCAVATED AREA IS LEFT OVERNIGHT, TEMPORARY CONCRETE BARRIERS SHALL BE PLACED SURROUNDING THAT AREA.
- 7. ALL PORTABLE SIGNS SHALL BE MOUNTED A MINIMUM OF ONE (1) FOOT ABOVE THE LEVEL OF THE ROADWAY, WITH HIGHER MOUNTING HEIGHTS DESIRABLE.
- 8. WHEN PAVEMENT MARKINGS HAVE BEEN OBLITERATED BY THE WORK ACTIVITY, THE PERMITTEE SHALL INSTALL ANY CRITICAL INTERIM PAVEMENT MARKINGS PRIOR TO THE END OF THE WORK DAY AS SPECIFIED BY THE COUNTY'S DPS INSPECTOR AND/OR THE DIVISION OF TRAFFIC ENGINEERING AND OPERATIONS.
 - a. ON ROAD SECTIONS THAT ARE NOT SCHEDULED TO BE OVERLAID, ALL TEMPORARY PAVEMENT MARKINGS SHALL BE (REMOVABLE) DETOUR GRADE MARKING TAPE. ANY CONFLICTING MARKINGS WHICH NEED TO BE TEMPORARILY REMOVED ARE TO BE MASKED USING "3M REMOVABLE BLACK LANE MASK" OR AN APPROVED EQUAL.

III. CONTACT INFORMATION

- A. CONTACT THE MCDOT TRANSPORTATION MANAGEMENT CENTER 240-777-2100 BETWEEN 5:00 AM AND 11:00 PM TO INFORM THEM OF TEMPORARY LANE CLOSURES IN THE VICINITY OF ANY TRAFFIC SIGNALS.
- B. CONTACT TRAFFIC ENGINEERING DESIGN AND OPERATIONS SECTION AT 240-777-2190 (A MINIMUM OF ONE WEEK PRIOR) TO COORDINATE ANY MINOR TRAFFIC SIGNAL RELOCATIONS TO FACILITATE THIS WORK ACTIVITY. MAJOR SIGNAL RELOCATIONS SHALL BE COORDINATED A MINIMUM OF THIRTY (30) DAYS IN ADVANCE OF THE PROJECT. THE PERMITTEE SHALL CONTACT THE MONTGOMERY COUNTY TECHNICAL CENTER AT 301-279-1291 A MINIMUM OF 48 HOURS PRIOR TO BEGINNING WORK TO HAVE TRAFFIC SIGNAL EQUIPMENT MARKED.
- C. CONTACT TRAFFIC ENGINEERING STUDIED SECTION AT 240-777-2190 AT LEAST TEN (10) WORKING DAYS IN ADVANCE OF THE FINAL PAVING OPERATION TO SCHEDULE THE INSTALLATION OF PERMANENT PAVEMENT MARKINGS AND SIGNS.
- D. CONTACT MS. STELLA O. IGBINEDION AT 240-777-2190 TO REQUEST ANY FIELD ASSISTANCE BY THE MCDOT DIVISION OF TRAFFIC ENGINEERING AND OPERATION.

SEQUENCE OF CONSTRUCTION


- 1. GENERAL
 - DURING CONSTRUCTION, TRAFFIC SHALL BE MAINTAINED ON THE EXISTING ROADWAYS. THE CONSTRUCTION EFFORT SHALL BE DIRECTED TO COMPLETING THE SHARED USE PATH OF THE NORWOOD ROAD AS DESCRIBED BELOW. SIDEWALK RAMPS, INSTALLATION OF TRAFFIC SIGNAL AT THE INTERSECTION OF NORWOOD ROAD AND MD 108, INSTALLATION OF LIGHT POLES ALONG SHARED USE PATH, RELOCATION OF GAS LINE, AND INSTALLATION OF STORM DRAIN SYSTEM.
 - PRIOR TO THE COMMENCEMENT OF WORK, THE CONTRACTOR SHALL NOTIFY THE PROPERTY OWNERS AS TO THE DURATION OF THE PROPOSED WORK AS SPECIFIED IN THE SPECIAL PROVISIONS. THE CONTRACTOR CAN ALSO INFORM THE OWNER OF ANY EQUIPMENT THAT NEEDS TO BE RELOCATED.
- 2. SEQUENCE OF CONSTRUCTION
 - A. INSTALL ALL TEMPORARY SIGNING AND MARKING REQUIRED FOR THE INITIAL CONSTRUCTION WORK TO BE PERFORMED.
 - B. PRIOR TO COMMENCING ANY WORK AT ANY GIVEN LOCATION, THE INSTALLATION OF ALL NECESSARY SEDIMENT CONTROL FACILITIES REQUIRED DURING CONSTRUCTION MUST BE COMPLETED AND HAVE THE APPROVAL OF THE EROSION AND SEDIMENT CONTROL INSPECTOR.
 - C. MAKING USE OF FLAGGING OPERATION AS PER MCDOT TCP-102.02, AND TCP-105.06, MAINTAIN ONE LANE TWO WAY TRAFFIC ON NORWOOD ROAD DURING WORKING HOURS.
 - D. CONSTRUCT NORWOOD SHARED USE PATH, RESIDENTIAL DRIVEWAYS, CURB AND GUTTER, SIDEWALK RAMPS AND STORM DRAIN SYSTEM AS SHOWN ON THE TCP PLANS. ALL CONSTRUCTION ACTIVITY THAT IMPACTS RESIDENTIAL PROPERTY MUST BE COORDINATED WITH THE PROPERTY OWNERS PRIOR TO THE START OF WORK, AND DONE IN ACCORDANCE WITH DIRECTIVES INCLUDED ELSEWHERE IN THE CONTRACT DOCUMENTS.
 - E. COVER TEMPORARY SIGNS BEING USED DURING WORKING HOURS.
 - F. INSTALL TEMPORARY CHANNELIZATION DEVICES AND TEMPORARY TRAFFIC SIGNS AS SHOWN ON THE TCP PLANS AS PER MCDOT TCP- 102.01 OR AS DIRECTED BY THE ENGINEER FOR MAINTENANCE OF TRAFFIC DURING NON-WORKING HOURS.
 - G. RESTORE FLAGGING OPERATION AND APPLICABLE TEMPORARY SIGNS DURING WORKING HOURS.
 - H. AT THE COMPLETION OF WORK, REMOVE ALL TEMPORARY TRAFFIC CONTROL DEVICES.

PLOTTER: 11x17x24
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MR2025012
 WSSC MAP # 224NW01
 TAX MAP ID: JT122/JT342

MONTGOMERY COUNTY DEPARTMENT OF TRANSPORTATION ROCKVILLE, MARYLAND		MONTGOMERY COUNTY DEPARTMENT OF TRANSPORTATION DIVISION OF TRANSPORTATION ENGINEERING NORWOOD ROAD SHARED USE PATH TRAFFIC CONTROL PLAN	
RECOMMENDED FOR APPROVAL Chief, Transportation Planning and Design Section _____ Date _____ APPROVED		Chief, Division of Transportation Engineering _____ Date _____	
DESIGNED BY	RA	DRAWN BY	NM
CHECKED BY	MWM		
NO.	REVISION	DATE	BY
SCALE		DATE	
NTS		NOVEMBER, 2023	
			SHEET NO. <u>8</u> OF <u>20</u>



MATCH LINE STA. 17+00, SEE SHEET 10

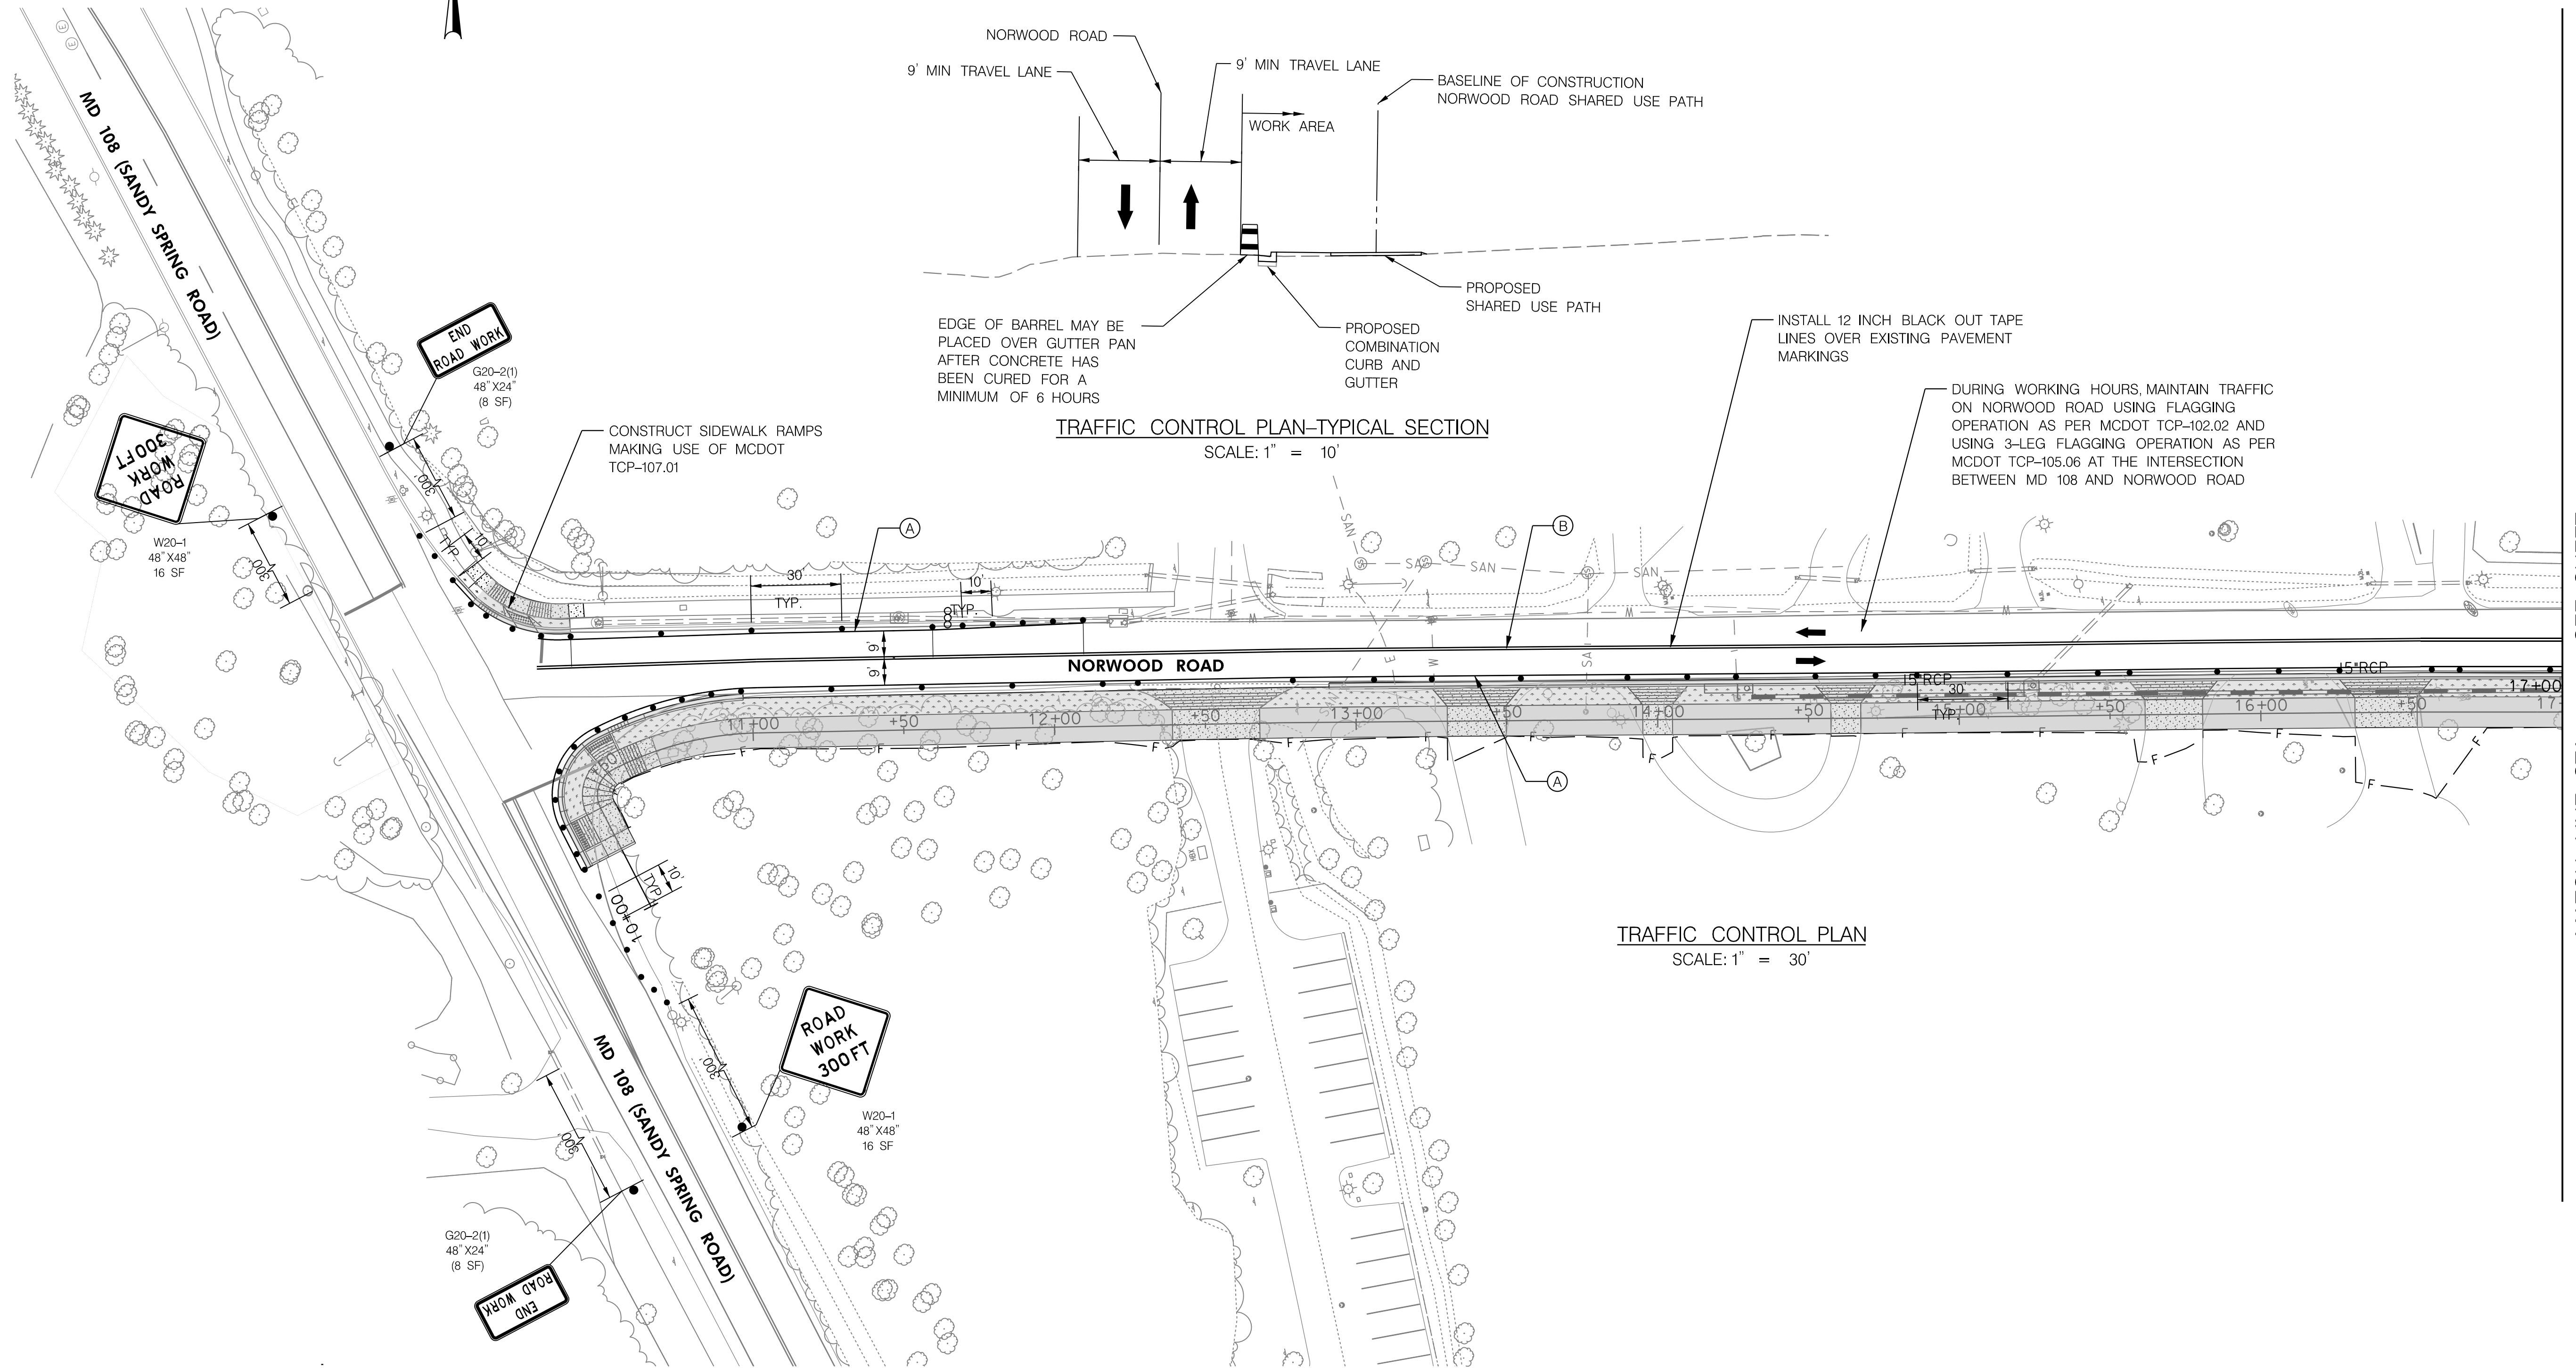
- CURRENT WORKZONE
- TRAFFIC FLOW ARROW
- DRUMS
- TEMPORARY TRAFFIC SIGN SUPPORT
- ARROW PANEL
- TEMPORARY TRAFFIC SIGN
- (A) 5 INCH WHITE REMOVABLE PAVEMENT LINE MARKINGS
- (B) 5 INCH DOUBLE YELLOW REMOVABLE PAVEMENT LINE MARKINGS



PLOTTER: 11x17x24
FILE: \\server01\mercado_data\1\Projects\10081908\04 Sandy Spring Bldgway\CADD\JMT-Prjt_Norwood.dgn

MR2025012
WSSC MAP # 224NW01
TAX MAP ID: JT122/JT342

				MONTGOMERY COUNTY DEPARTMENT OF TRANSPORTATION ROCKVILLE, MARYLAND	MONTGOMERY COUNTY DEPARTMENT OF TRANSPORTATION DIVISION OF TRANSPORTATION ENGINEERING NORWOOD ROAD SHARED USE PATH TRAFFIC CONTROL PLAN—NON WORKING HOURS SCALE 1"=30' DATE NOVEMBER, 2023
				RECOMMENDED FOR APPROVAL	
				Chief, Transportation Planning and Design Section	Date
				APPROVED	
				Chief, Division of Transportation Engineering	Date
NO.	REVISION	DATE	BY	DESIGNED BY RA	DRAWN BY NM CHECKED BY MML
				SHEET NO. 9 OF 20	

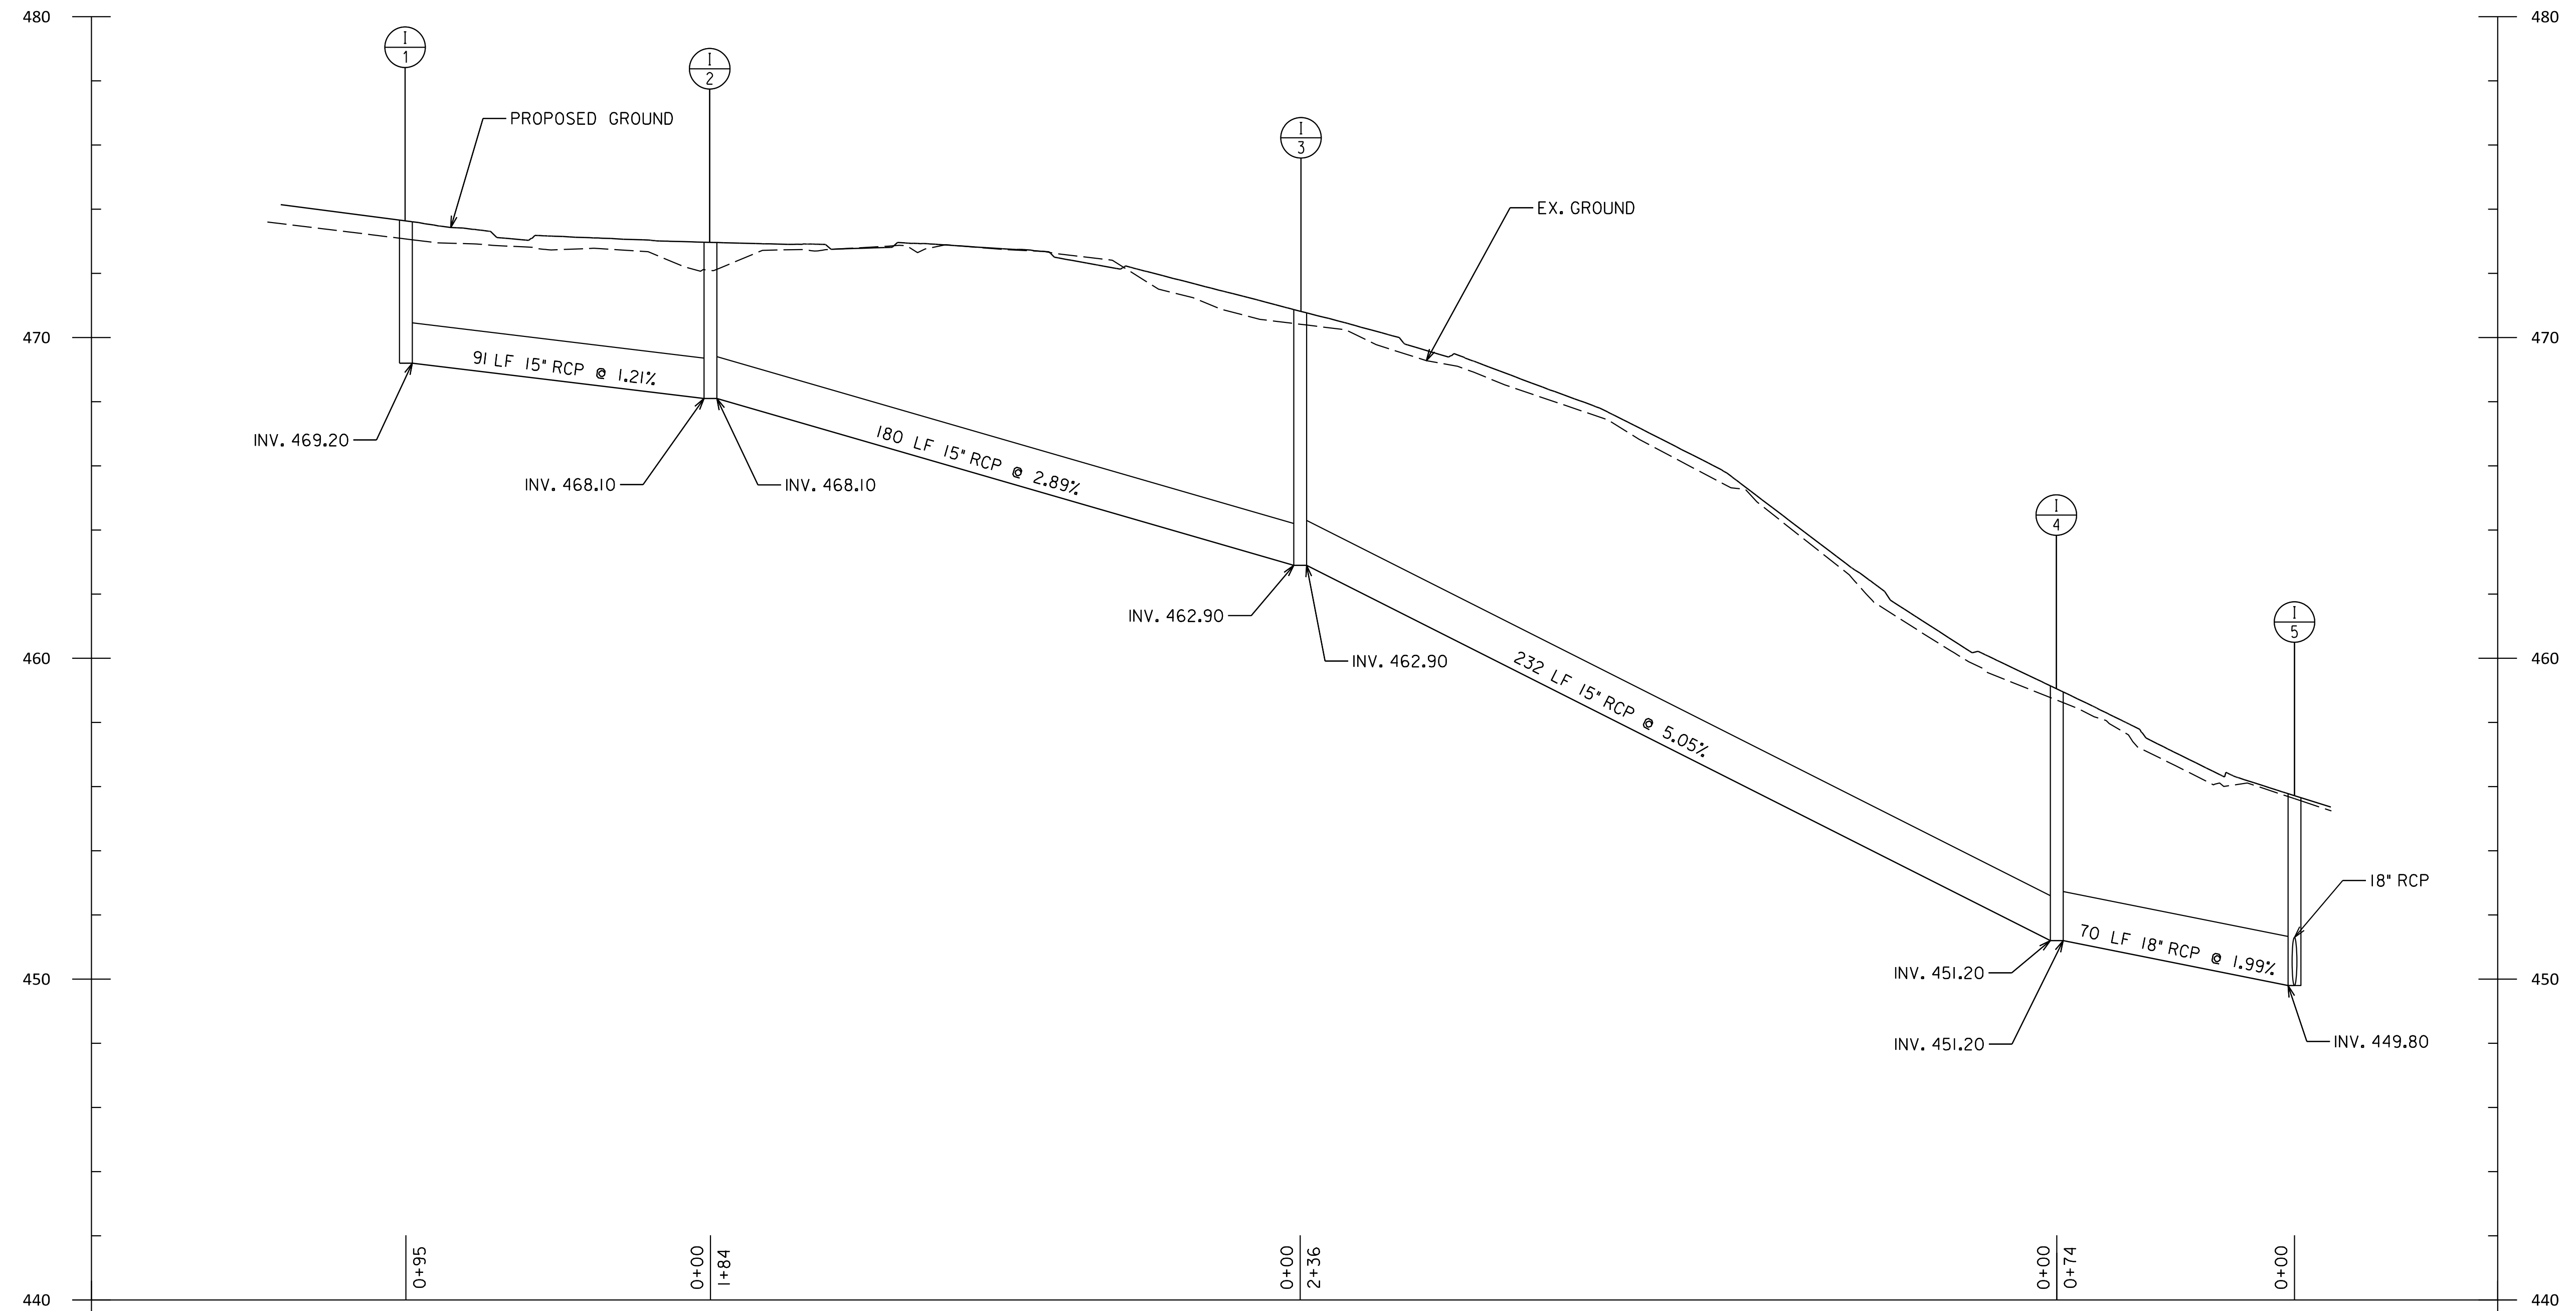

STORM DRAIN STRUCTURE SCHEDULE							
STRUCTURE NO.	STRUCTURE TYPE	STANDARD NO.	NORTHING	EASTING	TOP ELEV.	INV. IN'	INV. OUT
I-1	COG-I5	MC 502.01	539491.68	1303957.73	443.36		469.20
I-2	COG-I0	MC 502.01	539398.37	1303939.01	443.30	468.10	468.10
I-3	COG-I0	MC 502.01	539218.11	1303902.50	443.08	462.90	462.90
I-4	COG-I0	MC 502.01	538987.22	1303854.91	441.91	451.20	451.20
I-5	COG-I0	MC 502.01	538914.73	1303839.65	441.57	449.80	449.80

I-1 TO I-5
 SCALE: HORIZ. 1" = 30'
 VERT. 1" = 3'

STORM DRAIN PIPE SCHEDULE						
FROM	TO	SIZE	MATERIAL	CLASS	LENGTH (FT.)	
I-1	I-2	15"	RCP	IV	91	
I-2	I-3	15"	RCP	IV	180	
I-3	I-4	15"	RCP	IV	232	
I-4	I-5	18"	RCP	IV	70	

MR2025012
 WSSC MAP # 224NW01
 TAX MAP ID: JT122/JT342

SC0002



MONTGOMERY COUNTY
 DEPARTMENT OF TRANSPORTATION
 ROCKVILLE, MARYLAND

RECOMMENDED FOR APPROVAL

Chief, Transportation Planning and Design Section _____ Date _____
 APPROVED

Chief, Division of Transportation Engineering _____ Date _____

MONTGOMERY COUNTY
 DEPARTMENT OF TRANSPORTATION
 DIVISION OF TRANSPORTATION ENGINEERING

NORWOOD ROAD SHARED USE PATH


STORM DRAIN PROFILES-1

SCALE AS SHOWN DATE NOVEMBER, 2023

NO.	REVISION	DATE	BY


DESIGNED BY RA DRAWN BY NM CHECKED BY MML

SHEET NO. 11 OF 20

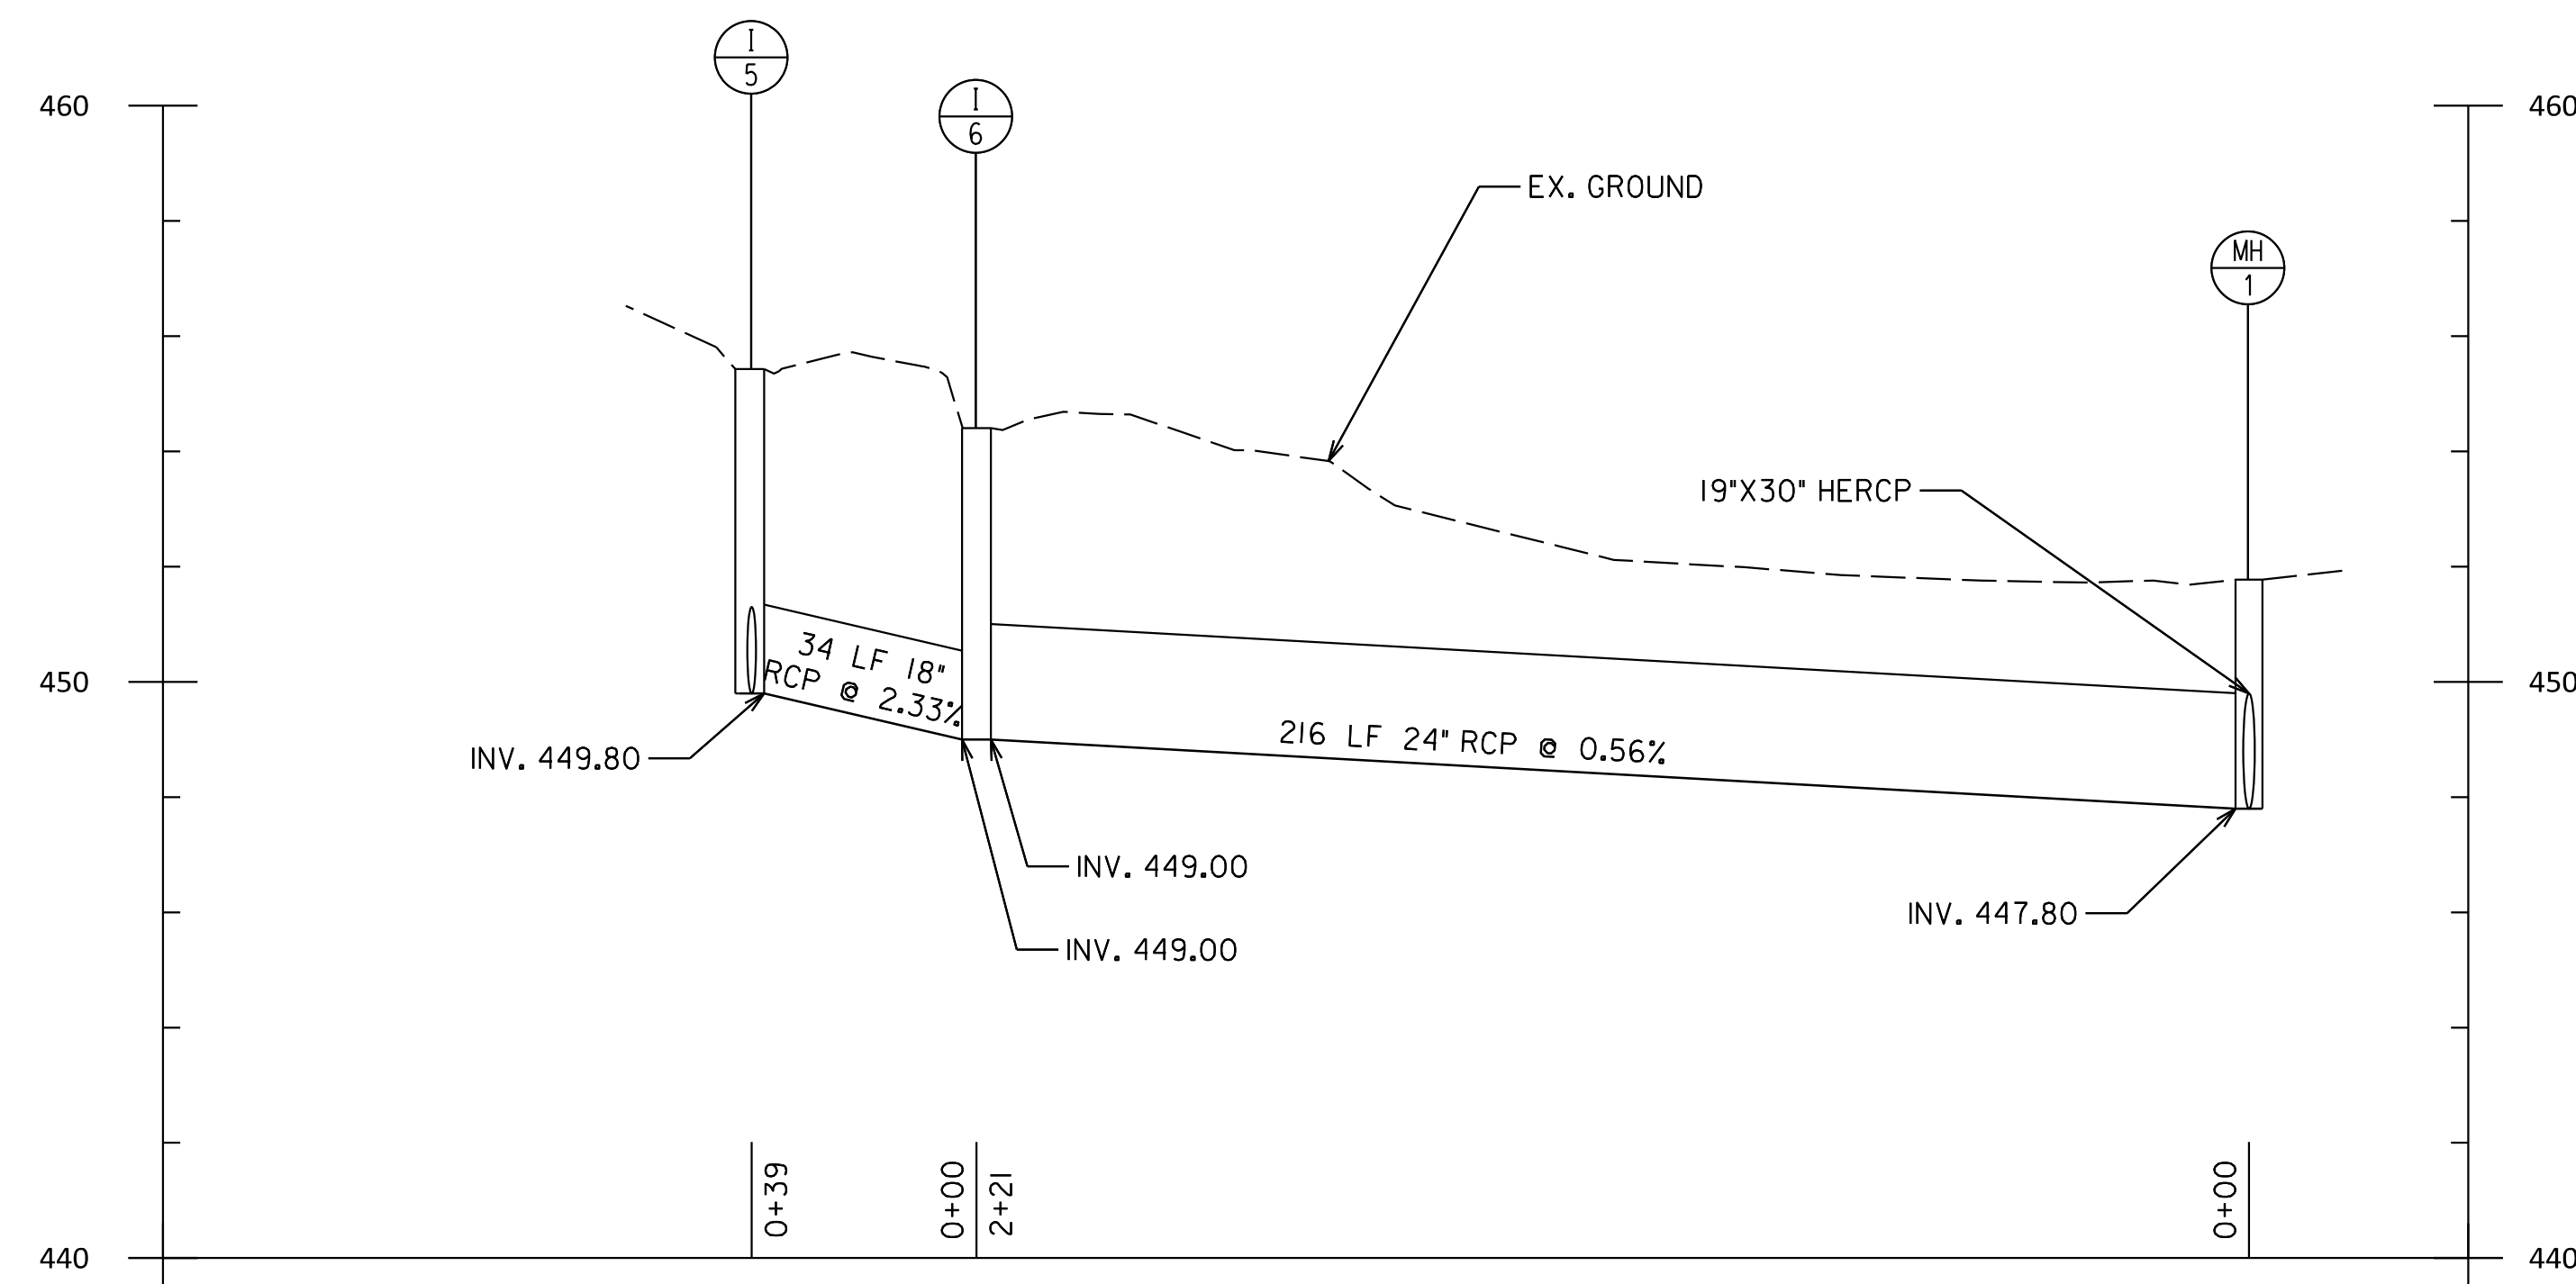

I-6 TO MH-1

SCALE: HORIZ. 1" = 30'
VERT. 1" = 3'

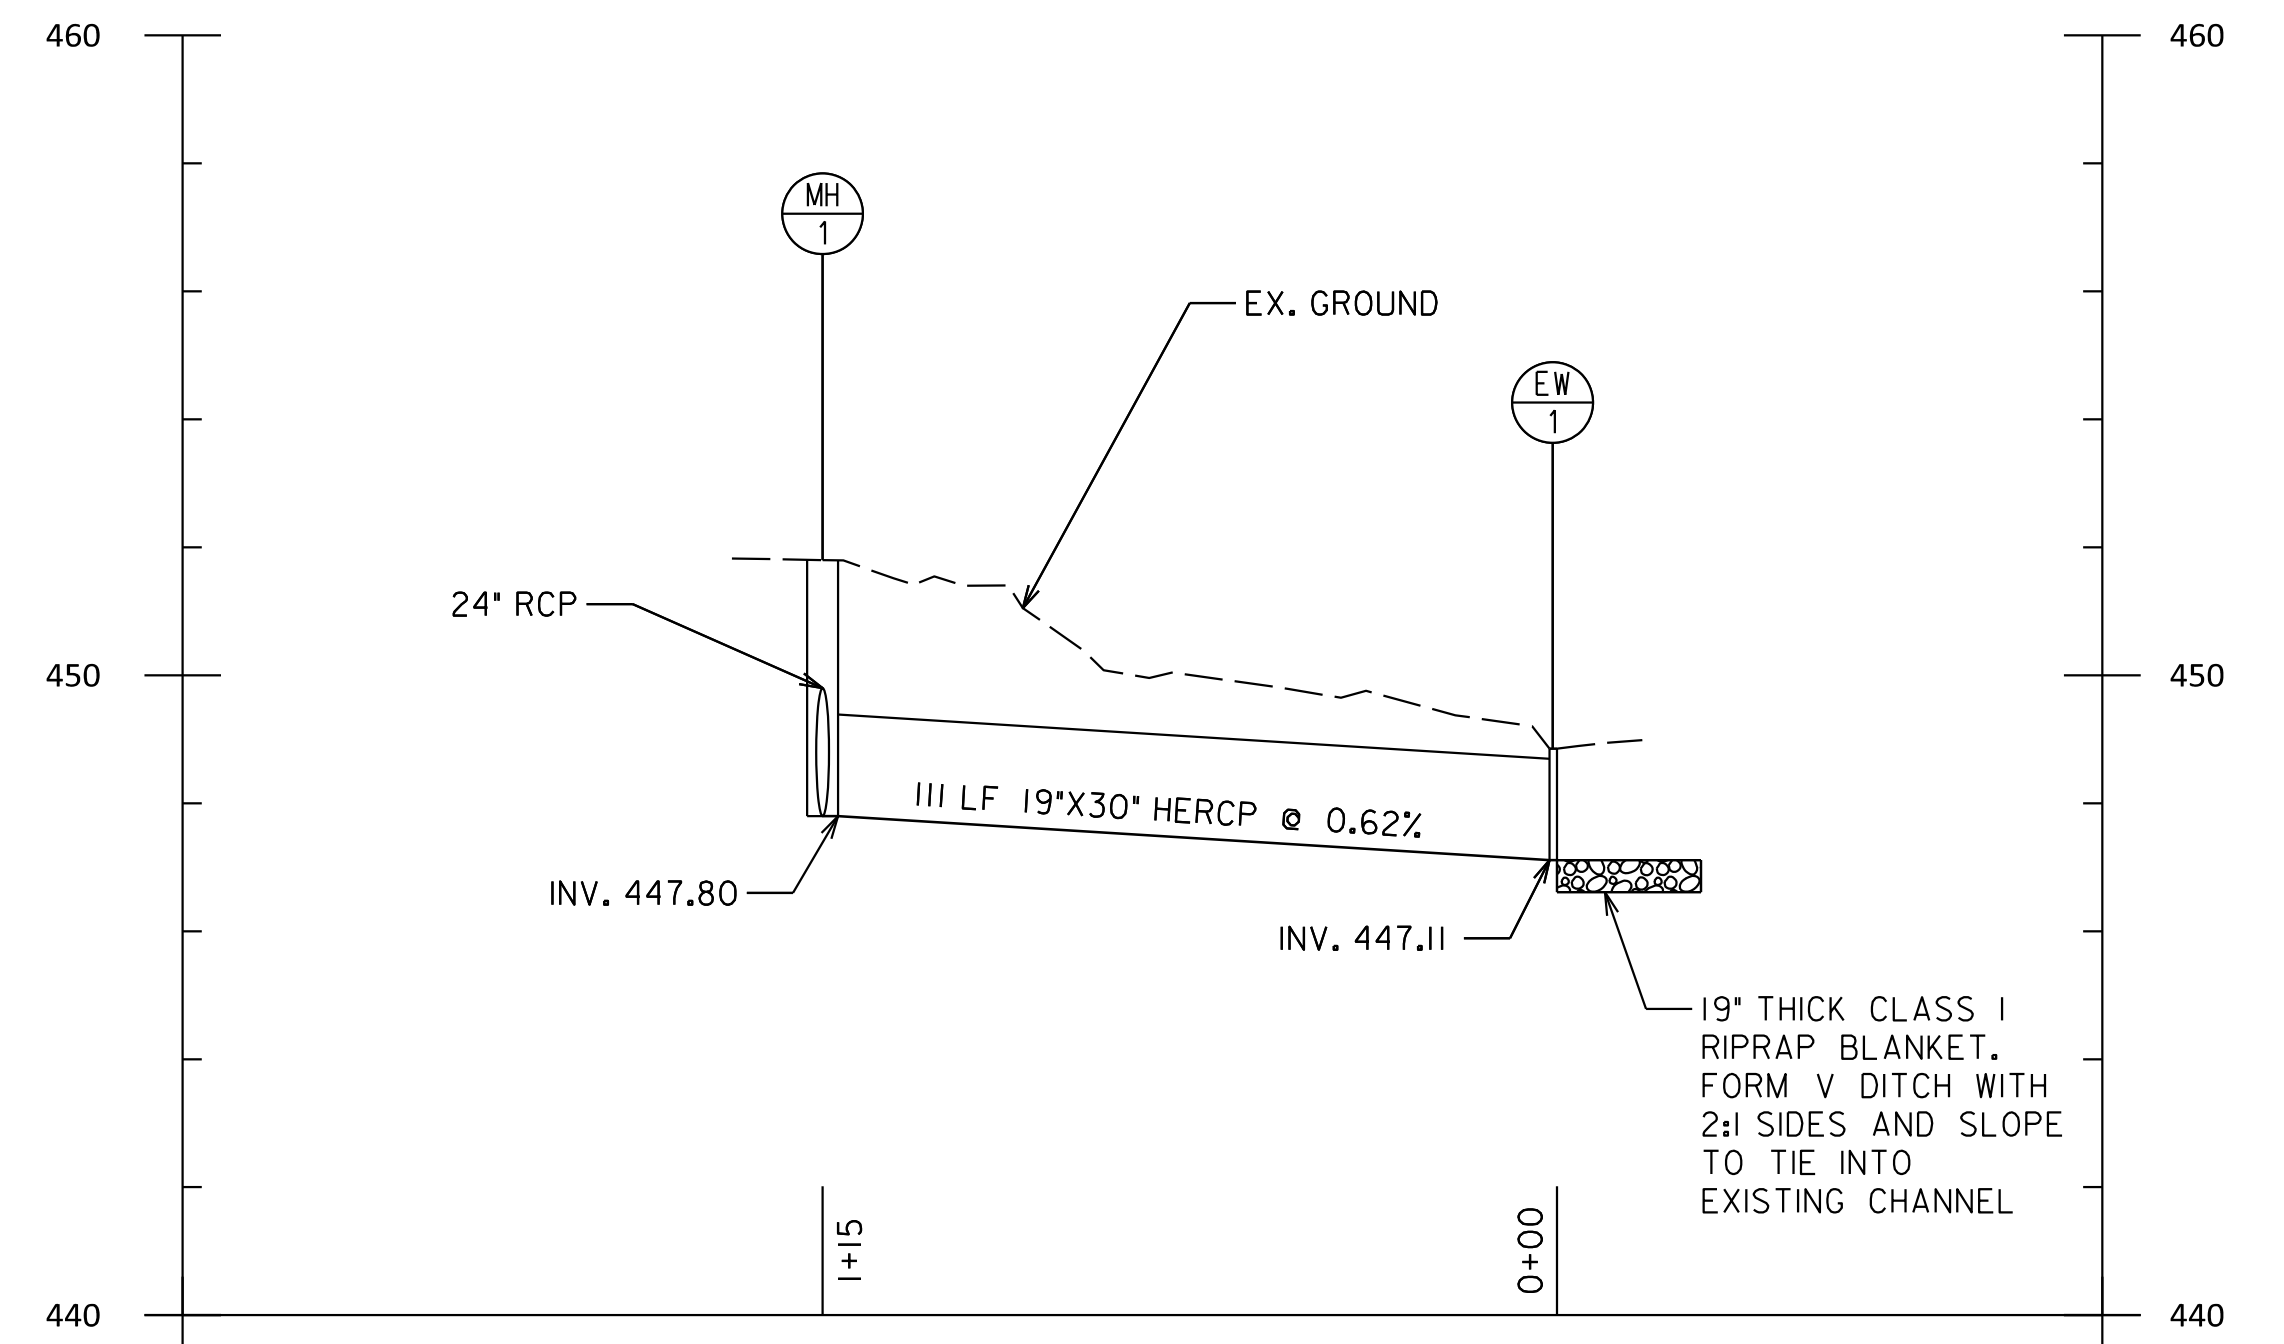

MH-1 TO EW-1

SCALE: HORIZ. 1" = 30'
VERT. 1" = 3'

STORM DRAIN STRUCTURE SCHEDULE							
STRUCTURE NO.	STRUCTURE TYPE	STANDARD NO.	NORTHING	EASTING	TOP ELEV.	INV. IN	INV. OUT
I-5	COG-10	MC 502.01	538914.73	1303839.65	441.57	449.80	449.80
I-6	TYPE J DITCH INLET	MC 506.01	538929.96	1303877.88	441.44	449.00	449.00
MH-1	MANHOLE 60 INCH DIA	MD 510.01	538926.39	1304098.64	441.18	447.80	447.80
EW-1	END WALL	MD 355.01	538821.59	1304054.80	440.89	447.11	

STORM DRAIN PIPE SCHEDULE						
FROM	TO	SIZE	MATERIAL	CLASS	LENGTH (FT.)	
I-5	I-6	18"	RCP	IV	34	
I-6	MH-1	24"	RCP	IV	216	
MH-1	EW-1	19"X30"	HERCP	IV	111	



PLOT DATE: 11/02/2023
 FILE: \\lvsrv01\lvsrv\data\1\Projects\1908\1908.dwg - Storm Drain Profiles - Norwood Road Shared Use Path - Norwood.dwg

MR2025012
 WSSC MAP # 224NW01
 TAX MAP ID: JT122/JT342

SC0003

MONTGOMERY COUNTY
 DEPARTMENT OF TRANSPORTATION
 ROCKVILLE, MARYLAND

RECOMMENDED FOR APPROVAL

Chief, Transportation Planning and Design Section
 APPROVED

Chief, Division of Transportation Engineering

DESIGNED BY RA

DRAWN BY NM

CHECKED BY MML

MONTGOMERY COUNTY
 DEPARTMENT OF TRANSPORTATION
 DIVISION OF TRANSPORTATION ENGINEERING

NORWOOD ROAD SHARED USE PATH

STORM DRAIN PROFILES-2

SCALE AS SHOWN DATE NOVEMBER, 2023

SHEET NO. 12 OF 20

INLET PROTECTION (IP)			
ID NO.	STATION	QUANTITY	DRAINAGE AREA (AC)
CIP 1.1	STA. 14+24, LT	1 EA	0.7
CIP 1.2	STA. 15+19, LT	1 EA	0.47



STABILIZED CONSTRUCTION ENTRANCE (SCE)		
ID NO.	QUANTITY	STATION
SCE 1.1	1 EA	STA. 10+53
SCE 1.2	1 EA	STA. 14+98

SILT FENCE		
ID NO.	QUANTITY	STATION
SF 1.1	47 LF	STA. 12+78, LT
SF 1.2	30 LF	STA. 13+59, LT
SF 1.3	5 LF	STA. 14+10, LT
SF 1.4	20 LF	STA. 14+32, LT
SF 1.5	42 LF	STA. 14+73, LT
SF 1.6	34 LF	STA. 15+88, LT
SF 1.7	42 LF	STA. 16+57, LT

12-INCH FILTER LOG		
ID NO.	QUANTITY	STATION
FL 1.1	35 LF	STA. 10+20, RT
FL 1.2	228 LF	STA. 10+50, LT

TREE PROTECTION FENCE (TPF)		
ID NO.	QUANTITY	STATION
TPF 1.1	207 LF	STA. 10+20, RT

- LEGEND**
- LOD — LIMITS OF DISTURBANCE
 - SF — SILT FENCE
 - SCE — STABILIZED CONSTRUCTION ENTRANCE
 - SIP — STANDARD INLET PROTECTION
 - CIP — CURB INLET PROTECTION
 - ⊗ — TREE TO BE REMOVED
 - TPF — TREE PROTECTION FENCE
 - FL-12 — 12" FILTER LOG

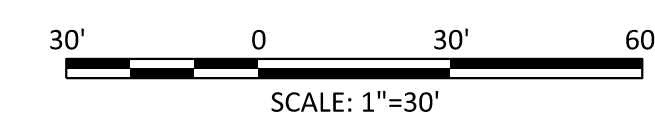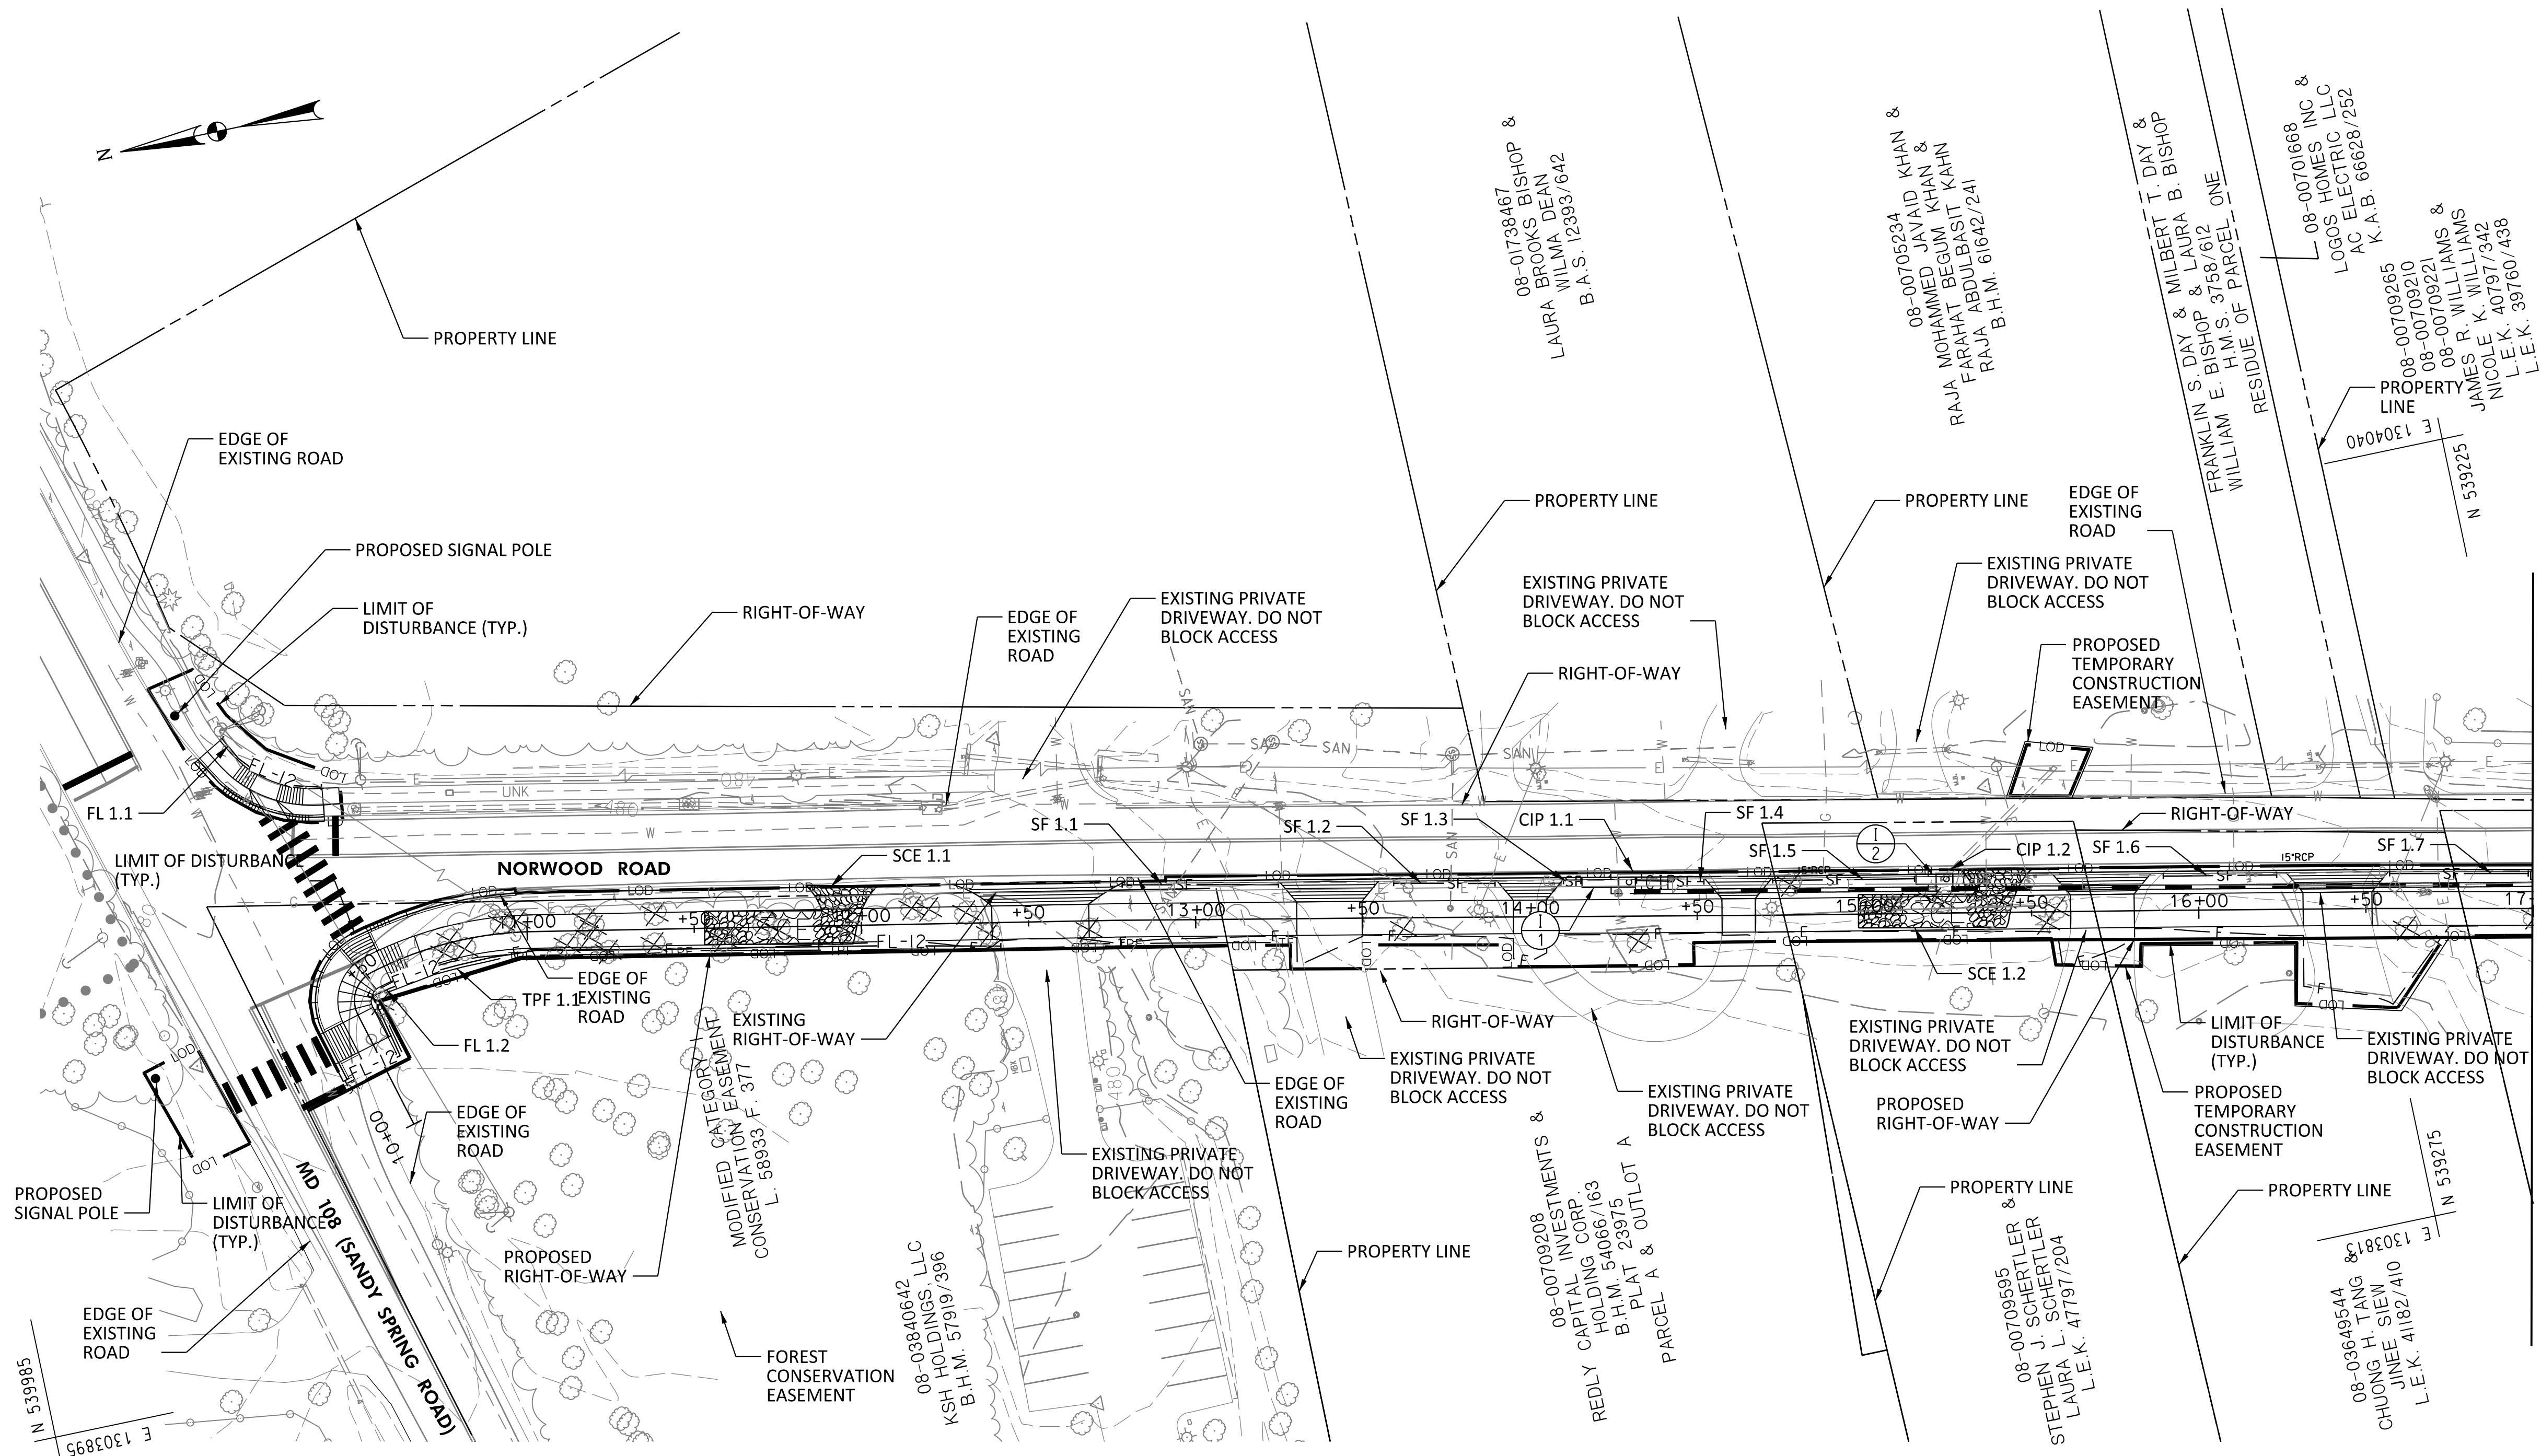


MR2025012
 WSSC MAP # 224NW01
 TAX MAP ID: JT122/JT342
 SC0006



MONTGOMERY COUNTY DEPARTMENT OF TRANSPORTATION ROCKVILLE, MARYLAND		MONTGOMERY COUNTY DEPARTMENT OF TRANSPORTATION DIVISION OF TRANSPORTATION ENGINEERING	
RECOMMENDED FOR APPROVAL Chief, Transportation Planning and Design Section APPROVED _____ Date _____		NORWOOD ROAD SHARED USE PATH EROSION AND SEDIMENT CONTROL PLAN	
Chief, Division of Transportation Engineering _____ Date _____		SCALE 1"=30' DATE NOVEMBER, 2023	
NO.	REVISION	DATE	BY
DESIGNED BY <u>RA</u> DRAWN BY <u>NM</u> CHECKED BY <u>MWM</u>		SHEET NO. <u>15</u> OF <u>20</u>	

PLOTTER: 11x17x24
 FILE: P:\Projects\1908\1908_04_Sandy_Spring_Bikeway\08_Water_Resources\ESD\ES-P001_Norwood.dgn

MATCH LINE STA. 17 + 00, SEE SHEET 14

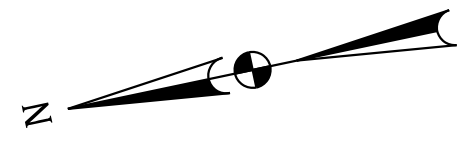

MATCH LINE STA. 17+00, SEE SHEET 13

PLOTTER: 1/16/2025
FILE: P:\Projects\2025\1988.04_Sandy_Spring_Blkway\08_Water_Resources\ESCU\ES-Plan2_Norwood.dgn



08-02795656
EDWARD E. O'BRIEN, IV &
IDA L. O'BRIEN
M.Q.R. 18664/170
PLAT 17059
LOT 2

08-00709265
08-00709210
08-00709221
JAMES R. WILLIAMS &
NICOLE K. WILLIAMS
L.E.K. 40797/342
L.E.K. 39760/438

08-00709948
KARLA ROXANA MORALES
B.H.M. 56781/2

08-00709254
JOHN B. REARDON
M.Q.R. 23939/1

08-00701965
PATRICK J. MCCORMACK
M.Q.R. 19027/161

08-00710561
JAN KOTSKA &
SIMONA KOTSKA
L.E.K. 45285/185

08-00723062
DEIDRE M. CHRISTIANSON
M.O.R. 25163/189

08-03449947
MELANIE STETTZ
L.E.K. 42129/161
PLAT 22986
LOT 6



08-00720514
SARAH T. AIKARD
M.Q.R. 14669/557

08-00718613 JR.
PAUL F. SCOTT
H.M.S. 38607/262

08-00705245
SANDRA S. DAYS &
LOREN A. DAYS
B.A.S. 12585/212

08-03371993
BANCROFT COMMUNITY ASSOCIATION
M.Q.R. 27147/636
PLAT 22132
PARCEL N

08-03449936
MUHAMMAD H. AWNI &
ANNE P. AWNI
L.E.K. 46502/300
PLAT 22986
LOT 5

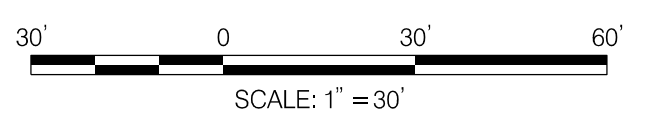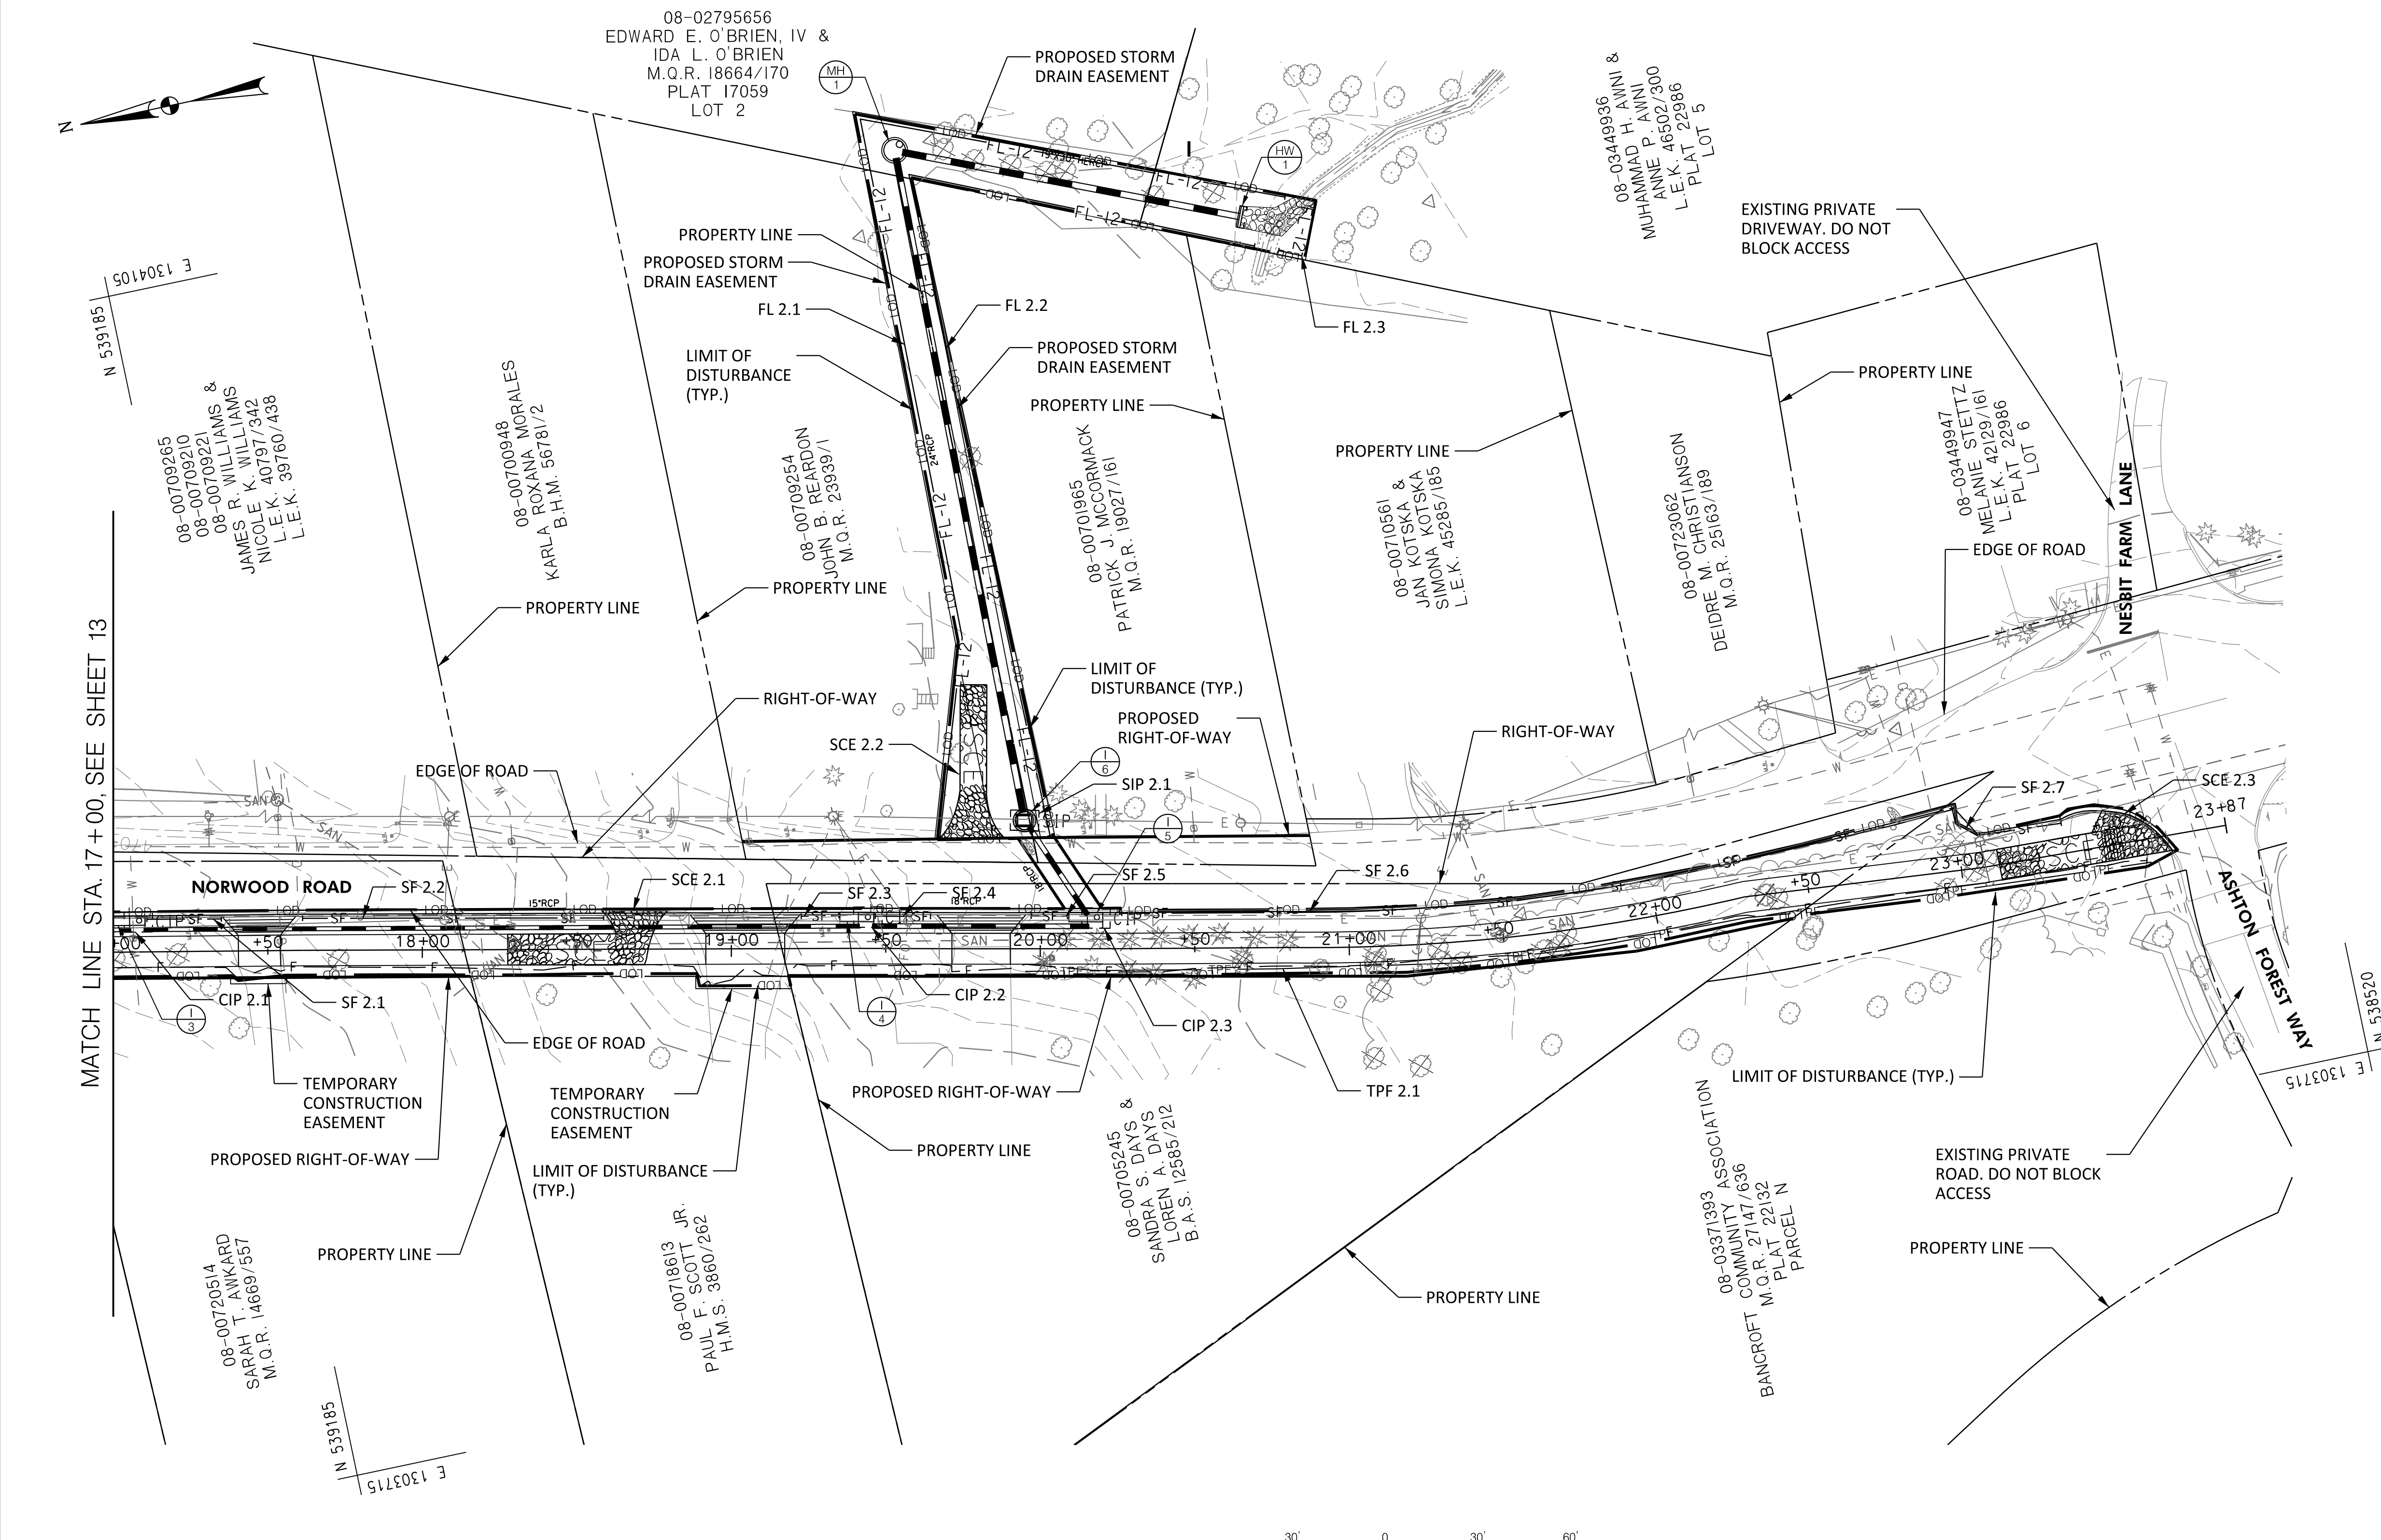

INLET PROTECTION (IP)			
ID NO.	STATION	QUANTITY	DRAINAGE AREA (AC)
CIP 2.1	STA. 17+04, LT	1 EA	0.45
CIP 2.2	STA. 19+40, LT	1 EA	0.67
CIP 2.3	STA. 20+15, LT	1 EA	0.75
SIP 2.1	STA. 19+90, LT	1 EA	0.70

STABILIZED CONSTRUCTION ENTRANCE (SCE)		
ID NO.	QUANTITY	STATION
SCE 2.1	1 EA	STA. 18+28
SCE 2.2	1 EA	STA. 19+70, LT
SCE 2.3	1 EA	STA. 23+12

SILT FENCE		
ID NO.	QUANTITY	STATION
SF 2.1	24 LF	STA. 17+11, LT
SF 2.2	98 LF	STA. 17+62, LT
SF 2.3	12 LF	STA. 19+23, LT
SF 2.4	18 LF	STA. 19+47, LT
SF 2.5	12 LF	STA. 19+97, LT
SF 2.6	270 LF	STA. 20+26, LT
SF 2.7	41 LF	STA. 22+98, LT

12-INCH FILTER LOG		
ID NO.	QUANTITY	STATION
FL 2.1	376 LF	STA. 19+88, LT
FL 2.2	333 LF	STA. 20+03, LT
FL 2.3	24 LF	STA. 20+77, LT

TREE PROTECTION FENCE (TPF)		
ID NO.	QUANTITY	STATION
TPF 2.1	367 LF	STA. 19+95, RT


- LEGEND**
- LIMITS OF DISTURBANCE
 - SILT FENCE
 - STABILIZED CONSTRUCTION ENTRANCE
 - STANDARD INLET PROTECTION
 - CURB INLET PROTECTION
 - TREE TO BE REMOVED
 - TREE PROTECTION FENCE
 - 12" FILTER LOG

MR2025012
WSSC MAP # 224NW01
TAX MAP ID: JT122/JT342
SC0007

<p>MONTGOMERY COUNTY DEPARTMENT OF TRANSPORTATION ROCKVILLE, MARYLAND</p> <p>RECOMMENDED FOR APPROVAL</p> <p>Chief, Transportation Planning and Design Section _____ Date _____</p> <p>APPROVED</p> <p>Chief, Division of Transportation Engineering _____ Date _____</p>		<p>MONTGOMERY COUNTY DEPARTMENT OF TRANSPORTATION DIVISION OF TRANSPORTATION ENGINEERING</p> <p>NORWOOD ROAD SHARED USE PATH</p> <p>EROSION AND SEDIMENT CONTROL PLAN</p> <p>SCALE 1"=30' DATE NOVEMBER, 2023</p>		
		<p>DESIGNED BY <u>RA</u> DRAWN BY <u>NM</u> CHECKED BY <u>MWM</u></p>		
NO.	REVISION	DATE	BY	<p>SHEET NO. <u>16</u> OF <u>20</u></p>

Tree Protection Fence Detail


Not to scale

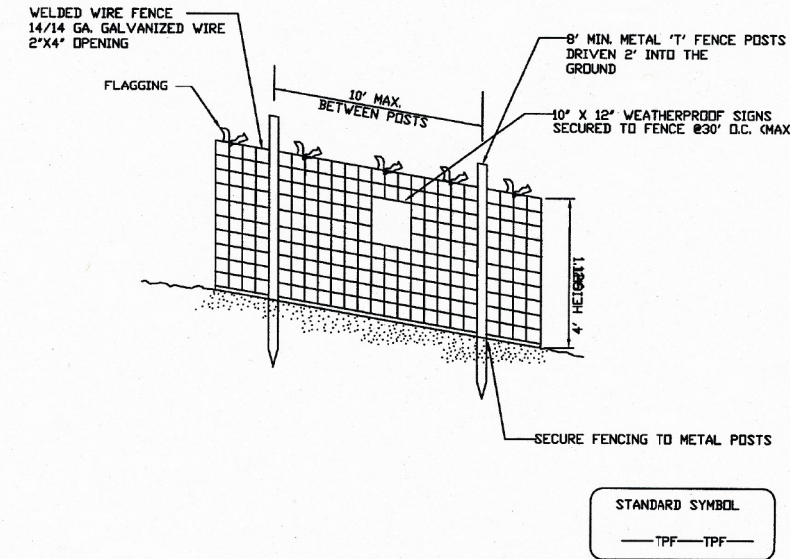


NOTES

1. Practice may be combined with sediment control fencing.
2. Location and limits of fencing should be coordinated in field with arborist.
3. Boundaries of protection area should be staked prior to installing protective device.
4. Root damage should be avoided.
5. Protection signage is required.
6. Fencing shall be maintained throughout construction.


Montgomery County Planning Department • M-NCPPC
MontgomeryPlanning.org

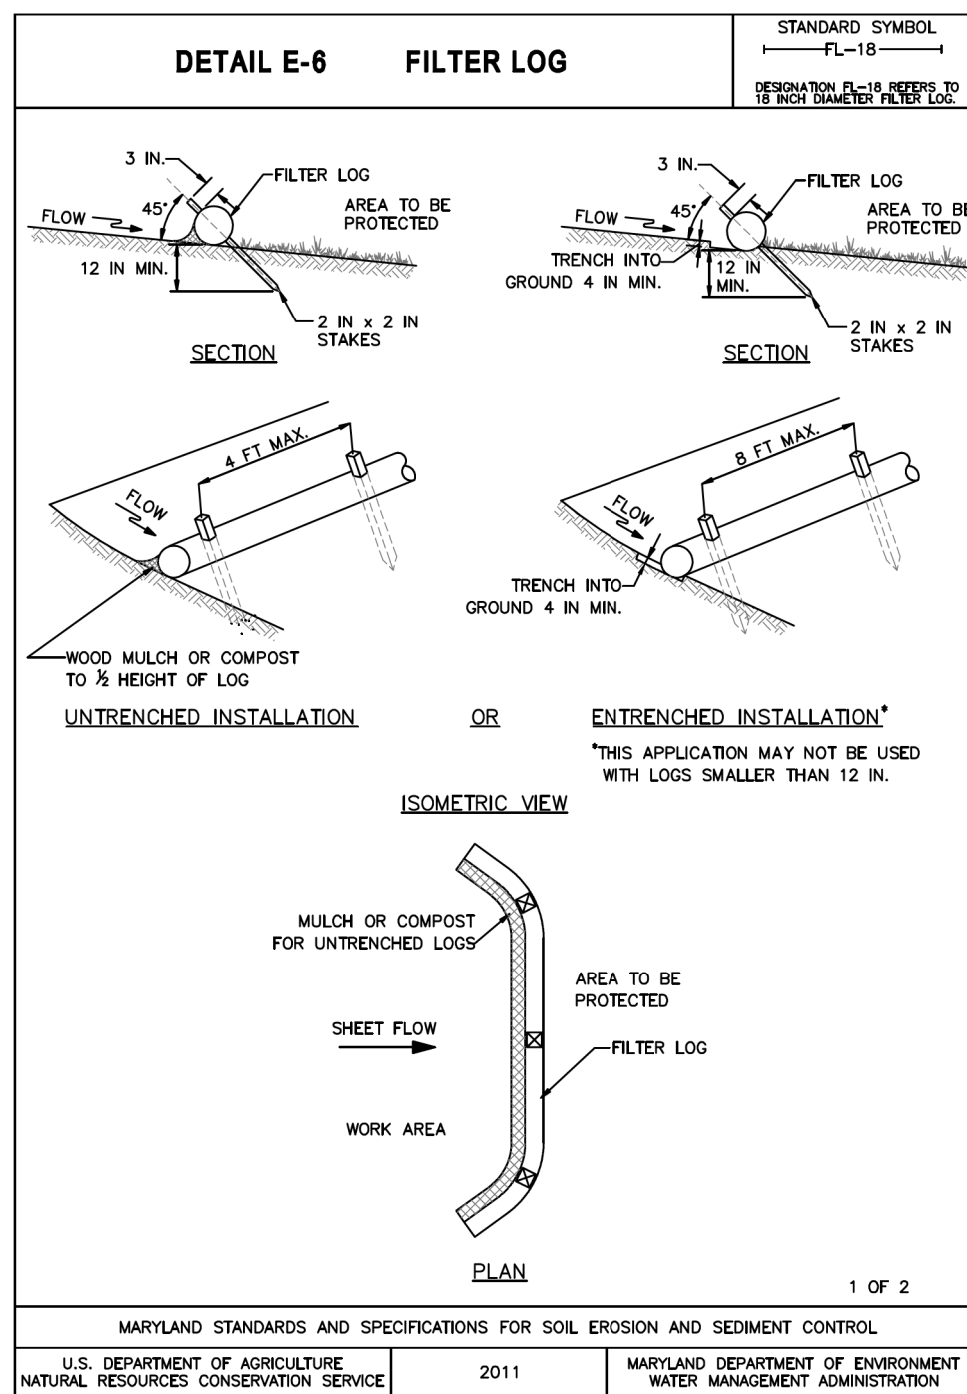

MARYLAND STANDARDS AND SPECIFICATIONS FOR SOIL EROSION AND SEDIMENT CONTROL
U.S. DEPARTMENT OF AGRICULTURE NATURAL RESOURCES CONSERVATION SERVICE 2011 MARYLAND DEPARTMENT OF ENVIRONMENT WATER MANAGEMENT ADMINISTRATION
E.15

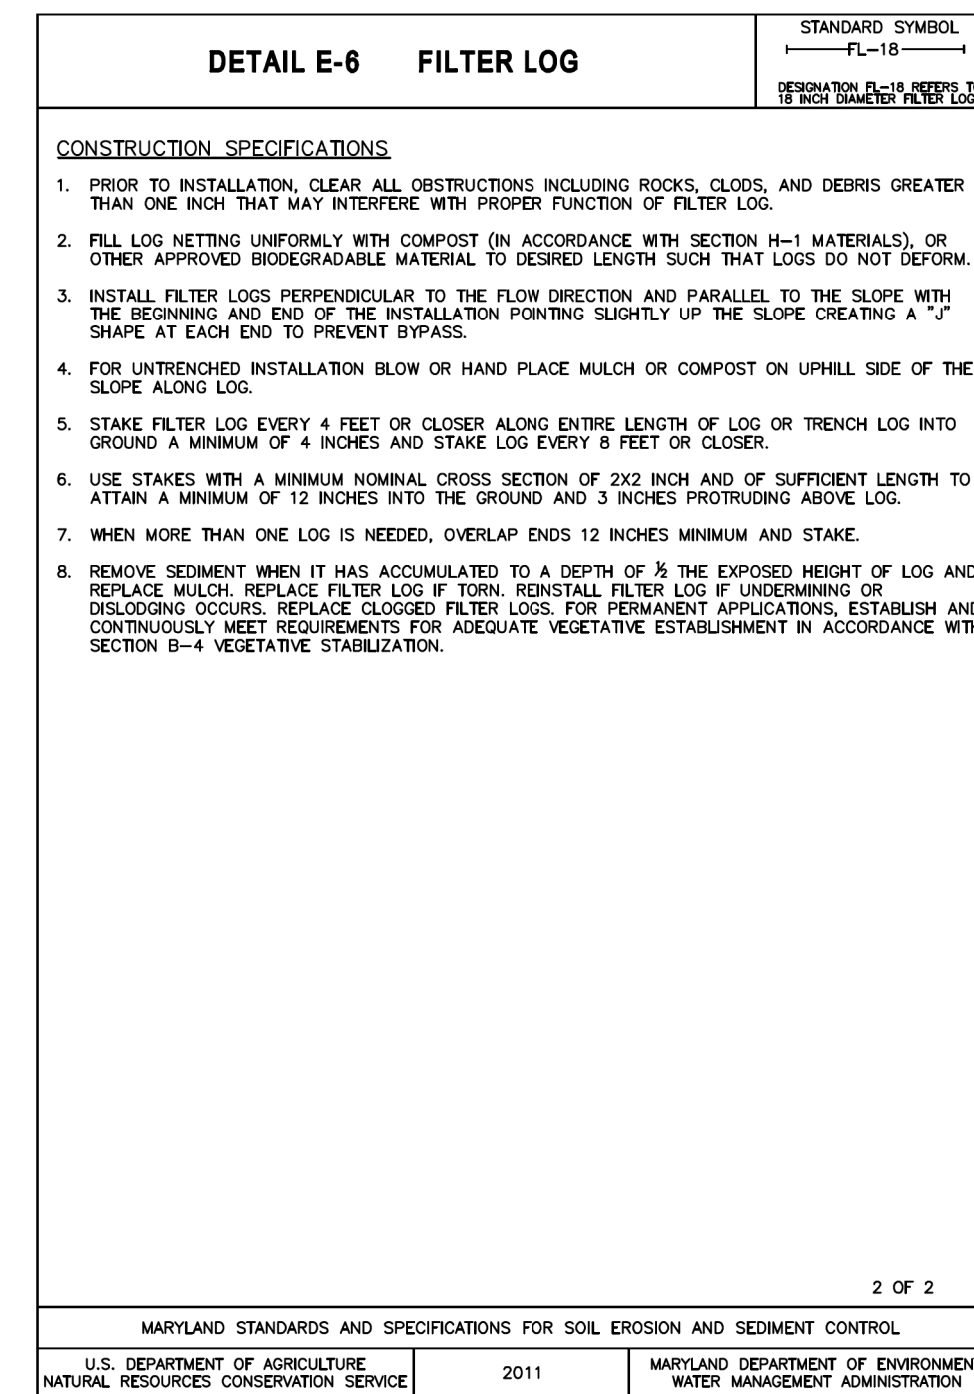


MARYLAND STANDARDS AND SPECIFICATIONS FOR SOIL EROSION AND SEDIMENT CONTROL
U.S. DEPARTMENT OF AGRICULTURE NATURAL RESOURCES CONSERVATION SERVICE 2011 MARYLAND DEPARTMENT OF ENVIRONMENT WATER MANAGEMENT ADMINISTRATION
E.16

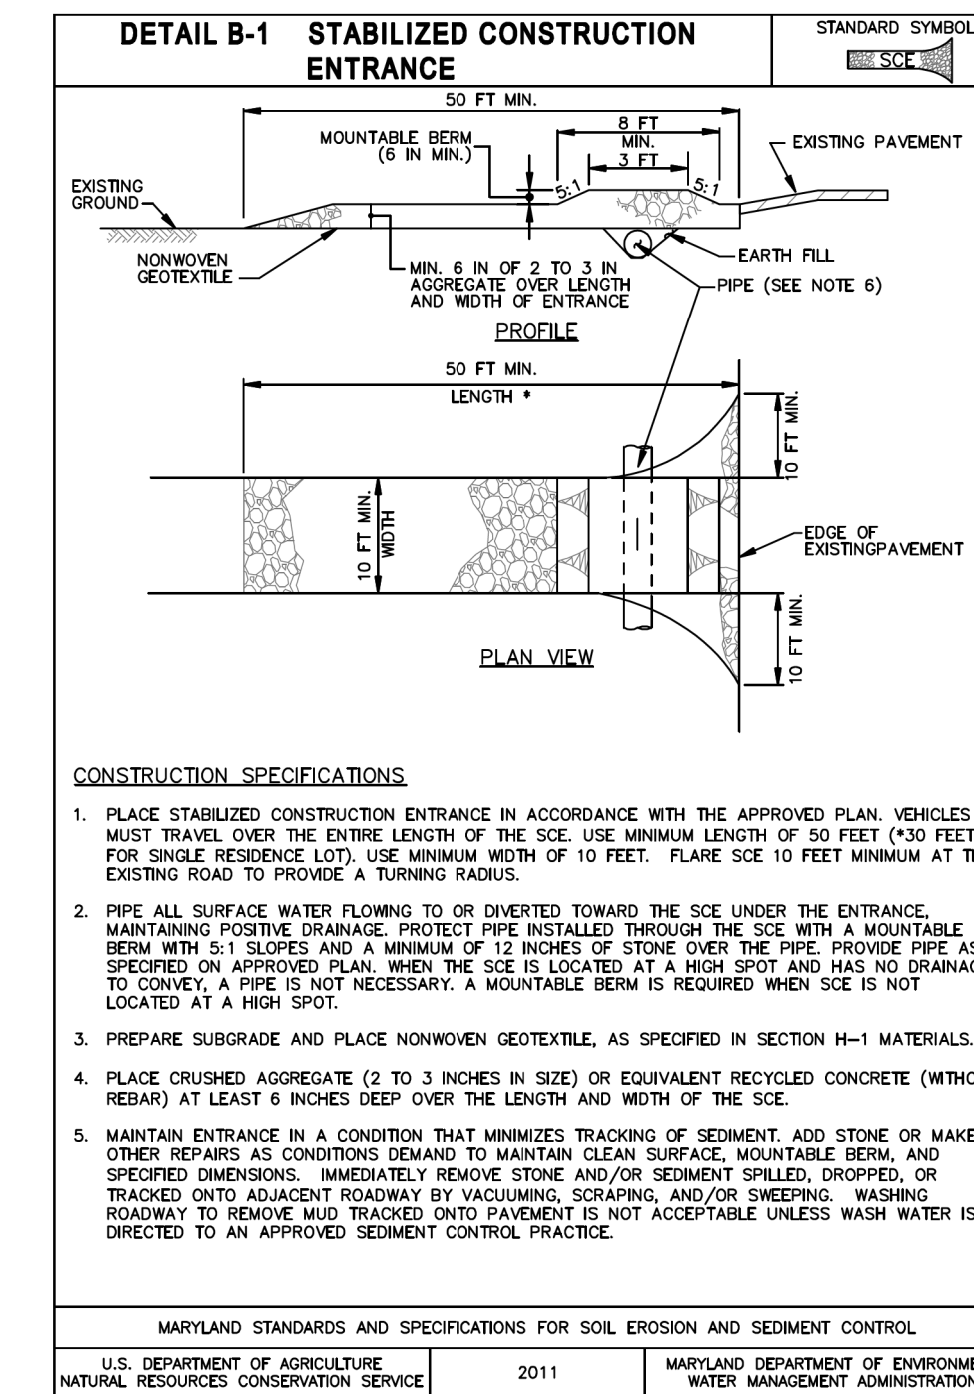


CONSTRUCTION SPECIFICATIONS

1. PLACE STABILIZED CONSTRUCTION ENTRANCE IN ACCORDANCE WITH THE APPROVED PLAN. VEHICLES MUST TRAVEL OVER THE ENTIRE LENGTH OF THE SCE. USE MINIMUM LENGTH OF 50 FEET (50 FEET FOR SINGLE RESIDENCE LOT). USE MINIMUM WIDTH OF 10 FEET. FLARE SCE 10 FEET MINIMUM AT THE EXISTING ROAD TO PROVIDE A TURNING RADIUS.
2. PIPE ALL SURFACE WATER FLOWING TO OR DIVERTED TOWARD THE SCE UNDER THE ENTRANCE. MAINTAINING POSITIVE DRAINAGE. PROTECT PIPE INSTALLED THROUGH THE SCE WITH A MOUNTABLE BERM WITH 5:1 SLOPES AND A MINIMUM OF 12 INCHES OF STONE OVER THE PIPE. PROVIDE PIPE AS SPECIFIED ON APPROVED PLAN. WHEN THE SCE IS LOCATED AT A HIGH SPOT AND HAS NO DRAINAGE TO CONVEY, A PIPE IS NOT NECESSARY. A MOUNTABLE BERM IS REQUIRED WHEN SCE IS NOT LOCATED AT A HIGH SPOT.
3. PREPARE SUBGRADE AND PLACE NONWOVEN GEOTEXTILE, AS SPECIFIED IN SECTION H-1 MATERIALS.
4. PLACE CRUSHED AGGREGATE (2 TO 3 INCHES IN SIZE) OR EQUIVALENT RECYCLED CONCRETE (WITHOUT RESINS) AT LEAST 6 INCHES DEEP OVER THE LENGTH AND WIDTH OF THE SCE.
5. MAINTAIN ENTRANCE IN A CONDITION THAT MINIMIZES TRACKING OF SEDIMENT. ADD STONE OR MAKE OTHER REPAIRS AS CONDITIONS DEMAND TO MAINTAIN CLEAN SURFACE. MOUNTABLE BERM, AND SPECIFIED DIMENSIONS. IMMEDIATELY REMOVE STONE AND/OR SEDIMENT SPILLED, DROPPED, OR TRACKED ONTO ADJACENT ROADWAY BY VACUUMING, SCRAPING, AND/OR SWEEPING. WASHING ROADWAY TO REMOVE MUD TRACKED ONTO PAVEMENT IS NOT ACCEPTABLE UNLESS WASH WATER IS DIRECTED TO AN APPROVED SEDIMENT CONTROL PRACTICE.

MARYLAND STANDARDS AND SPECIFICATIONS FOR SOIL EROSION AND SEDIMENT CONTROL
U.S. DEPARTMENT OF AGRICULTURE NATURAL RESOURCES CONSERVATION SERVICE 2011 MARYLAND DEPARTMENT OF ENVIRONMENT WATER MANAGEMENT ADMINISTRATION
B.2

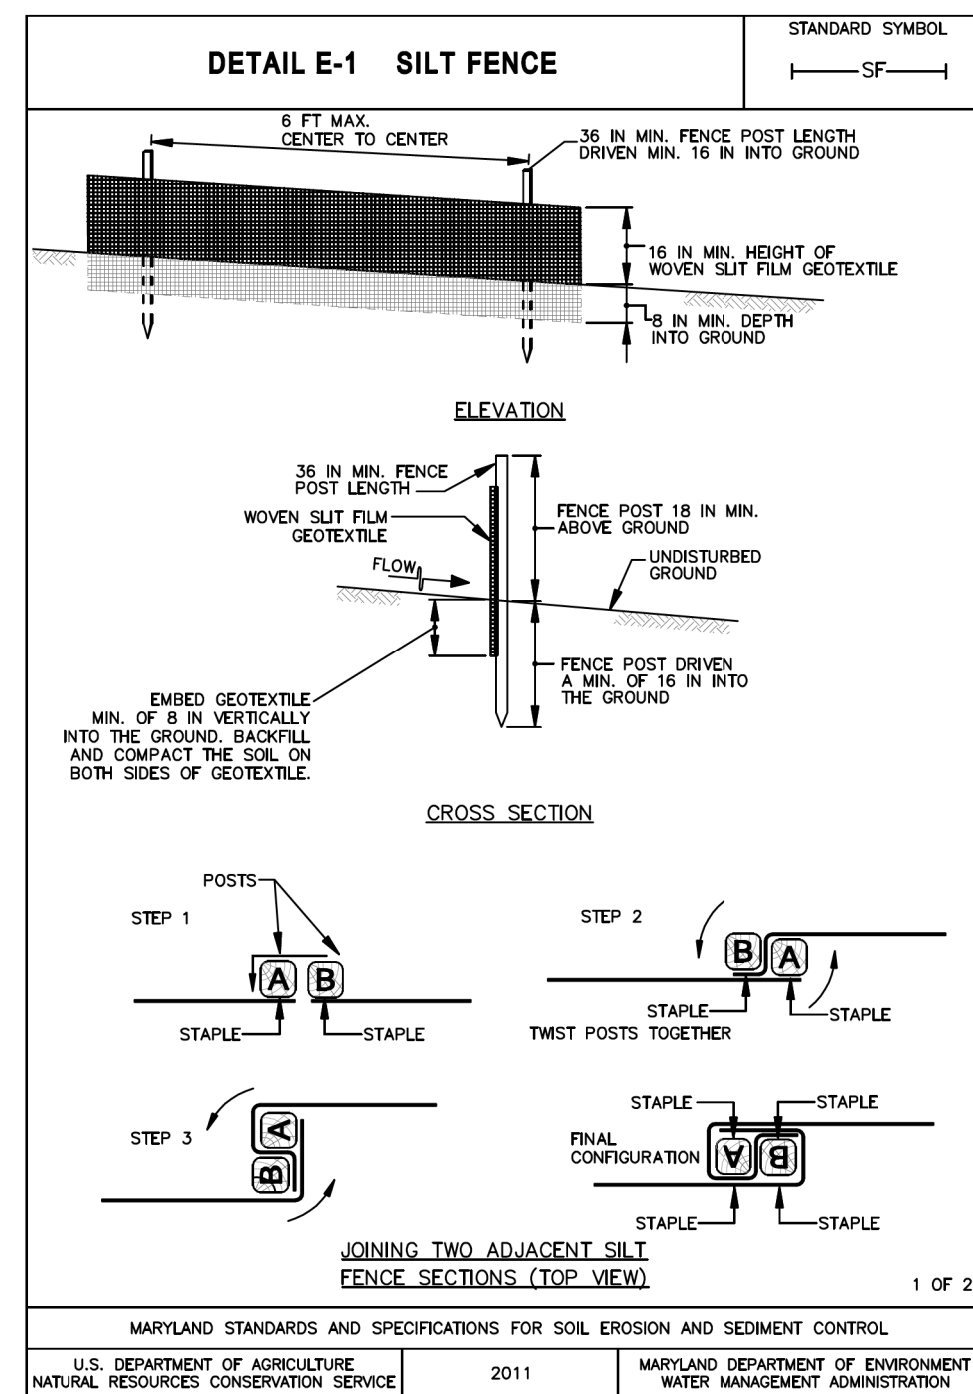

MARYLAND STANDARDS AND SPECIFICATIONS FOR SOIL EROSION AND SEDIMENT CONTROL
U.S. DEPARTMENT OF AGRICULTURE NATURAL RESOURCES CONSERVATION SERVICE 2011 MARYLAND DEPARTMENT OF ENVIRONMENT WATER MANAGEMENT ADMINISTRATION
E.2

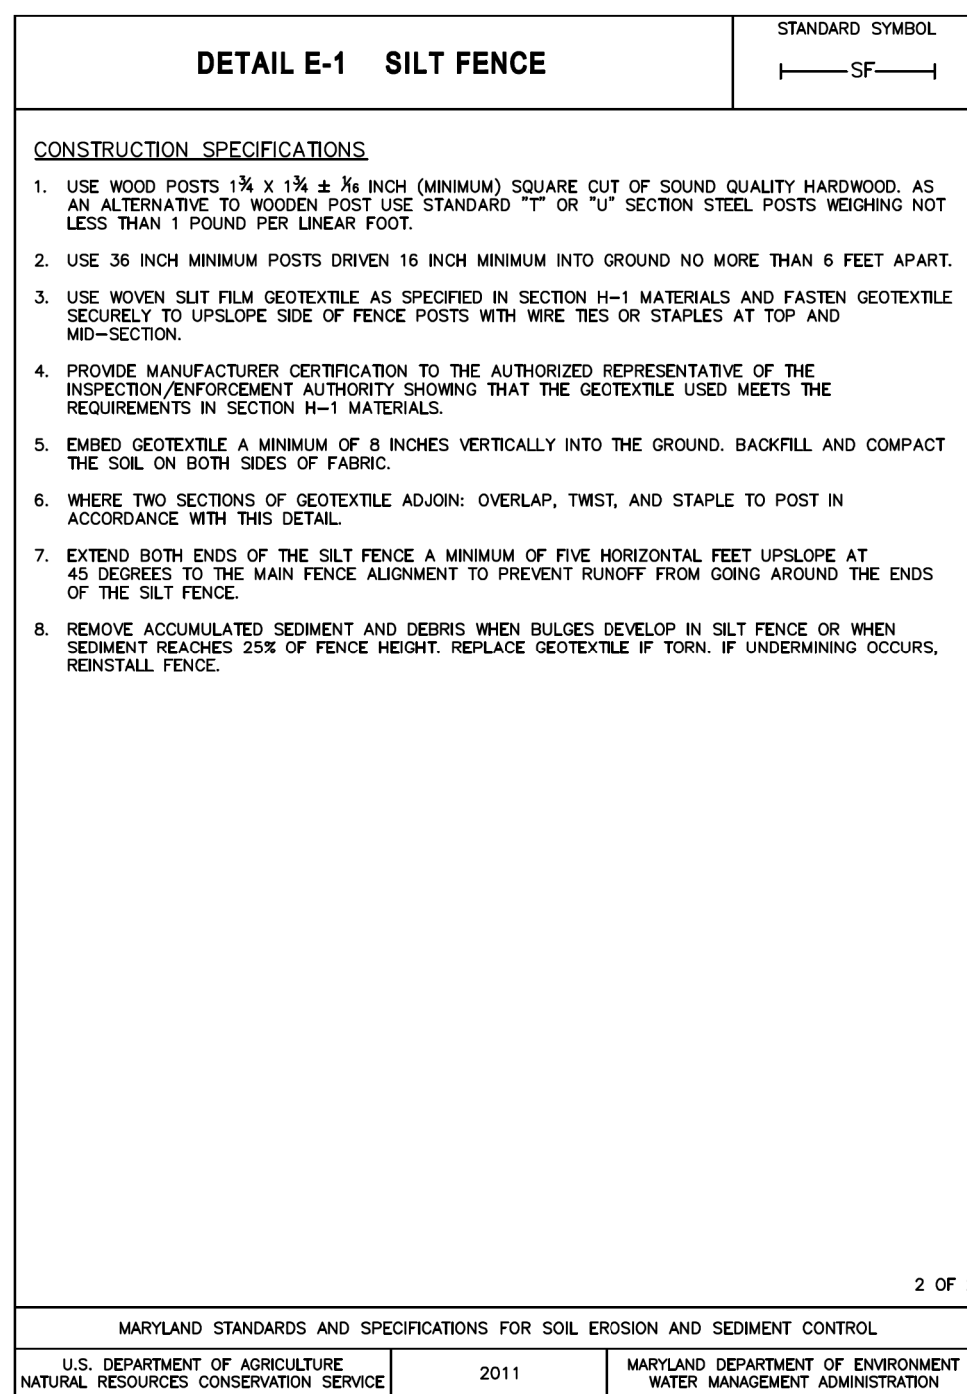

MARYLAND STANDARDS AND SPECIFICATIONS FOR SOIL EROSION AND SEDIMENT CONTROL
U.S. DEPARTMENT OF AGRICULTURE NATURAL RESOURCES CONSERVATION SERVICE 2011 MARYLAND DEPARTMENT OF ENVIRONMENT WATER MANAGEMENT ADMINISTRATION
E.3



PLOTTED: 1/16/2023
FILE: P:\Projects\2023\1908.04_Sandy_Spring_Bikeway\04_Water_Resources\ESCD\ESD-D001_Norwood.dgn

MR2025012
WSSC MAP # 224NW01
TAX MAP ID: JT122/JT342

SC0008

MONTGOMERY COUNTY
DEPARTMENT OF TRANSPORTATION
ROCKVILLE, MARYLAND

MONTGOMERY COUNTY
DEPARTMENT OF TRANSPORTATION
DIVISION OF TRANSPORTATION ENGINEERING

NORWOOD ROAD SHARED USE PATH

EROSION AND SEDIMENT
STANDARD DETAILS

SCALE 1"=30' DATE NOVEMBER, 2023

SHEET NO. 17 OF 20

RECOMMENDED FOR APPROVAL

Chief, Transportation Planning and Design Section Date

Chief, Division of Transportation Engineering Date

DESIGNED BY RA DRAWN BY NM CHECKED BY MWM

NO. REVISION DATE BY

PROJECT DESCRIPTION

I. GENERAL

THIS PROJECT INVOLVES THE RECONSTRUCTION OF AN EXISTING TRAFFIC SIGNAL AT THE INTERSECTION OF MD 108 (OLNEY SANDY SPRING ROAD) AND NORWOOD ROAD IN MONTGOMERY COUNTY. THE MODIFICATIONS INCLUDE THE ADDITION OF APS PUSH BUTTONS, PEDESTRIAN SIGNAL HEADS, ADVANCED VIDEO DETECTION, AND THE TRANSFER OF SIGNAL HEADS FROM SPAN WIRE TO MAST ARM POLES. MD 108 IS ASSUMED TO RUN IN AN EAST-WEST DIRECTION.

II. INTERSECTION OPERATION

THE INTERSECTION IS TO OPERATE IN A NEMA 6-PHASE, FULLY-ACTUATED MODE, WITH THE MD 108 (OLNEY SANDY SPRING ROAD) APPROACHES OPERATING CONCURRENTLY AND THE NORWOOD ROAD APPROACH OPERATING SPLIT. PERMISSIVE LEFT TURN PHASING WILL BE PROVIDED FOR THE WESTBOUND MD 108 APPROACH. AN ALTERNATIVE PEDESTRIAN PHASE IS PROVIDED ALONG THE WEST LEG OF MD 108.

III. CONTROLLER REQUIREMENTS

INSTALL A FULLY-ACTUATED FOUR-PHASE CONTROLLER WITH THREE (3) FOUR CHANNEL, TIME-DELAY-OUTPUT LOOP DETECTOR AMPLIFIERS RACK MOUNT, INTERSECTION MONITOR WITH BATTERY BACK-UP FOR PHONE DROP, NIC MODULE, RACK DETECTOR SYSTEM, AND ASSOCIATED HARNESSES HOUSED IN A NEMA SIZE '5' BASE MOUNTED CABINET.

GENERAL NOTES

- FOR FINAL PAVEMENT MARKINGS, REFER TO THE PAVEMENT MARKING PLANS, AS APPLICABLE; OTHER THAN THOSE DETAILED ON THE PLAN. ALL PAVEMENT MARKINGS SHALL BE INSTALLED IN ACCORDANCE WITH ADMINISTRATION STANDARDS.
- THE CONTRACTOR SHALL BE RESPONSIBLE FOR TERMINATING ALL SIGNAL CABLE TO THE APPROPRIATE TERMINALS AND PROPERLY LABELING EACH CABLE.
- ALL TRAFFIC SIGNAL FOUNDATIONS SHALL BE INSTALLED AT THE FINAL SIDEWALK OR CURB GRADE FOR CLOSED SECTIONS, HIGHEST ROADWAY PROFILE GRADE FOR OPEN SECTIONS, TO MEET CLEARANCES AS SPECIFIED IN THE APPROPRIATE 800 SERIES STANDARD PLATES. THE CONTRACTOR SHALL VERIFY ULTIMATE GRADES PRIOR TO THE INSTALLATION OF ALL SIGNAL EQUIPMENT.
- FOR MONTGOMERY COUNTY PROJECTS, THE CONTRACTOR SHALL BE RESPONSIBLE FOR DELIVERING THE VIDEO INTERFACE EQUIPMENT TO THE MONTGOMERY COUNTY SIGNAL SHOP. COUNTY FORCES WILL COMPLETE THE RETROFIT WORK IN THE EXISTING CABINET.
- DISCONNECTING AND SPLICING OF INTERCONNECT CABLE SHALL BE PERFORMED BY ???? FORCES. THE CONTRACTOR SHALL RUN THE INTERCONNECT CABLE INTO THE BASE OF EACH CABINET AND PROPERLY TAG THE CABLE. CONTACT MR./MS. ??? AT (XXX) XXX-XXXX SEVENTY-TWO HOURS IN ADVANCE OF INTENDED WORK.
- ALL UNDERGROUND AND OVERHEAD UTILITIES SHOWN ON THESE PLANS ARE SCHEMATIC ONLY AND MAY NOT BE COMPLETE. THE CONTRACTOR SHALL BE RESPONSIBLE FOR NOTIFYING MISS UTILITY PRIOR TO CONSTRUCTION SO THAT ALL UTILITIES MAY BE LOCATED IN THE FIELD. IF THE CONTRACTOR PERCEIVES THAT A CONFLICT BETWEEN THE UTILITIES AND THE TRAFFIC SIGNAL WILL OCCUR, THE CONTRACTOR SHALL NOTIFY THE PROJECT ENGINEER IMMEDIATELY SO THAT THE CONFLICT MAY BE RESOLVED.
- FOR DEVELOPER JOBS, NOTE: CONTROLLER AND CABINET SHALL BE PURCHASED FROM ECONOLITE AND DELIVERED TO S.H.A. SIGNAL SHOP FOR WIRING AND TESTING A MINIMUM OF THREE (3) WEEKS PRIOR TO INSTALLATION. CONTACT MR. ED RODENHIZER (410) 787-7650 TO COORDINATE THIS EFFORT.
- THE CONTRACTOR SHALL MAINTAIN THE CONTINUOUS OPERATION OF ALL INTERCONNECT, VEHICULAR, PEDESTRIAN DETECTORS, AND LIGHTING DEVICES. IF ANY DEVICE IS DAMAGED BY THE CONTRACTOR, IT SHALL BE REPAIRED WITHIN 72 HOURS BY THE CONTRACTOR AT NO COST TO THE ADMINISTRATION AFTER NOTIFICATION BY THE ENGINEER.
- DURING CONSTRUCTION, PROPOSED SIGNAL EQUIPMENT SHALL NOT BLOCK EXISTING SIGNAL EQUIPMENT
- ALL UNUSED CABLE SHALL BE REMOVED AND DISPOSED OF BY THE CONTRACTOR

PROJECT CONTACT LIST

DISTRICT 3	OFFICE OF TRAFFIC AND SAFETY
VACANT ASSISTANT DISTRICT ENGINEER - TRAFFIC 301-513-7404	REBECCA LICHTENSTEIN, P.E. CHIEF, TRAFFIC OPERATIONS DIVISION 410-787-7630
MR. MARK LOEFFLER DISTRICT UTILITY ENGINEER 301-513-7350	MR. ANTOINE YATES ASSISTANT DIVISION CHIEF, TRAFFIC OPERATIONS DIVISIONS 410-787-7625
MR. GREGORY EDWARDS ASSISTANT DISTRICT ENGINEER - MAINTENANCE 301-513-7304	MR. MICHAEL BASSO SECTION CHIEF, SIGNAL OPERATIONS SECTION 410-787-7657
MS. AMY ANDREWS ASSISTANT DISTRICT ENGINEER - CONSTRUCTION (ADMIN.) 301-513-7300	MR. TODD JONES SIGN SHOP MANAGER 410-787-7676
VACANT ASSISTANT DISTRICT ENGINEER - CONSTRUCTION (FIELD) 301-513-7336	MR. MICHAEL BOYLE WAREHOUSE SECTION CHIEF 410-787-7673

EQUIPMENT LIST

EQUIPMENT LIST A.

ITEM NUMBER	QUANTITY	DESCRIPTION
2	EA	THREE-PHASE FULLY-ACTUATED CONTROLLER WITH VIDEO INTERFACE EQUIPMENT (1-3 CAMERAS), 3 FOUR-CHANNEL LOOP DETECTOR AMPLIFIERS AND INTERSECTION MONITOR HOUSED IN A NEMA SIZE 5 BASE MOUNTED CABINET
2	EA	SHEET ALUMINUM SIGNS TO CONSIST OF (POLE MOUNT) R10-3(1) SIGN (9 IN. X 15 IN) TO READ " PUSH BUTTON TO CROSS SANDY SPRING ROAD"
2	EA	R10-3(1) SIGN (9 IN. X 15 IN) TO READ " PUSH BUTTON TO CROSS NORWOOD ROAD"
1	EA	M1-5(1) SIGN (78 IN. X 36 IN) - MAST ARM MOUNT
2	EA	R10-11b(1) SIGN (36 IN. X 36 IN) - MAST ARM MOUNT
2	EA	D-3(2) SIGN (VAR. X 16 IN) - MAST ARM MOUNT
1	EA	D-3(1) SIGN (VAR. X 16 IN) - MAST ARM MOUNT

EQUIPMENT LIST B.

ITEM NUMBER	QUANTITY	DESCRIPTION
120500	1	MAINTENANCE OF TRAFFIC
801004	11	CY CONCRETE FOR SIGNAL FOUNDATION
114280	135	LF REMOVAL OF EXISTING PERMANENT PAVEMENT MARKING LINES
549617	202	LF 24 INCH WHITE PREFORMED THERMOPLASTIC PAVEMENT MARKING LINES
549603	714	LF 5 INCH YELLOW PREFORMED THERMOPLASTIC PAVEMENT MARKING LINES
860284	21	EA 12 INCH LED VEHICULAR TRAFFIC SIGNAL HEAD SECTION
865300	1	EA 2-WIRE APS CENTRAL CONTROL UNIT
865210	4	EA AUDIBLE/TACTILE PEDESTRIAN PUSHBUTTON STATION & SIGNS
818004	4	EA 10 FOOT BREAKAWAY PEDESTAL POLE
807500	1	EA EMBEDDED METERED SERVICE PEDESTAL
816105	1	EA TRAFFIC SIGNAL CABINET NEMA SIZE 5
860285	4	EA 16 INCH LED COUNTDOWN PEDESTRIAN SIGNAL HEAD
873003	1	EA REMOVE AND DISPOSE OF EXISTING SIGNAL EQUIPMENT (PER SIGNALIZED INTERSECTION LOCATION)
818162	1	EA MAST ARM POLE AND 50' MAST ARM, ANY 'T' DIMENSION, FOUNDATION AND GROUND ROD
818164	1	EA MAST ARM POLE AND 60' MAST ARM, ANY 'T' DIMENSION, FOUNDATION AND GROUND ROD
816010	3	EA VIDEO DETECTION CAMERA TO CONTROLLER & CABLE UP TO 500 FT
805118	258	LF 4 INCH SCHEDULE 80 RIGID PVC CONDUIT - BORED
805125	149	LF 2 INCH SCHEDULE 80 RIGID PVC CONDUIT - TRENCHED
805135	31	LF 3 INCH SCHEDULE 80 RIGID PVC CONDUIT - TRENCHED
805140	119	LF 4 INCH SCHEDULE 80 RIGID PVC CONDUIT - TRENCHED
801616	29	SF INSTALL OVERHEAD OR GROUND MOUNTED SIGN (INCLUDING ALL HARDWARE)
802501	557	LF NO. 6 AWG STRANDED BARE COPPER GROUND WIRE
861105	377	LF ELECTRICAL CABLE - 2 CONDUCTOR (NO. 14 AWG)
861107	891	LF ELECTRICAL CABLE - 5 CONDUCTOR (NO. 14 AWG)
861108	508	LF ELECTRICAL CABLE - 7 CONDUCTOR (NO. 14 AWG)
803013	1	EA FURNISH AND INSTALL SIGN/LUMINAIRE SUPPORTS
837001	6	EA GROUND ROD - 3/8 INCH DIAMETER X 10 FOOT LENGTH

EQUIPMENT LIST C.

ITEM NUMBER	QUANTITY	DESCRIPTION
		EQUIPMENT TO BE SALVAGED AND RETURNED TO SHA
		ALL REMOVED MATERIALS ARE TO BECOME THE PROPERTY OF THE CONTRACTOR

MAINTENANCE OF TRAFFIC NOTE


MAINTENANCE OF TRAFFIC WILL BE HANDLED BY THE CONTRACTOR UTILIZING THE FOLLOWING STANDARD PLATES FOR TRAFFIC CONTROL:
 STANDARD NO. 104.03-01 (MULTI-LANE UNDIVIDED SHOULDER WORK)
 STANDARD NO. 104.04-01 (MULTI-LANE DIVIDED SHOULDER WORK)
 ADDITIONAL TRAFFIC CONTROL STANDARDS MAY BE USED AS DIRECTED BY THE ENGINEER.

PHASE CHART

	1	2	3	4	5	6	7	8	9	10	11
PHASE 2 AND 6	R	R	G	G	G	G	G	DW	DW	WK	WK
PED CLEARANCE	R	R	G	G	G	G	G	DW	DW	FL/DW	FL/DW
2 AND 6 CHANGE	R	R	Y	Y	Y	Y	Y	DW	DW	DW	DW
PHASE 4	G	G	R	R	R	R	R	WK	WK	DW	DW
PED CLEARANCE	G	G	R	R	R	R	R	FL/DW	FL/DW	DW	DW
4 CHANGE	Y	Y	R	R	R	R	R	DW	DW	DW	DW
FLASHING OPERATION	FL/R	FL/R	FL/Y	FL/Y	FL/Y	FL/Y	FL/Y	DARK	DARK	DARK	DARK

WIRING DIAGRAM

NOT TO SCALE

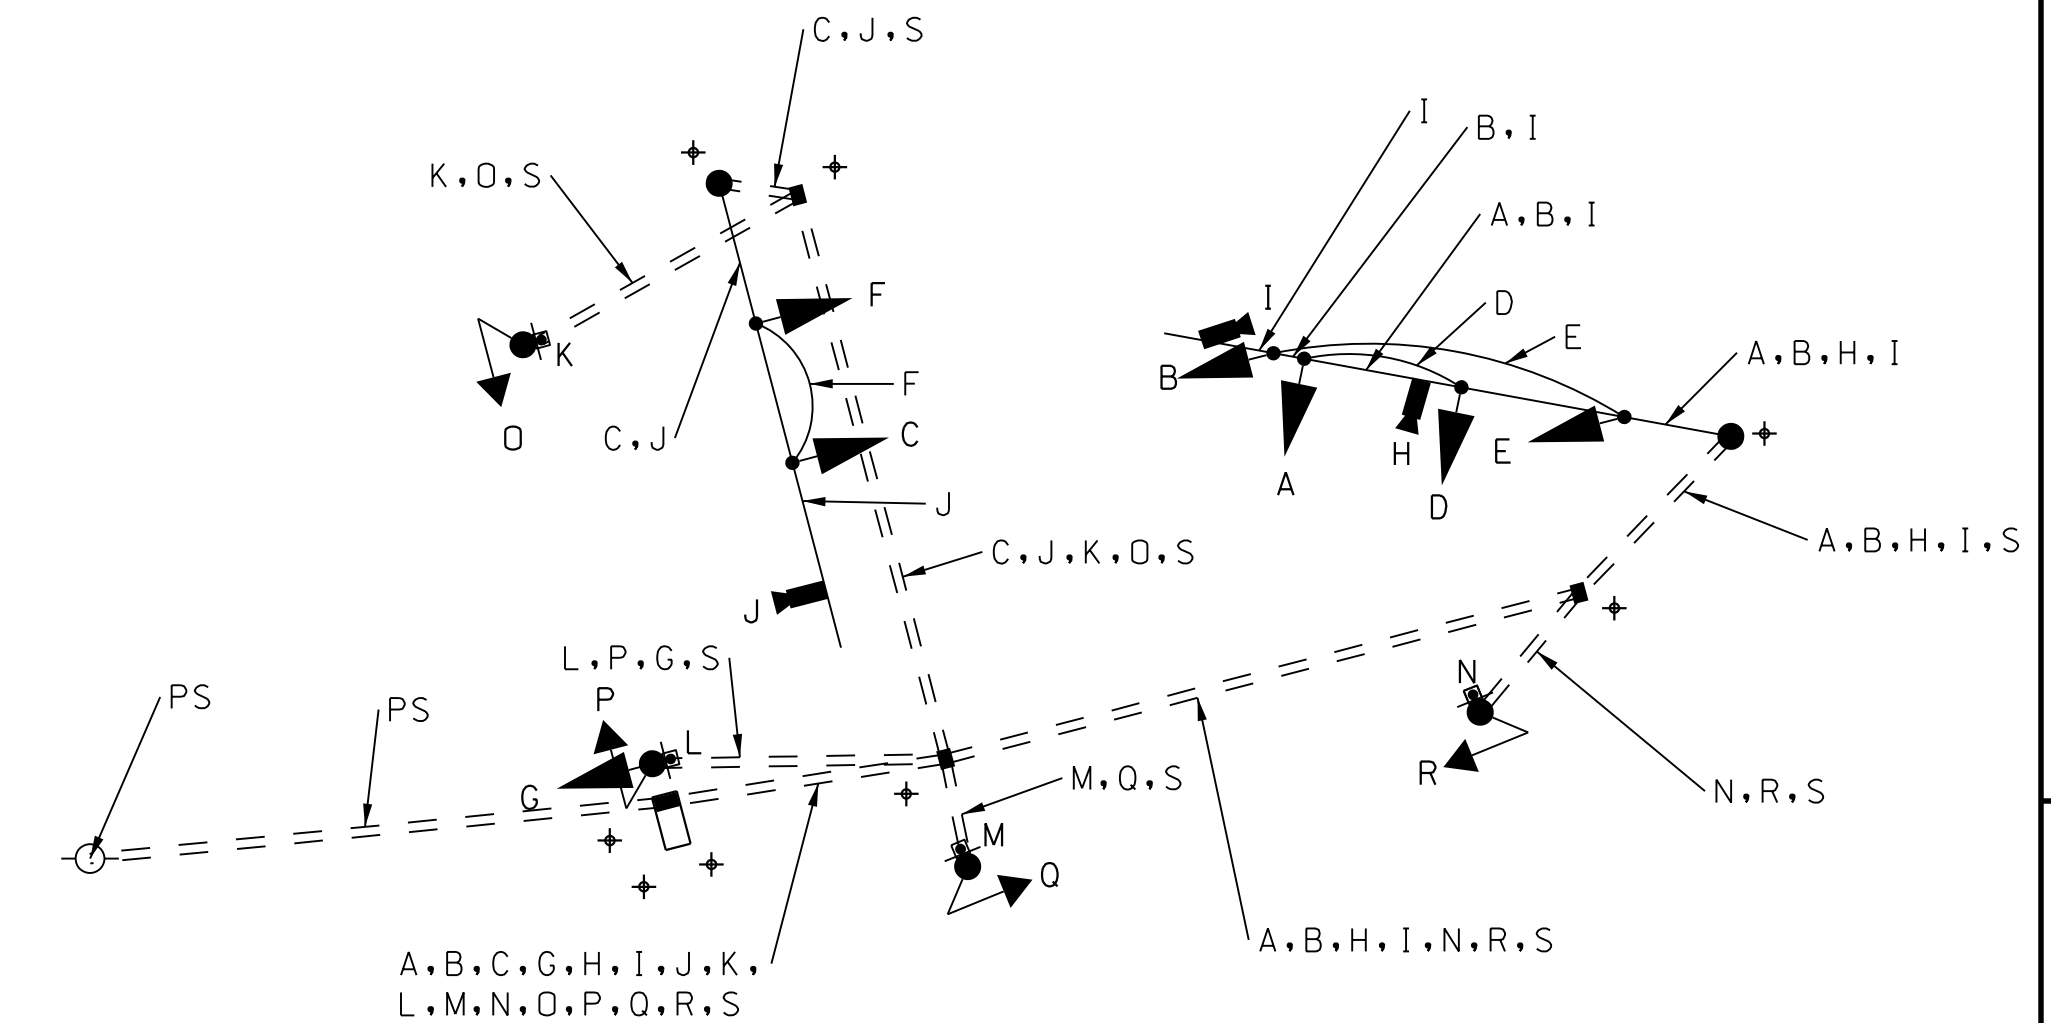

WIRING KEY

A } B } C }	7 CONDUCTOR ELECTRICAL CABLE (NO. 14 AWG)	D P O R }	5 CONDUCTOR ELECTRICAL CABLE (NO. 14 AWG) PEDESTRIAN SIGNAL HEADS	
D } E } F } G }	5 CONDUCTOR ELECTRICAL CABLE (NO. 14 AWG)		S }	#6 AWG GROUND WIRE
H } I } J }	IP-BASED VIDEO DETECTION CABLE (3/C #18)			+ }
K } L } M } N }	2 CONDUCTOR ELECTRICAL CABLE (NO. 14 AWG) APS PUSHBUTTONS			

MR2025012
WSSC MAP # 224NW01
TAX MAP ID: JT122/JT342




SANDY SPRING BIKEWAY FACILITY PLANNING
MD 108 (OLNEY SANDY SPRING ROAD)
AT NORWOOD ROAD TRAFFIC SIGNAL

GENERAL INFORMATION SHEET

SCALE	N.T.S.	ADVERTISED DATE	CONTRACT NO.	<CONTRACT NO.>
DESIGNED BY	CB	COUNTY	MONTGOMERY	
DRAWN BY	CB	LOGMILE	<LOGMILE.>	
CHECKED BY	MJ		<TIMS NO.>	
MDE/PRD	<00-AA-0000>		<TOD NO.>	
<TS NO.>	XX 1	1	SHEET NO. 19 OF 20	


THIS DOCUMENT/PLAN IS DRAFT AND SUBJECT TO CHANGE. IT IS AN INTERAGENCY/INTRA-AGENCY DELIBERATIVE COMMUNICATION THAT IS NOT FOR PUBLIC DISCLOSURE UNDER MD. GENERAL PROVISIONS CODE ANN. § 4-344 (MARYLAND PUBLIC INFORMATION ACT).

TOOLE DESIGN
 8484 GEORGIA AVENUE, SUITE 800
 SILVER SPRING, MD 20910
 PHONE: 301.927.1900
 FAX: 301.927.2800
 www.tooledesign.com

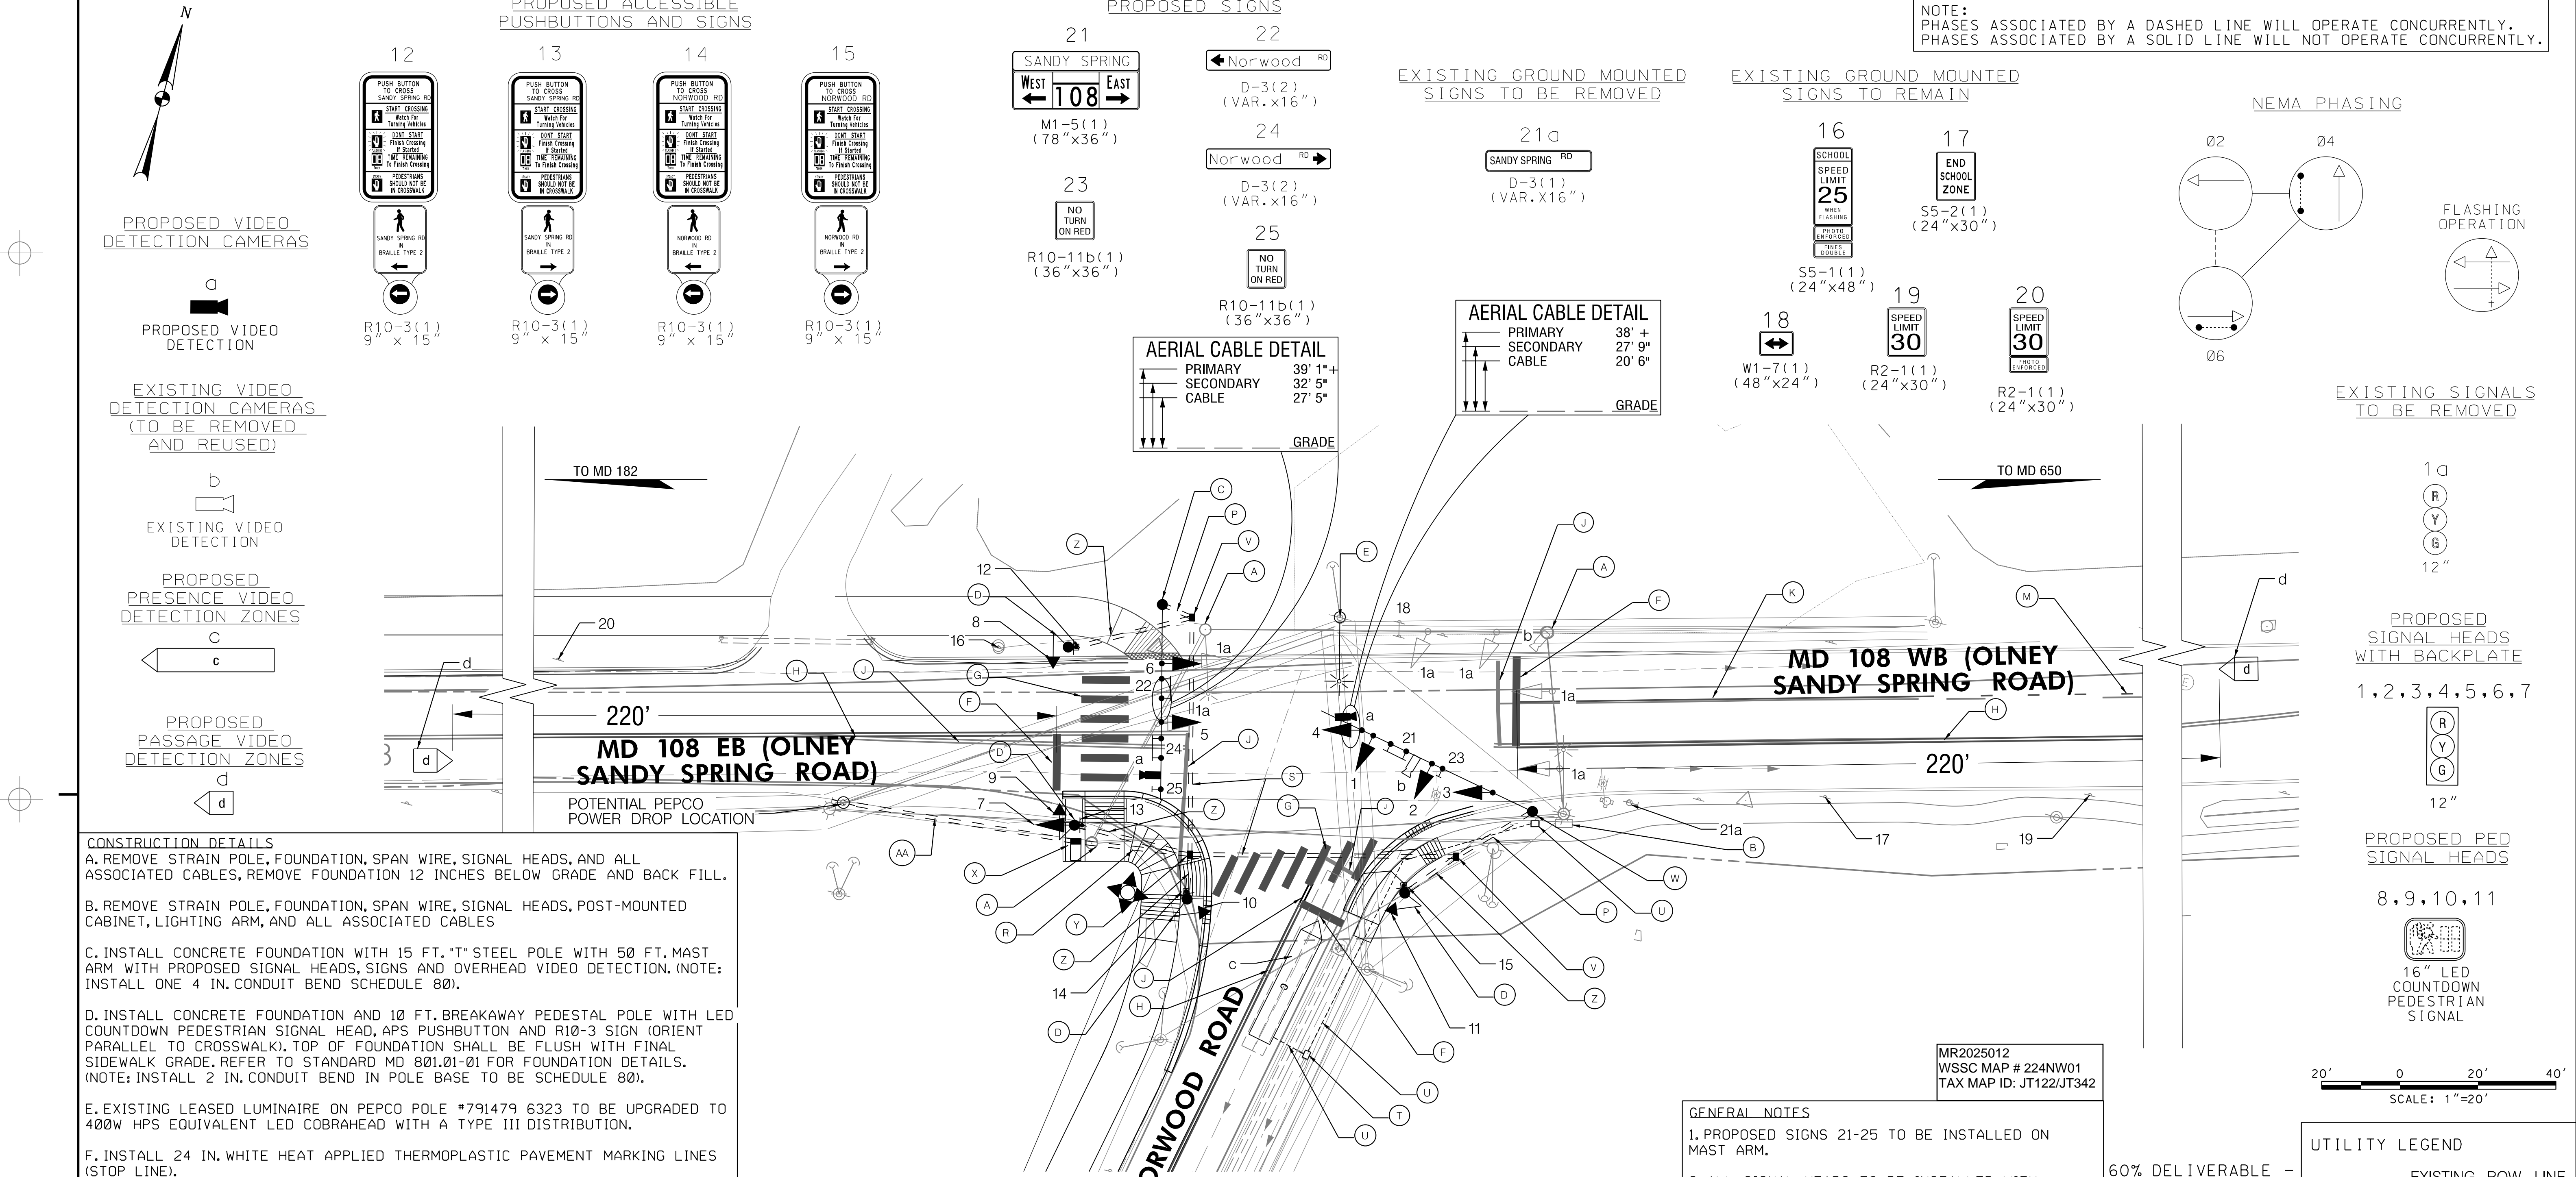

NOTE: PHASES ASSOCIATED BY A DASHED LINE WILL OPERATE CONCURRENTLY. PHASES ASSOCIATED BY A SOLID LINE WILL NOT OPERATE CONCURRENTLY.


PROPOSED VIDEO DETECTION CAMERAS

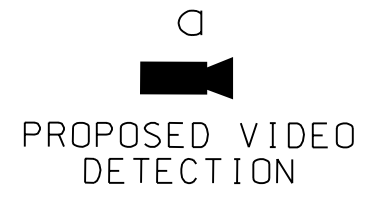


EXISTING VIDEO DETECTION CAMERAS (TO BE REMOVED AND REUSED)



PROPOSED PRESENCE VIDEO DETECTION ZONES

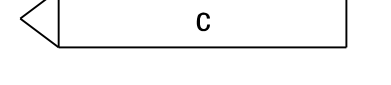

PROPOSED PASSAGE VIDEO DETECTION ZONES

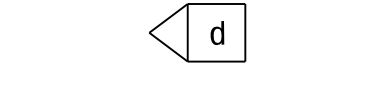


CONSTRUCTION DETAILS

- A. REMOVE STRAIN POLE, FOUNDATION, SPAN WIRE, SIGNAL HEADS, AND ALL ASSOCIATED CABLES, REMOVE FOUNDATION 12 INCHES BELOW GRADE AND BACK FILL.
- B. REMOVE STRAIN POLE, FOUNDATION, SPAN WIRE, SIGNAL HEADS, POST-MOUNTED CABINET, LIGHTING ARM, AND ALL ASSOCIATED CABLES
- C. INSTALL CONCRETE FOUNDATION WITH 15 FT. "T" STEEL POLE WITH 50 FT. MAST ARM WITH PROPOSED SIGNAL HEADS, SIGNS AND OVERHEAD VIDEO DETECTION. (NOTE: INSTALL ONE 4 IN. CONDUIT BEND SCHEDULE 80).
- D. INSTALL CONCRETE FOUNDATION AND 10 FT. BREAKAWAY PEDESTAL POLE WITH LED COUNTDOWN PEDESTRIAN SIGNAL HEAD, APS PUSHBUTTON AND R10-3 SIGN (ORIENT PARALLEL TO CROSSWALK). TOP OF FOUNDATION SHALL BE FLUSH WITH FINAL SIDEWALK GRADE. REFER TO STANDARD MD 801.01-01 FOR FOUNDATION DETAILS. (NOTE: INSTALL 2 IN. CONDUIT BEND IN POLE BASE TO BE SCHEDULE 80).
- E. EXISTING LEASED LUMINAIRE ON PEPCO POLE #791479 6323 TO BE UPGRADED TO 400W HPS EQUIVALENT LED COBRAHEAD WITH A TYPE III DISTRIBUTION.
- F. INSTALL 24 IN. WHITE HEAT APPLIED THERMOPLASTIC PAVEMENT MARKING LINES (STOP LINE).
- G. INSTALL 24 IN. WHITE HEAT APPLIED THERMOPLASTIC PAVEMENT MARKING LINES (CROSSWALK BARS).
- H. INSTALL 5 IN. DOUBLE YELLOW HEAT APPLIED THERMOPLASTIC PAVEMENT MARKING LINES (CENTERLINE).
- J. REMOVE EXISTING PAVEMENT MARKING LINE.
- K. INSTALL 6 IN. WHITE HEAT APPLIED THERMOPLASTIC PAVEMENT MARKING LINE.
- M. INSTALL 6 IN. (3'-9" SKIP) WHITE HEAT APPLIED THERMOPLASTIC PAVEMENT MARKING LINE.
- P. INSTALL ONE-3 INCH RIGID PVC CONDUIT TRENCHED.

- R. INSTALL TWO-4 INCH AND TWO-2 INCH RIGID PVC CONDUIT SCHEDULE 80 TRENCHED.
- S. INSTALL TWO-4 INCH RIGID PVC CONDUIT BORED. (ONE SPARE CONDUIT TO BE TERMINATED AND CAPPED AT FACE OF CURB)
- T. EXISTING HANDHOLE ABANDONED. REMOVE FOUNDATION 12 INCHES BELOW, BACK FILL AND COVER.
- U. EXISTING CONDUIT TO BE CAPPED AND ABANDONED.
- V. INSTALL MDOT SHA STANDARD HANDHOLE.
- W. INSTALL CONCRETE FOUNDATION WITH 15 FT. "T" STEEL POLE WITH 60 FT. MAST ARM WITH PROPOSED SIGNAL HEADS SIGNS AND OVERHEAD VIDEO DETECTION. (NOTE: INSTALL ONE-4 INCH CONDUIT BEND SCHEDULE 80).
- X. INSTALL A NEMA SIZE 5 BASE MOUNTED CONTROLLER AND CABINET WITH 2-WIRE APS CENTRAL CONTROL UNIT AND EMBEDDED METERED SERVICE PEDESTAL. (NOTE: INSTALL THREE-4 INCH PVC. AND TWO-2 INCH PVC CONDUIT BENDS TO BE SCHEDULE 80).
- Y. INSTALL MDOT SHA STANDARD OVERSIZED HANDHOLE.
- Z. INSTALL ONE-2 INCH RIGID PVC CONDUIT TRENCHED.
- AA. INSTALL ONE-4 INCH RIGID PVC CONDUIT SCHEDULE 80 STUBBED UP 6 INCHES ABOVE GRADE AT BASE OF PEPCO POLE.

- GENERAL NOTES**
1. PROPOSED SIGNS 21-25 TO BE INSTALLED ON MAST ARM.
 2. ALL SIGNAL HEADS TO BE INSTALLED WITH BACKPLATES WITH 5"X8" BORDER.
 3. NEAR SIDE SIGNAL 7 TO BE INSTALLED ON PEDESTAL POLE FOR EASTBOUND SANDY SPRING APPROACH. REFER TO STANDARD MD-814.04 FOR MOUNTING DETAILS.
 4. PASSAGE DETECTION ZONES TO BE INSTALLED AT 220' FROM THE STOP BAR ALONG THE MAINLINE (OLNEY SANDY SPRING ROAD).
 5. ASSOCIATED VIDEO DETECTION CAMERAS TO BE INSTALLED ON "T" MAST ARM AT A HEIGHT OF AT LEAST 22' FROM GROUND LEVEL.

60% DELIVERABLE - NOT FOR CONSTRUCTION

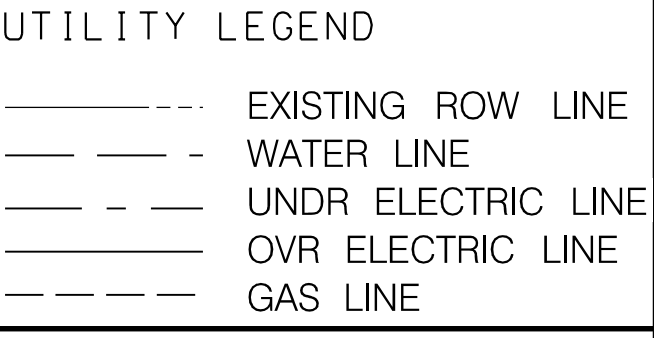

OFFICE OF TRAFFIC & SAFETY
TRAFFIC ENGINEERING DESIGN DIVISION

MARYLAND DEPARTMENT OF TRANSPORTATION
STATE HIGHWAY ADMINISTRATION

SANDY SPRING BIKEWAY FACILITY PLANNING
MD 108 (OLNEY SANDY SPRING ROAD)
AT NORWOOD ROAD TRAFFIC SIGNAL

SIGNALIZATION PLAN SHEET

SCALE 1"=20' ADVERTISED DATE 4/93 CONTRACT NO. <CONTRACT NO.>

DESIGNED BY J.F.L. (FOR DCI) COUNTY MONTGOMERY
DRAWN BY B.KENT (FOR DCI) LOGMILE <LOGMILE.>
CHECKED BY DOR TMS NO. <TMS NO.>
MDE/PRD <00-AA-0000> TOD NO. <TOD NO.>

TS NO.:TS NO> DRAWING SG-01 OF XX SHEET NO. 20 OF 20



I HEREBY CERTIFY THAT THESE DOCUMENTS WERE PREPARED OR APPROVED BY ME, AND THAT I AM A DULY LICENSED PROFESSIONAL ENGINEER UNDER THE LAWS OF THE STATE OF MARYLAND.

MD LICENSE NUMBER _____
EXPIRATION DATE _____