




SITE: SATELLITE VIEW

CHABERTON SOLAR RAMIERE LLC

CHABERTON SOLAR RAMIERE

3,898.56 kWdc / 3,000.00 kWac SOLAR GROUND MOUNT AT
17600 WHITES FERRY RD., POOLESVILLE, MD 20837
40.8247°, -80.4012°

10% DESIGN SET

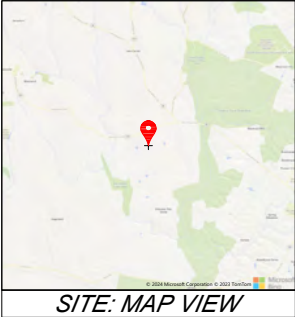

SITE: MAP VIEW

SHEET INDEX		
SHEET NUMBER	SHEET TITLE	REVISION
G-001	COVER SHEET & INDEX	C
G-010	GENERAL SYMBOLS & NOTES	B
E-001	ELECTRICAL SITE PLAN	C
E-100	ELECTRICAL SINGLE LINE DIAGRAM	C
E-200	EQUIPMENT PAD DETAILS	B
E-600	EQUIPMENT DATASHEETS	B
M-001	RACKING DETAILS	B
M-101	PLANAR STUDY	B
M-102	SLOPE ANALYSIS	-
1	PRELIMINARY/FINAL FOREST CONSERVATION PLAN	0
2	PRELIMINARY/FINAL FOREST CONSERVATION PLAN	0
1	COVER SHEET CONCEPT SITE DEVELOPMENT PLAN	0
2	EXISTING SITE CONDITIONS PLAN	0
3	PROPOSED SITE CONDITIONS PLAN	0
4	PROPOSED SITE CONDITIONS PLAN	0
5	PROPOSED SITE DETAILS	0
6	PROPOSED SITE DETAILS	0
7	PRE-DEVELOPMENT DRAINAGE AREA MAP	0
8	POST DEVELOPMENT DRAINAGE AREA MAP	0
1	COVER SHEET FIRE DEPARTMENT ACCESS PLAN	A
2	PROPOSED SITE CONDITIONS (OVERALL)	A
3	PROPOSED SITE CONDITIONS	A
4	PROPOSED SITE DETAILS (1 OF 2)	A
5	PROPOSED SITE DETAILS (2 OF 2)	A

SYSTEM SUMMARY	
DC SYSTEM SIZE	3,898.56 kWdc
AC SYSTEM SIZE	3,000.00 kWac
DC/AC RATIO	1.300
MODULES	Q.TRON XL-G2 G20 (820Wp)
MODULE QUANTITY	6,088
INVERTERS	CHINT CPS SCH12SKTL-D01US-600 (125kW, 600V)
INVERTER QUANTITY	24
AZIMUTH/TILT	180°/20°
PITCH	23.19 FT
INTERROW SPACE	8.00 FT

NOT FOR
CONSTRUCTION


10% DESIGN SET 01/23/2024

DRAWING TITLE
**COVER SHEET &
INDEX**
REVISION
C
DRAWING NO.
G-001

PROJECT CHABERTON SOLAR RAMIERE 3.90 MWdc / 3.00 MWac GROUND MOUNT AT 17600 WHITES FERRY RD., POOLESVILLE, MD 20837 40.8247°, -80.4012°	DEVELOPER CHABERTON ENERGY 1700 Rockville Pike, Suite 305 Rockville, MD 20852 	C	CIVIL UPDATE	01/31/2025	APPROVED BY: JSG
		B	SWM UPDATE	12/23/2024	CHECKED BY:
		A	SWM & MODULE UPDATE	08/09/2024	EJA
		REV.	DESCRIPTION	DATE	DESIGNED BY: MDB

SYSTEM SUMMARY	
DC SYSTEM SIZE	3,898.56 kWdc
AC SYSTEM SIZE	3,000.00 kWac
DC/AC RATIO	1.300
MODULES	Q.TRON XL-42.620 (620Wp)
MODULE QUANTITY	6,208
INVERTERS	CHINT CPS SCH125KTL-DOIS-600 (125kW, 600V)
INVERTER QUANTITY	24
AC220V/HTL	160° / 20°
PITCH	23.19°
INTERROW SPACE	5.00 FT

<div>PROJECT</div> <div>CHABERTON SOLAR RAMIERE 3.90 MWdc / 3.00 MWac GROUND MOUNT AT 17600 WHITES FERRY RD., POOLESVILLE, MD 20837 40.8247°, -80.4012°</div>	<div>DEVELOPER</div> <div>CHABERTON ENERGY 1700 Rockville Pike, Suite 305 Rockville, MD 20852</div> <div></div>	-	-	-	APPROVED BY: JSG	<div>DRAWING TITLE</div> <div>GENERAL SYMBOLS & NOTES</div>
		B	SWM UPDATE	12/23/2024	CHECKED BY:	
		A	SWM & MODULE UPDATE	08/09/2024	EJA	
		REV.	DESCRIPTION	DATE	DESIGNED BY: MDB	

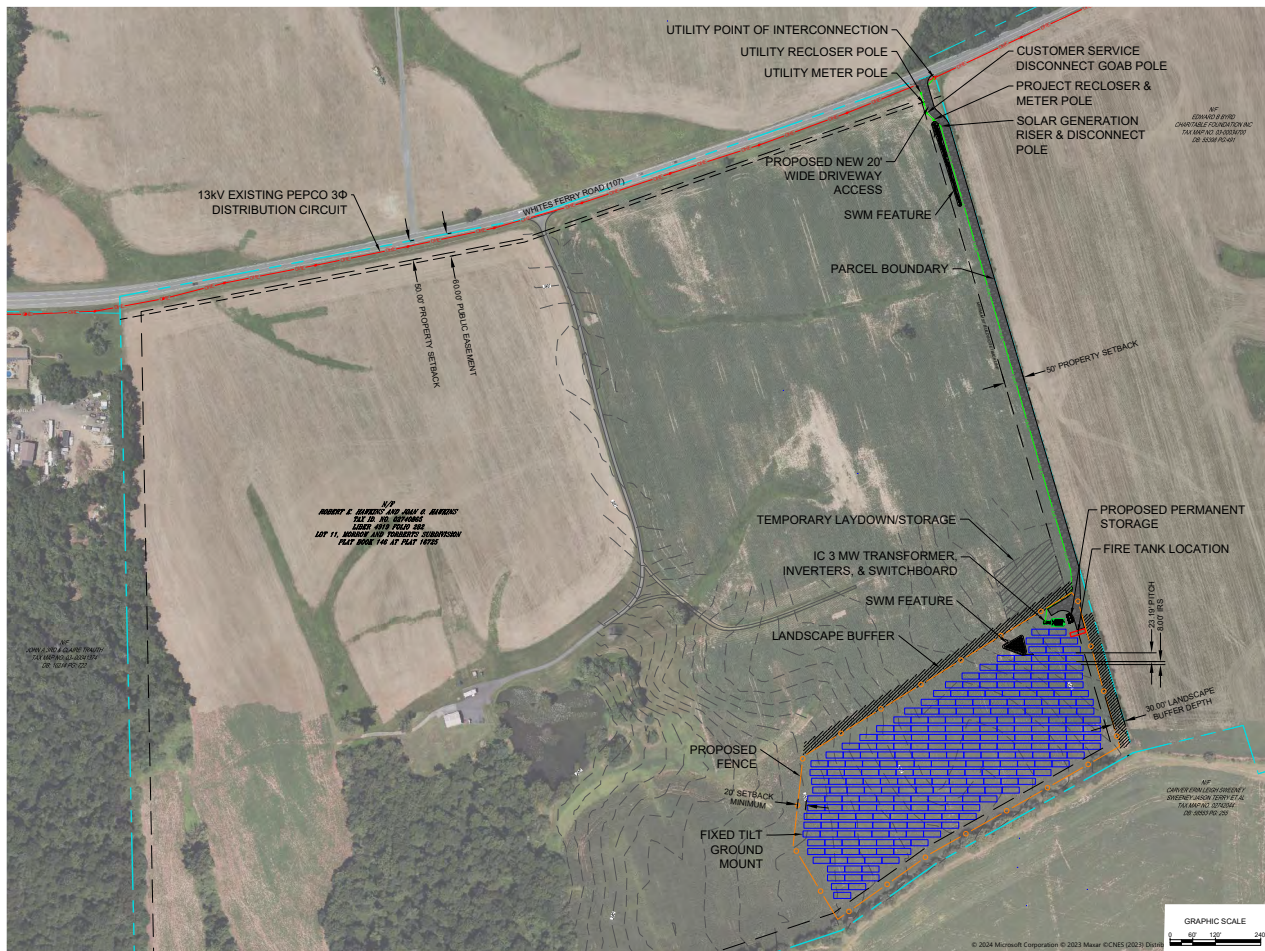

SYSTEM SUMMARY	
DC SYSTEM SIZE	3,868.56 kWdc
AC SYSTEM SIZE	3,000.00 MWac
DC/AC RATIO	1.300
MODULES	Q.TRON XL-G2 (620Wp)
MODULE QUANTITY	9,788
INVERTERS	CHINTY CPS SCH125KTL-DOUS-600 (125kW, 600V)
INVERTER QUANTITY	24
AZIMUTH/TILT	180° / 20°
PITCH	23.15 FT
INTERROW SPACE	8.00 FT

LAYER LEGEND	
PROP. UNDERGROUND ELECTRIC	---
PROP. OVERHEAD ELECTRIC	---
EX. UNDERGROUND ELECTRIC	---
EX. OVERHEAD ELECTRIC	---
PROP. FENCE	---
PROPERTY LINE	---
SOLAR PV MODULES	
ROAD	
CONCRETE	
LAYDOWN AREA	
LANDSCAPE BUFFER	
WETLANDS	
FLOODPLAINS	
WATER	

- NOTES:**
- DRAWING FOR INTERCONNECTION APPROVAL AND EPC BID ONLY. NOT FOR CONSTRUCTION.
 - ALL EQUIPMENT SHALL BE UL LISTED FOR USE IN SYSTEM CONFIGURATION.
 - INSTALLATION SHALL COMPLY WITH THE LATEST STATE ADOPTED NEC.
 - EQUIPMENT LOCATIONS FOR PRELIMINARY DESIGN ONLY. EQUIPMENT LOCATION MAY BE SUBSTITUTED BY THE EPC AS APPROVED BY CEH.
 - SEE CIVIL ENGINEERING DRAWINGS FOR CIVIL SITE DETAILS.
 - PROPOSED INTERCONNECTION PATH AND POINT MAY BE SUBSTITUTED BY THE EPC AS APPROVED BY CEH.
 - MODULE AND FENCE LAYOUT ON E-001 SUPERSEDES THOSE SHOWN ON CIVIL DRAWINGS.
 - CONTRACTOR TO LOCATE TRANSFORMER PAD ON CREST OF HILL AND TO ENSURE PROPER DRAINAGE AWAY FROM PAD.

PROJECT

CHABERTON SOLAR RAMIERE
3.90 MWdc / 3.00 MWac GROUND MOUNT AT
17600 WHITES FERRY RD., POOLESVILLE, MD 20837
40.8247°, -80.4012°

DEVELOPER

CHABERTON ENERGY
1700 Rockville Pike, Suite 305
Rockville, MD 20852

C	CIVIL UPDATE	01/31/2025
B	SWM UPDATE	12/23/2024
A	SWM & MODULE UPDATE	08/09/2024
REV.	DESCRIPTION	DATE

APPROVED BY:	JSG
CHECKED BY:	EJA
DESIGNED BY:	MDB

DRAWING TITLE	10% DESIGN SET	01/23/2024
ELECTRICAL SITE PLAN	REVISION	DRAWING NO.
C		E-001

ELECTRICAL NOTES:


- DRAWINGS FOR INTERCONNECTION APPROVAL ONLY - NOT FOR CONSTRUCTION.
- ALL EQUIPMENT SHALL BE UL LISTED FOR USE IN SYSTEM CONFIGURATION.
- INSTALLATION SHALL COMPLY WITH LATEST ADOPTED NEC.
- RELAY PROTECTION SETTINGS PROVIDED ARE PRELIMINARY AND SUBJECT TO COORDINATION WITH LOCAL UTILITY.
- MAXIMUM FACILITY OUTPUT (MFO) IS 3.90 MWac. GRID CONTROLLER AND PROTECTION SETTINGS SHALL NOT ALLOW MORE THAN MFO RATING. GRID CONTROLLER SHALL ALSO LIMIT POWER THROUGH EACH TRANSFORMER TO MAXIMUM RATING OF TRANSFORMER.
- UPDATED INVERTER AT DERATED AC OUTPUT OR EQUIVALENT INVERTER SHALL BE PROVIDED IN FINAL DESIGN. DESIGN AC OUTPUT NOT TO EXCEED TRANSFORMER CAPACITY OR COMMUNITY SOLAR PROGRAM LIMITS.
- SYSTEM SHALL BE CONFIGURED TO SHUTDOWN VIA ALL OF THE FOLLOWING MEANS:
 - RECEPTION OF A REMOTE SIGNAL
 - UPON LOSS OF UTILITY POWER
 - LOCAL EMERGENCY POWER-OFF (EPO) INITIATING
 - DEVICE OPERATION OF DISCONNECTING MEANS

INVERTER TRIP SETTINGS

FUNCTION	SETTING VOLTAGE (P.U. OF NOMINAL VOLTAGE) / FREQUENCY (Hz)	CLEARING TIME (s)
UNDERVOLTAGE UV1	0.88	2
UNDERVOLTAGE UV2	0.5	1.1
OVERVOLTAGE OV1	1.1	2
OVERVOLTAGE OV2	1.2	0.16
UNDERFREQUENCY UF1	58.5	300
UNDERFREQUENCY UF2	58.5	0.16
OVERFREQUENCY OF1	61.2	300
OVERFREQUENCY OF2	62	0.16
OVERCURRENT SETTINGS TO BE DETERMINED		

SYSTEM SUMMARY

DC SYSTEM SIZE	3,866.56 kWac
AC SYSTEM SIZE	3,000.00 kWac
DC/AC RATIO	1.300
MODULES	Q TRON XL-G2 620 (620Wp)
MODULE QUANTITY	9,788
INVERTERS	CHINT CPS SCH125KTL-D00US-600 (125kW, 600V)
INVERTER QUANTITY	24
INVERTER TYPE	180° / 720°
PITCH	23.19 FT
INTERROW SPACE	8.00 FT

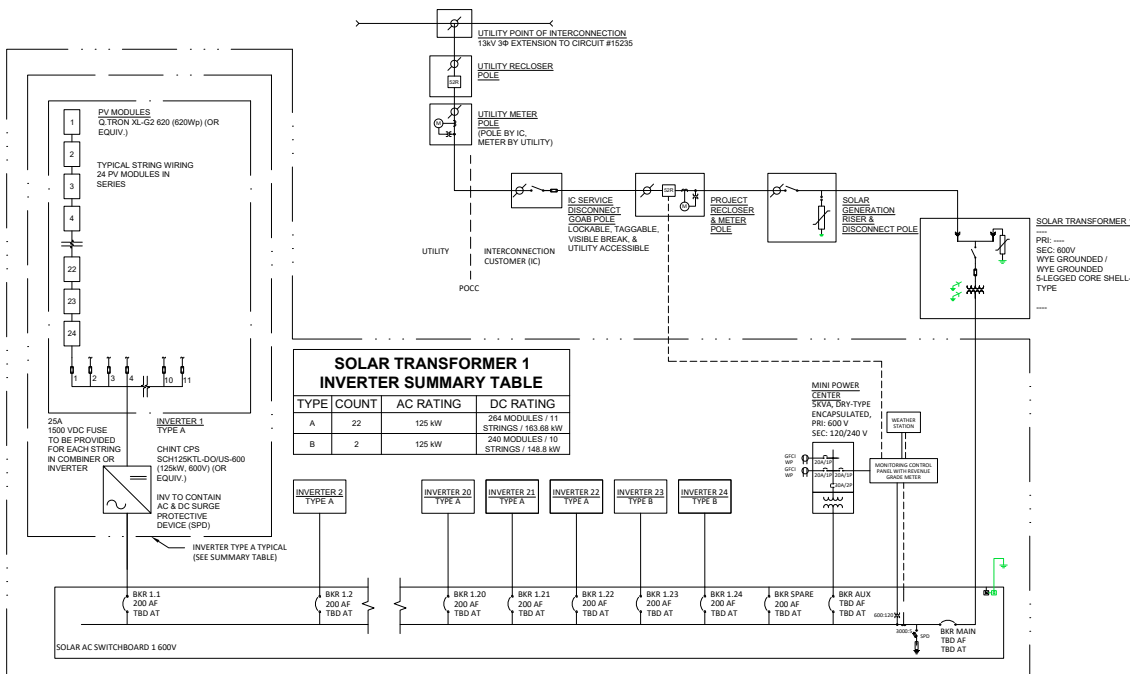

SOLAR TRANSFORMER 1 INVERTER SUMMARY TABLE			
TYPE	COUNT	AC RATING	DC RATING
A	22	125 kW	264 MODULES / 11 STRINGS / 163.68 kW
B	2	125 kW	240 MODULES / 10 STRINGS / 148.8 kW

NOT FOR
CONSTRUCTION

10% DESIGN SET 01/23/2024

DRAWING TITLE
**ELECTRICAL SINGLE
LINE DIAGRAM**

REVISION
C

DRAWING NO.
E-100

PROJECT
CHABERTON SOLAR RAMIERE
3.90 MWdc / 3.00 MWac GROUND MOUNT AT
17600 WHITES FERRY RD., POOLESVILLE, MD 20837
40.8247°, -80.4012°

DEVELOPER
CHABERTON ENERGY
1700 Rockville Pike, Suite 305
Rockville, MD 20852




C	SWM UPDATE	12/23/2024
B	SWM & MODULE UPDATE	08/09/2024
A	UTILITY COMMENTS APPLIED	06/27/2024
REV.	DESCRIPTION	DATE

APPROVED BY:	JSG
CHECKED BY:	EJA
DESIGNED BY:	MDB

SYSTEM SUMMARY	
DC SYSTEM SIZE	3,868.56 kWdc
AC SYSTEM SIZE	3,000.00 kWac
DC/AC RATIO	1.29
MODULES	Q.TRON XL-G2 600 (600Wp)
MODULE QUANTITY	6,288
INVERTERS	CHINT CPS SCHT25K1-C00US-600 (125kW, 600V)
INVERTER QUANTITY	24
AZIMUTH/TILT	180° / 20°
PITCH	23.19 FT
INTERROW SPACE	8.00 FT

- GENERAL NOTES:
- DRAWING FOR INTERCONNECTION APPROVAL AND EPC BID ONLY - NOT FOR CONSTRUCTION.
 - INSTALLATION SHALL COMPLY WITH THE LATEST STATE ADOPTED NEC.
 - PV EQUIPMENT SHOWN FOR PRELIMINARY DESIGN ONLY. EQUIPMENT MAY BE SUBSTITUTED BY THE EPC AS APPROVED BY CEH.
 - PV EQUIPMENT PAD LAYOUT TYPICAL ONLY. EPC MAY SUBMIT PREFERRED LAYOUT FOR CEH APPROVAL.
 - EQUIPMENT TO MEET ALL UTILITY INTERCONNECTION REQUIREMENTS.
 - EQUIPMENT MUST MEET ALL WORKING CLEARANCE REQUIREMENTS PER NEC 110.26 AND EQUIPMENT INSTALLATION MANUALS.

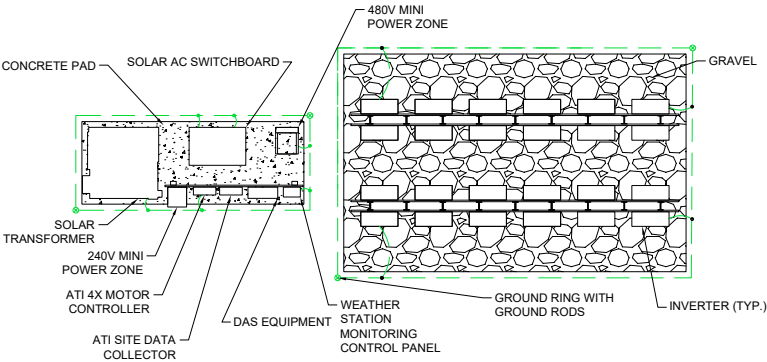

NOT FOR
CONSTRUCTION

10% DESIGN SET 01/23/2024

DRAWING TITLE
EQUIPMENT PAD
DETAILS

REVISION
B

DRAWING NO.
E-200

PROJECT
CHABERTON SOLAR RAMIERE
3.90 MWdc / 3.00 MWac GROUND MOUNT AT
17600 WHITES FERRY RD., POOLESVILLE, MD 20837
40.8247°, -80.4012°

DEVELOPER
CHABERTON ENERGY
1700 Rockville Pike, Suite 305
Rockville, MD 20852



-	-	-
B	SWM UPDATE	12/23/2024
A	SWM & MODULE UPDATE	08/08/2024
REV.	DESCRIPTION	DATE

APPROVED BY:	JSG
CHECKED BY:	EJA
DESIGNED BY:	MDB

PV INVERTER DATA SHEET

PV MODULE DATA SHEET


PV FIXED TILT DATA SHEET

SYSTEM SUMMARY	
DC SYSTEM SIZE	3,898.56 kWdc
AC SYSTEM SIZE	3,000.00 kWac
DC/AC RATIO	1.300
MODULES	Q.TRON XL-G2 620 (620Wp)
MODULE QUANTITY	6,288
INVERTERS	CHINT CPS SCH212KTC000U-60 (125kW, 600V)
INVERTER QUANTITY	24
AZIMUTH/LT	180° / 20°
PITCH	23.19 FT
INTERROW SPACE	8.00 FT


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NOT FOR CONSTRUCTION	
10% DESIGN SET	01/23/2024
DRAWING TITLE	
EQUIPMENT DATASHEETS	
REVISION	DRAWING NO.
B	E-500

PROJECT CHABERTON SOLAR RAMIERE 3.90 MWdc / 3.00 MWac GROUND MOUNT AT 17600 WHITES FERRY RD., POOLESVILLE, MD 20837 40.8247°, -80.4012°	DEVELOPER CHABERTON ENERGY 1700 Rockville Pike, Suite 305 Rockville, MD 20852 	-	-	-	APPROVED BY: JSG	DRAWING TITLE EQUIPMENT DATASHEETS	
		B	SWM UPDATE	12/23/2024	CHECKED BY: EJA		
		A	SWM & MODULE UPDATE	08/09/2024	DESIGNED BY: MDB	REVISION B	DRAWING NO. E-500
		REV.	DESCRIPTION	DATE			

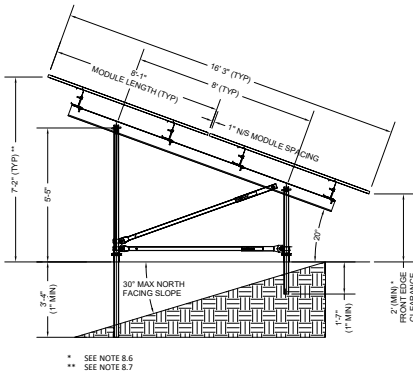

TYP. SIDE VIEW AT 20° TILT
NOT TO SCALE

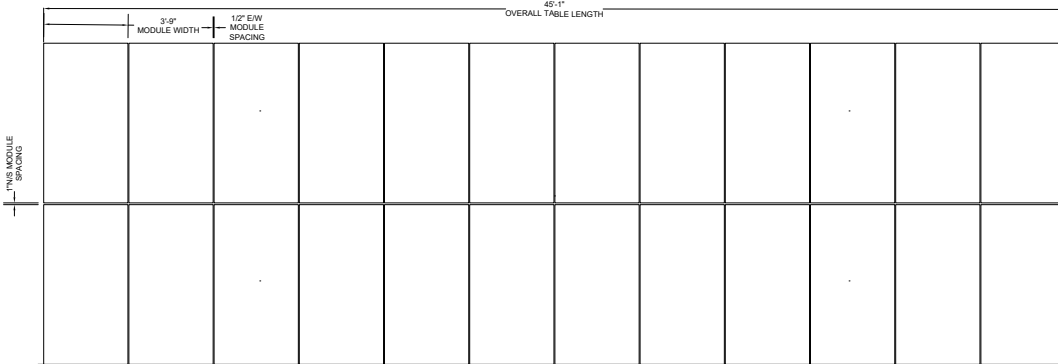

SYSTEM SUMMARY

DC SYSTEM SIZE	3,888.56 kWdc
AC SYSTEM SIZE	3,000.00 kWac
DC/AC RATIO	1.300
MODULES	Q TRON XL-G2 600 (600Wp)
MODULE QUANTITY	6,288
INVERTERS	CHINTY CPS SCHT25K1-C00US-600 (125kW, 600V)
INVERTER QUANTITY	24
AZIMUTH/TILT	180° / 20°
PITCH	23.19 FT
INTERROW SPACE	8.00 FT

FIXED TILT RACKING NOTES:

- DRAWING IS DIAGRAMMATIC AS SHOWN AND INTENDED TO COMMUNICATE INTENT.
- PILE SURVEYING SHALL BE PERFORMED BY A LICENSED SURVEYOR USING THE APPLICABLE STATE PLANE COORDINATE SYSTEM.
- EPC TO DETERMINE PILE EMBEDMENT AND FOUNDATIONS PER STRUCTURAL CALCULATIONS FOR EACH SUPPORT POST HEIGHT AND BASE.
- FOUNDATION AND RACKING SHALL BE INSTALLED PER MANUFACTURER'S INSTALLATION MANUAL AND WITHIN STATED TOLERANCES.
- ALL GRADING AND DRAINAGE SHALL BE PER CIVIL CONSTRUCTION DRAWINGS.
- EPC TO DETERMINE RACKING SPACING.
- ALL STRUCTURAL AND MECHANICAL DESIGNS TO BE PERFORMED BY A QUALIFIED LICENSED PROFESSIONAL ENGINEER.
- DESIGN CRITERIA:
 - 100 MPH WIND SPEED, ASCE 7-10, CAT 1 OR COUNTY MINIMUM REQUIREMENTS, WHICHEVER IS HIGHER.
 - 25 PSF GROUND SNOW EXPOSURE OR COUNTY MINIMUM REQUIREMENTS, WHICHEVER IS HIGHER.
 - ANCHORING IS PILE DRIVEN UNLESS OTHERWISE REQUIRED BY SITE CONDITIONS.
 - PANELS AZIMUTH TO BE 180°.
 - FINAL DESIGN MAY BE ADJUSTED PRIOR TO CONSTRUCTION. MAXIMUM HEIGHT NOT TO BE INCREASED WITHOUT APPROVAL FROM THE ENGINEER AND AHI.
 - <5% OF LEADING EDGES TO BE WITHIN 2'-0" OF GROUND FOR PURPOSES OF POLLINATOR GROWTH.
 - <5% OF LONGITUDINAL CENTER OF TABLE TO BE #4 ABOVE GROUND ELEVATION.
 - RACKING TO BE DOUBLE PORTRAIT ORIENTATION.
 - MAXIMUM RACKING TOLERANCE ASSUMED AT 15%.

NOT FOR
CONSTRUCTION

10% DESIGN SET 01/23/2024

DRAWING TITLE

RACKING DETAILS

REVISION B DRAWING NO. M-001

PROJECT	CHABERTON SOLAR RAMIERE 3.90 MWdc / 3.00 MWac --- AT 17600 WHITES FERRY RD., POOLESVILLE, MD 20837 40.8247°, -80.4012°	DEVELOPER	CHABERTON ENERGY 1700 Rockville Pike, Suite 305 Rockville, MD 20852	APPROVED BY:	JSG	CHECKED BY:	EJA	DESIGNED BY:	MDB
REV.	B	A	DESCRIPTION	DATE	DATE	DATE	DATE	DATE	DATE



SYSTEM SUMMARY	
DC SYSTEM SIZE	3,898.56 kWdc
AC SYSTEM SIZE	3,000.00 kWac
DC/AC RATIO	1.300
MODULES	Q.TRON XL-G2 620 (820Wp)
MODULE QUANTITY	6,288
INVERTERS	CHINT CPS SCHT25K1C-DUOUS-600 (125kW, 600V)
INVERTER QUANTITY	24
AZIMUTH/TILT	180° / 20°
PITCH	23.19 FT
INTERROW SPACE	8.00 FT

LAYER LEGEND	
PROP. UNDERGROUND ELECTRIC	---
PROP. OVERHEAD ELECTRIC	---
EX. UNDERGROUND ELECTRIC	---
EX. OVERHEAD ELECTRIC	---
PROP. FENCE	---
PROPERTY LINE	---
SOLAR PV MODULES	
ROAD	
CONCRETE	
LAYDOWN AREA	
LANDSCAPE BUFFER	
WETLANDS	
FLOODPLAINS	
WATER	

ELEVATION TABLE			
COLOR	MIN HEIGHT	MAX HEIGHT	PERCENT AREA
	5.006	5.500	16.994
	5.500	6.000	155.488
	6.000	6.500	4.516
	6.500	6.709	203

NOTE: NO EARTHWORK IS PROPOSED UNDERNEATH THE SOLAR ARRAY. ANY EARTHWORK OR GRADING FOR THE ACCESS ROAD OR AUXILIARY FEATURES ARE TO BE BALANCED TO ENSURE EARTHWORK IS NOT IN DEFICIENT OR SURPLUS.

	NOT FOR CONSTRUCTION	
	10% DESIGN SET	01/23/2024
	PLANAR STUDY	
APPROVED BY: JSG	DESIGNED BY: EJA	REVISION B
DESIGNED BY: MDB	DRAWING NO. M-101	

PROJECT
CHABERTON SOLAR RAMIERE 3.90 MWdc / 3.00 MWac GROUND MOUNT AT 17600 WHITES FERRY RD., POOLESVILLE, MD 20837 40.8247°, -80.4012°

DEVELOPER
CHABERTON ENERGY 1700 Rockville Pike, Suite 305 Rockville, MD 20852

REV.	DESCRIPTION	DATE
-	-	-
B	SWM UPDATE	12/23/2024
A	SWM & MODULE UPDATE	08/09/2024



SYSTEM SUMMARY	
DC SYSTEM SIZE	3,898.56 kWdc
AC SYSTEM SIZE	3,000.00 kWac
DC/AC RATIO	1.300
MODULES	Q.TRON XL-G2 620 (820Wp)
MODULE QUANTITY	6,288
INVERTERS	CHINT CPS SCHT25K1C-DV0US-600 (125kW, 600V)
INVERTER QUANTITY	24
AZIMUTH/TILT	180° / 20°
PITCH	23.19 FT
INTERROW SPACE	8.00 FT

LAYER LEGEND	
PROP. UNDERGROUND ELECTRIC	---
PROP. OVERHEAD ELECTRIC	---
EX. UNDERGROUND ELECTRIC	---
EX. OVERHEAD ELECTRIC	---
PROP. FENCE	---
PROPERTY LINE	---
SOLAR PV MODULES	
ROAD	
CONCRETE	
LAYDOWN AREA	
LANDSCAPE BUFFER	
WETLANDS	
FLOODPLAINS	
WATER	

SLOPES TABLE		
Color	Minimum Slope	Maximum Slope
Green	0.00%	0.50%
Light Green	0.50%	1.00%
Yellow-Green	1.00%	2.00%
Yellow	2.00%	3.00%
Orange-Yellow	3.00%	5.00%
Orange	5.00%	7.50%
Red-Orange	7.50%	10.00%

	NOT FOR CONSTRUCTION	
	10% DESIGN SET	01/23/2024
	DRAWING TITLE	
	SLOPE ANALYSIS	
APPROVED BY: JSG	DESIGNED BY: EJA	REVISION: ----
CHECKED BY: JSG	DESIGNED BY: MDB	DRAWING NO. M-102

PROJECT
CHABERTON SOLAR RAMIERE 3.90 MWdc / 3.00 MWac GROUND MOUNT AT 17600 WHITES FERRY RD., POOLESVILLE, MD 20837 40.8247°, -80.4012°

DEVELOPER
CHABERTON ENERGY 1700 Rockville Pike, Suite 305 Rockville, MD 20852


REV.	DESCRIPTION	DATE
-	-	-
-	-	-
-	-	-



DRAWINGS FOR CONCEPT SITE DEVELOPMENT PLAN

RAMIERE 3.0 MW AC SOLAR PROJECT

POOLESVILLE, MONTGOMERY COUNTY, MARYLAND

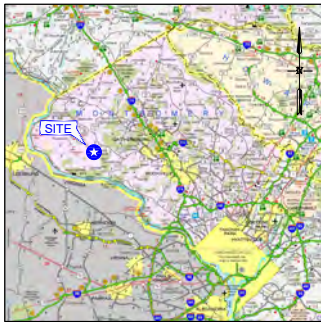

VICINITY MAP
SCALE: 1" = 0.5 Miles

PREPARED FOR DEVELOPER:
CHABERTON SOLAR RAMIERE LLC
1700 ROCKVILLE PIKE, SUITE 305
ROCKVILLE, MD 20852
(804) 929-8418

PROPERTY OWNER:
ROBERT HAWKINS
9919 WATKINS ROAD
GAITHERSBURG, MD 20882
(301) 651-7146

SITE ADDRESS:
17600 WHITES FERRY ROAD, POOLESVILLE, MD 20837 (39.1215°N, -77.3556°W)

- PROJECT SITE:
- EXISTING ZONING: AGRICULTURAL RESERVE (AR) ZONE
 - EXISTING USE: AGRICULTURAL
 - PROPOSED USE: COMMUNITY SOLAR ENERGY GENERATING SYSTEM (CEGSS)
 - TOTAL SITE AREA: 117.38 AC
 - TOTAL PROPOSED DEVELOPMENT AREA (LIMIT OF DISTURBANCE) 441,728 SF (10.2 AC)
 - TAX ID: NO. 0274086, LIBER 4919, FOLIO 382, LOT 11 IN THE MORROW AND TORBERTS SUBDIVISION, RECORDED IN PLAT BOOK 186 AT PLAT 18725
 - SYSTEM SIZE: 3.35 MW DC / 3.00 MW AC

NOTES:
CALL "MISS UTILITY" AT 1-800-257-7777, 48 HOURS PRIOR TO THE START OF WORK. THE EXCAVATOR MUST NOTIFY ALL PUBLIC UTILITY COMPANIES WITH UNDERGROUND FACILITIES IN THE AREA OF PROPOSED EXCAVATION AND HAVE THOSE FACILITIES LOCATED BY THE UTILITY COMPANIES PRIOR TO COMMENCING EXCAVATION. THE EXCAVATOR IS RESPONSIBLE FOR COMPLIANCE WITH REQUIREMENTS OF CHAPTER 58A OF THE MONTGOMERY COUNTY CODE.

DECEMBER 2024

LIST OF SHEETS

SHEET NO.	DESCRIPTION	EPLANS SHEET NAME
1	COVER SHEET	SMSC001
2	EXISTING SITE CONDITIONS PLAN	SMSC002
3	PROPOSED SITE CONDITIONS PLAN (OVERALL)	SMSC003
4	PROPOSED SITE CONDITIONS PLAN	SMSC004
5	PROPOSED SITE DETAILS	SMSC005
6	PROPOSED SITE DETAILS	SMSC006
7	PRE-DEVELOPMENT DRAINAGE AREA MAP	SMSC007
8	POST DEVELOPMENT DRAINAGE AREA MAP	SMSC008

SWM Concept Summary Table:

Contact Information for Design Engineer (for technical issues): [Charles Walker](#)
ARM Group LLC, 9115 Outlets Road Suite 310 Columbia, MD 21046
Phone: 410-242-2213

General Property Information

ENR: 201745

Type of Concept: SWM Concept

MHC/MPIC Process/No: Mandatory Referral

Property Address: 17600 Whites Ferry Road Poolesville, MD 20837

Property Legal Description: Tract 18333

Property Size (Acres): 8.2 / 117.38 and 5,090,000 sq. ft.

Total Concept Area (Acres): 8.2 / 117.38 and 5,090,000 sq. ft.

Zoning: AR (Agricultural Reserve)

Watershed and Stream Class: Seneca Creek Watershed Class C-P

Special Protection Area: N/A

100 YR Floodplain: NONE (PER FEMA 24031003050)

Is % Impervious / Redevelopment or New Development: % Impervious / New Development

SWM Summary

Target PEP/Proposed PE: 1.07 / 1.12

Target ESD/Proposed ESD: 4.807 / 4.838 of

ESD Measures: Non-storing Detention, Micro-ponds


Structural Storage Required/Provided: N/A

Structural Measures: N/A

Water Required/ESD Credits: No

Provided ESDs + Structural Storage Provided + Requested to be Waived = 4.807 of

Other Information:

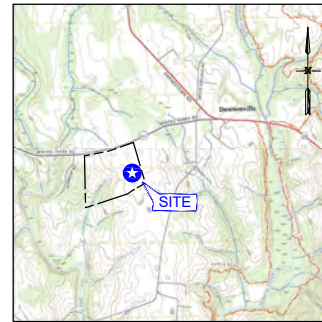

LOCATION MAP
SCALE: 1" = 200'

PREPARED BY:




ARM Group LLC
Engineers and Scientists
[www.armgroup.net](#)

HEADQUARTERS:

1129 West Governor Road • Hershey, PA 17033-0797
Ph: (717) 533-8600 Fax: (717) 533-8605

THIS DRAWING SET WAS ORIGINALLY PRODUCED IN COLOR. NON-COLOR REPRODUCTIONS DO NOT NECESSARILY REPRESENTATIVE AND/OR FEATURES DETECTED BY THIS DRAWING SET. THIS DRAWING, ITS CONTENTS, AND EACH COMPONENT OF THIS DRAWING ARE THE PROPERTY OF ARM GROUP LLC AND SHALL NOT BE REPRODUCED OR USED IN ANY MANNER EXCEPT FOR THE PURPOSE IDENTIFIED ON THE TITLE BLOCK, AND ONLY BY OR ON BEHALF OF THIS CLIENT FOR THE IDENTIFIED PROJECT UNLESS OTHERWISE AUTHORIZED BY THE EXPRESS, WRITTEN CONSENT OF ARM GROUP INC.



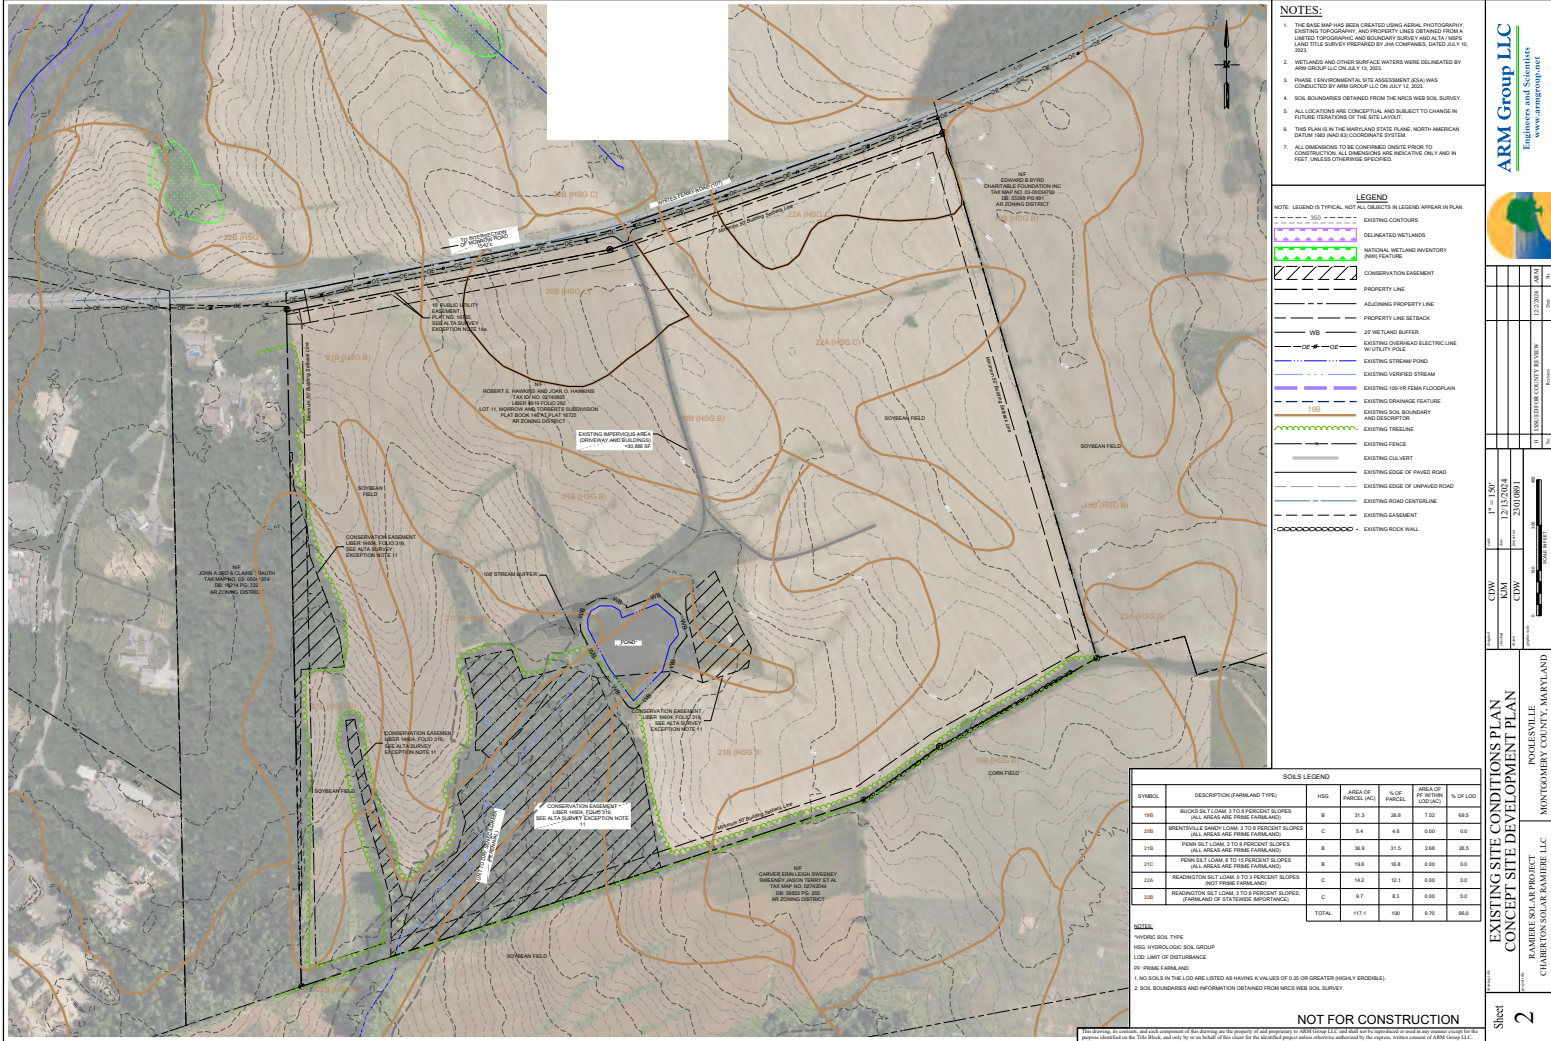

- NOTES:**
1. THE BASE MAP HAS BEEN CREATED USING AERIAL PHOTOGRAPHY, EXISTING TOPOGRAPHY, AND PROPERTY LINES DERIVED FROM A LIMITED TOPOGRAPHIC AND BOUNDARY SURVEY AND ALTA SURVEY. THIS SURVEY WAS PREPARED BY ARM GROUP, DATED JULY 13, 2023.
 2. WETLANDS AND OTHER SURFACE WATERS WERE DELINEATED BY ARM GROUP LLC ON JULY 13, 2023.
 3. FUTURE ENVIRONMENTAL SITE ASSESSMENT (ESA) WILL BE CONDUCTED BY ARM GROUP LLC ON JULY 13, 2023.
 4. SOIL BOUNDARIES OBTAINED FROM THE NRCS WEB SOIL SURVEY. ALL LOCATIONS ARE CONCEPTUAL AND SUBJECT TO CHANGE IN FUTURE ITERATIONS OF THE SITE LAYOUT.
 5. THIS PLAN IS IN THE NAD83 STATE PLANE, NORTH AMERICAN DATUM 1983 (NAD 83) COORDINATE SYSTEM.
 6. ALL DIMENSIONS TO BE CONFIRMED PRIOR TO CONSTRUCTION. ALL DIMENSIONS ARE INDICATIVE ONLY AND IN FEET. (UNLESS OTHERWISE SPECIFIED).

LEGEND

NOTE: LEGEND IS TYPICAL, NOT ALL SUBJECTS IN LEGEND APPEAR IN PLAN

---	EXISTING CONTOURS
---	DELINEATED WETLANDS
---	NATURAL WETLAND INVENTORY (NWI) FACTOR
---	CONSERVATION EASEMENT
---	PROPERTY LINE
---	ADJOINING PROPERTY LINE
---	PROPERTY LINE SETBACK
---	20' WETLAND BUFFER
---	EXISTING OVERHEAD ELECTRIC LINE
---	EXISTING UTILITY POLE
---	EXISTING VERIFIED STREAM
---	EXISTING 100-YR FLOODPLAIN
---	EXISTING DRAINAGE FEATURES
---	EXISTING SOIL BOUNDARY
---	EXISTING FENCE
---	EXISTING CULVERT
---	EXISTING EDGE OF PAVED ROAD
---	EXISTING EDGE OF UNPAVED ROAD
---	EXISTING ROAD CENTERLINE
---	EXISTING EASEMENT
---	EXISTING ROAD WALL

SOILS LEGEND

SYMBOL	DESCRIPTION (FARMLAND TYPE)	SSS	AREA OF PAVEMENT	% OF PAVEMENT	AREA OF TOTAL LOT	% OF TOTAL LOT
100	BROWN SILT LOAM, 3 TO 8 PERCENT SLOPES (ALL MEASUREMENTS FROM FLOODPLAIN)	B	35.3	26.8	7.00	99.5
101	BROWN SILT LOAM, 3 TO 8 PERCENT SLOPES (ALL MEASUREMENTS FROM FLOODPLAIN)	C	5.4	4.2	0.00	0.0
102	PINK SILT LOAM, 3 TO 8 PERCENT SLOPES (ALL MEASUREMENTS FROM FLOODPLAIN)	B	26.9	21.2	2.00	26.5
103	PINK SILT LOAM, 3 TO 8 PERCENT SLOPES (ALL MEASUREMENTS FROM FLOODPLAIN)	B	0.6	0.5	0.00	0.0
104	RED BROWN SILT LOAM, 3 TO 8 PERCENT SLOPES (ALL MEASUREMENTS FROM FLOODPLAIN)	C	14.2	11.1	0.00	0.0
105	RED BROWN SILT LOAM, 3 TO 8 PERCENT SLOPES (ALL MEASUREMENTS FROM FLOODPLAIN)	C	0.7	0.5	0.00	0.0
TOTAL			117.1	100	9.20	99.5

NOTES:

SYMBOLS FOR SOIL TYPE

100: HYDROLOGIC SOIL GROUP

101: LIMIT OF SETTLEMENT

102: FINE FINE FINE FINE

103: NO SOILS IN THE LOT ARE LISTED AS BEING A VALUE OF 0.00 OR GREATER (WHICH IS ENOUGH)

104: SOIL BOUNDARIES AND INFORMATION OBTAINED FROM NRCS WEB SOIL SURVEY

NOT FOR CONSTRUCTION

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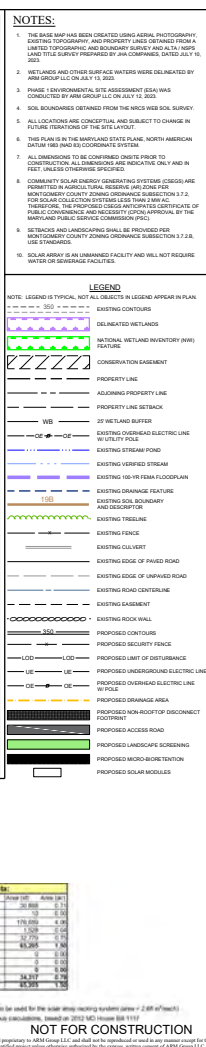
12/13/2024
201091


EXISTING SITE CONDITIONS PLAN
CONCEPT SITE DEVELOPMENT PLAN


POKESVILLE
MONTGOMERY COUNTY, MARYLAND

ARM GROUP LLC PROJECT
ARM GROUP LLC PROJECT

Sheet 2

[illegible]

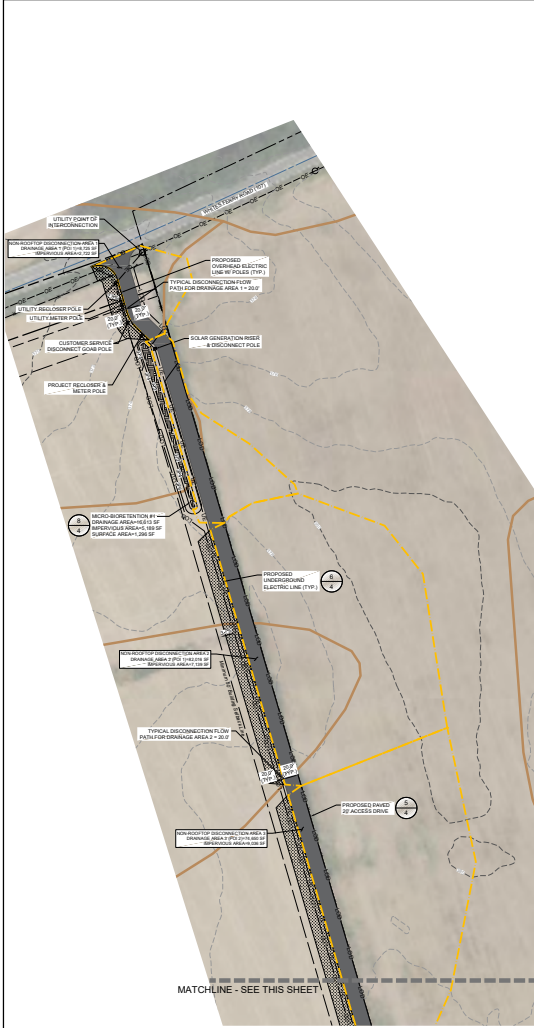

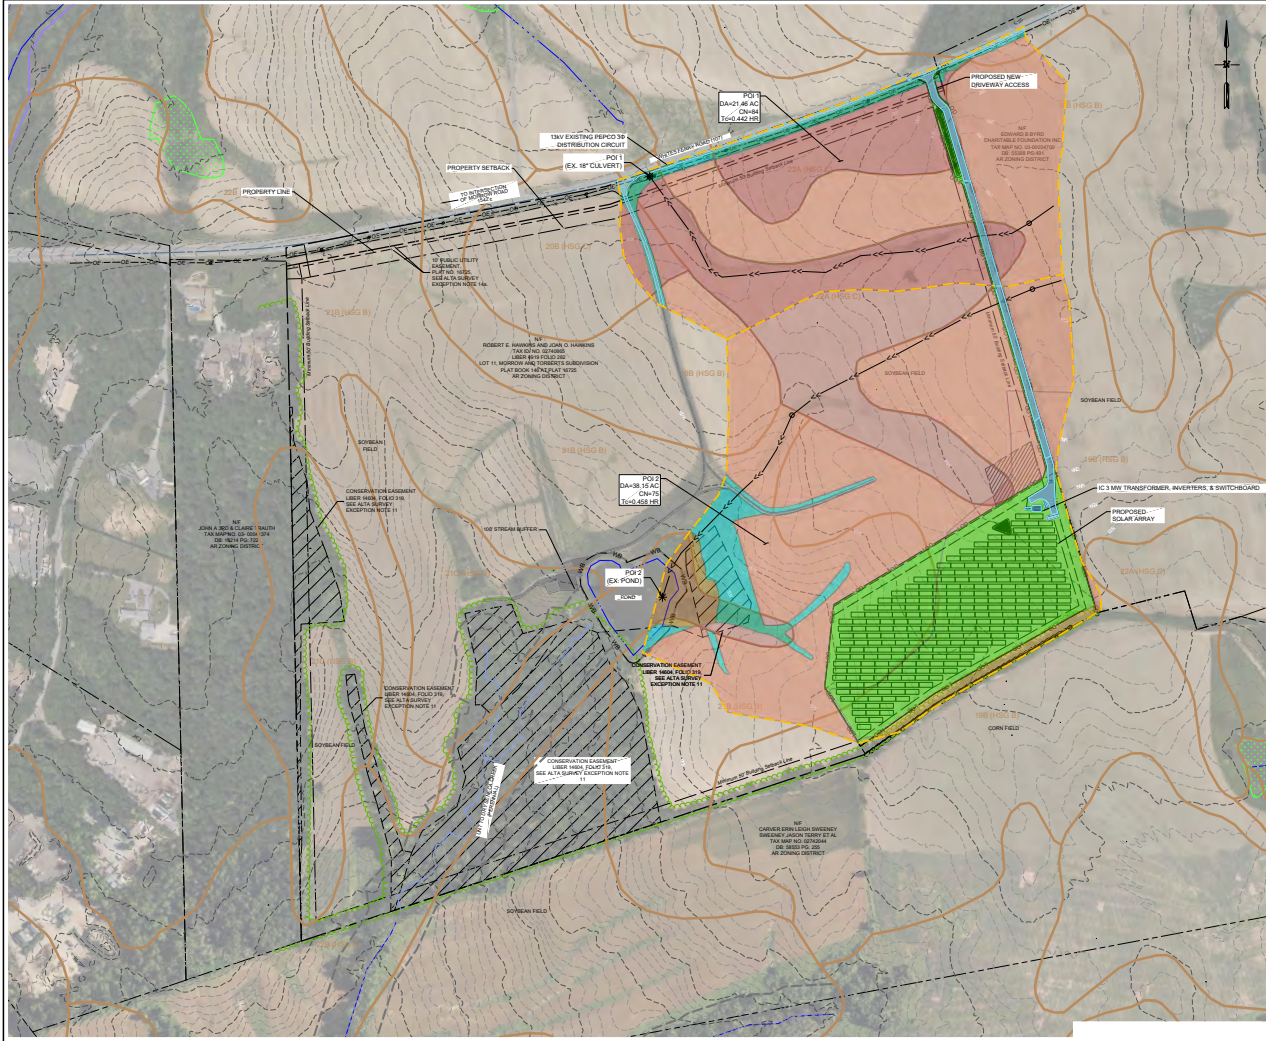

- NOTES:**
1. THE BASE MAP HAS BEEN CREATED USING AERIAL PHOTOGRAPHY, EXISTING TOPOGRAPHY, AND PROPERTY LINES OBTAINED FROM HANFORD COUNTY, MARYLAND GIS MAPS AND RECORDS. THIS BASE MAP DOES NOT REPRESENT THE ACTUAL FIELD SURVEY AND PROPERTY LINES ARE TO BE FIELD SURVEYED BY OTHERS.
 2. WETLANDS AND OTHER SURFACE WATERS WERE DELINEATED BY ARM GROUP LLC ON MAY 12, 2023.
 3. FOREST STAND INVENTORY WAS CONDUCTED BY ARM GROUP LLC ON MAY 12, 2023.
 4. PHASE 1 ENVIRONMENTAL SITE ASSESSMENT (ESA) WAS CONDUCTED BY ARM GROUP LLC ON APRIL 27, 2023.
 5. SOIL BOUNDARIES OBTAINED FROM THE MNCB WEB SOIL SURVEY.
 6. ALL LOCATIONS ARE CONCEPTUAL AND SUBJECT TO CHANGE IN FUTURE ITERATIONS OF THE SITE LAYOUT.
 7. THIS PLAN IS IN THE MARYLAND STATE PLANE, NORTH AMERICAN DATUM 1983 (NAD 83) COORDINATE SYSTEM.
 8. ALL DIMENSIONS TO BE CONFIRMED ON-SITE PRIOR TO CONSTRUCTION.
 9. ALL DIMENSIONS ARE INDICATIVE ONLY AND IN FEET, UNLESS OTHERWISE SPECIFIED.
 10. COMMUNITY SOLAR ENERGY GENERATING SYSTEM (CEGS) PER HANFORD COUNTY ZONING CODE SUBSECTION 20-161(b)(1).
 11. SETBACKS SHALL BE A MINIMUM 100 FEET FROM ALL PROPERTY LINES AND HANFORD COUNTY ZONING CODE SUBSECTION 20-161(b)(1).
 12. SOLAR ENERGY SYSTEM IS AN UNMANNED FACILITY AND WILL NOT REQUIRE WATER OR ERECTION FACILITIES.
 13. PER THE HANFORD COUNTY HISTORIC PRESERVATION DESIGN GUIDELINES, THE SOLAR ENERGY SYSTEM IS NOT WITHIN VISIONED OF THE HISTORIC STRUCTURE LOCATED ON THE PROPERTY.

LEGEND

NOTE: LEGEND IS TYPICAL, NOT ALL OBJECTS IN LEGEND APPEAR IN PLAN

- EXISTING CONTOURS
- DEVELOPED WETLANDS
- TOTAL WETLAND (WETLAND) AREA
- PROPERTY LINE
- ADJACENT PROPERTY LINE
- PROPERTY LINE SETBACK
- LOCAL HISTORIC PROPERTY
- EXISTING OVERHEAD ELECTRIC LINE
- EXISTING VERIFIED STREAM
- EXISTING 10-15 INCH FLOW CAPACITY
- EXISTING DRAINAGE FEATURE
- EXISTING SOLAR BOUNDARY AND ENCLOSURE
- PROPOSED CONTOURS
- PROPOSED SECURITY FENCE
- PROPOSED LIMIT OF DISTURBANCE
- PROPOSED UNDERGROUND ELECTRIC LINE
- PROPOSED OVERHEAD ELECTRIC LINE
- PROPOSED WATERSHED BERM
- PROPOSED ACCESS ROAD EQUIPMENT PAD
- PROPOSED SOLAR MODULES
- POST DEVELOPMENT DRAINAGE DITCH
- TIME OF CONCENTRATION PATH
- FLOW TRANSITION POINT
- POINT OF INVESTIGATION (POI)

SOILS

- B SOILS - GRASS
- C SOILS - GRASS
- B SOILS - MEADOW
- C SOILS - MEADOW
- B SOILS - ROW CROPS
- C SOILS - ROW CROPS
- B SOILS - WOODS
- C SOILS - WOODS
- INTERVIOUS SURFACE WATER
- PANELS (SLOPES > 10% FULL DISCONNECT)

NOT FOR CONSTRUCTION

This drawing, its contents, and each component of this drawing are the property of and proprietary to ARM Group LLC and shall not be reproduced or used for any purpose except for the specific project identified on the title block. All other uses are prohibited and shall be the responsibility of the user. Information authorized by the engineer, written consent of ARM Group LLC.

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DATE	DESCRIPTION	BY	CHKD
12/13/2024	201091		
12/20/24			
1/2/25			

**POST DEVELOPMENT DRAINAGE AREA MAP
CONCEPT SITE DEVELOPMENT PLAN**

POLESVILLE
HANOVER PROJECT
CLARK COUNTY, MARYLAND

Sheet **8**

[illegible]

LIST OF SHEETS	
SHEET NO.	DESCRIPTION
1	COVER SHEET
2	PROPOSED SITE CONDITIONS PLAN (OVERALL)
3	PROPOSED SITE CONDITIONS PLAN
4	PROPOSED SITE DETAILS (SHEET 1 OF 2)
5	PROPOSED SITE DETAILS (SHEET 2 OF 2)



<p><u>PREPARED FOR DEVELOPER:</u> CHABERTON SOLAR RAMIERE LLC 1700 ROCKVILLE PIKE, SUITE 305 ROCKVILLE, MD 20852 (804) 929-8418</p>	<p><u>PROPERTY OWNER:</u> ROBERT HAWKINS 9919 WATKINS ROAD GAITHERSBURG, MD 20882 (301) 651-7146</p>
<p><u>SITE ADDRESS:</u> 17600 WHITES FERRY ROAD, POOLESVILLE, MD 20837 (39.1215°N, -77.3556°W)</p>	

PROJECT SITE

1. EXISTING ZONING: AGRICULTURAL RESERVE (AR) ZONE
2. EXISTING USE: AGRICULTURE
3. PROPOSED USE: COMMUNITY SOLAR ENERGY GENERATING SYSTEM (CSEGS)
4. TOTAL SITE AREA: 117.06 AC
5. TOTAL PROPOSED DEVELOPMENT AREA (LIMIT OF DISTURBANCE): 445,725 SF (10.2 AC)
6. PLOT NO. 52745600, LIBERTY 49TH, PLOD 282, LOT 11 IN THE MORROW AND TORBERTS SUBDIVISION
RECORDED IN PLAT BOOK 146 AT PLAT 16725.
7. SYSTEM SIZE: 3.38 MW DC / 3.00 MW AC

MISS UTILITY

CALL "MISS UTILITY" AT 1-800-257-7777, 48 HOURS PRIOR TO THE START OF WORK. THE EXCAVATOR MUST NOTIFY ALL PUBLIC UTILITY COMPANIES WITH UNDER GROUND FACILITIES IN THE AREA OF PROPOSED EXCAVATION AND HAVE THOSE FACILITIES LOCATED BY THE UTILITY COMPANIES PRIOR TO COMMENCING EXCAVATION. THE EXCAVATOR IS RESPONSIBLE FOR COMPLIANCE WITH REQUIREMENTS OF CHAPTER 36A OF THE MONTGOMERY COUNTY CODE.



PREPARED BY:

 **ARM Group LLC**
Engineers and Scientists
www.armgroup.net


HEADQUARTERS:
1129 West Governor Road • Hershey, PA 17033-0797
Ph: (717) 533-8600 Fax: (717) 533-8605



PROFESSIONAL CERTIFICATION: I HEREBY CERTIFY THAT THESE DOCUMENTS WERE PREPARED OR APPROVED BY ME, AND THAT I AM A DULY LICENSED PROFESSIONAL ENGINEER UNDER THE LAWS OF THE STATE OF MARYLAND. LICENSE NO. 81081 EXPIRATION DATE: 05-11-25

THIS DRAWING SET WAS ORIGINALLY PRODUCED IN COLOR. NON-COLOR REPRODUCTIONS DO NOT SUFFICIENTLY DIFFERENTIATE AMONG FEATURES DEPICTED IN THIS DRAWING SET.

THIS DRAWING, ITS CONTENTS, AND EACH COMPONENT OF THIS DRAWING ARE THE PROPERTY OF AND PROPRIETARY TO ARM GROUP INC. AND SHALL NOT BE REPRODUCED OR USED IN ANY MANNER EXCEPT FOR THE PURPOSE IDENTIFIED ON THE TITLE BLOCK, AND ONLY BY OR ON BEHALF OF THIS CLIENT FOR THE IDENTIFIED PROJECT UNLESS OTHERWISE AUTHORIZED BY THE EXPRESS, WRITTEN CONSENT OF ARM GROUP INC.

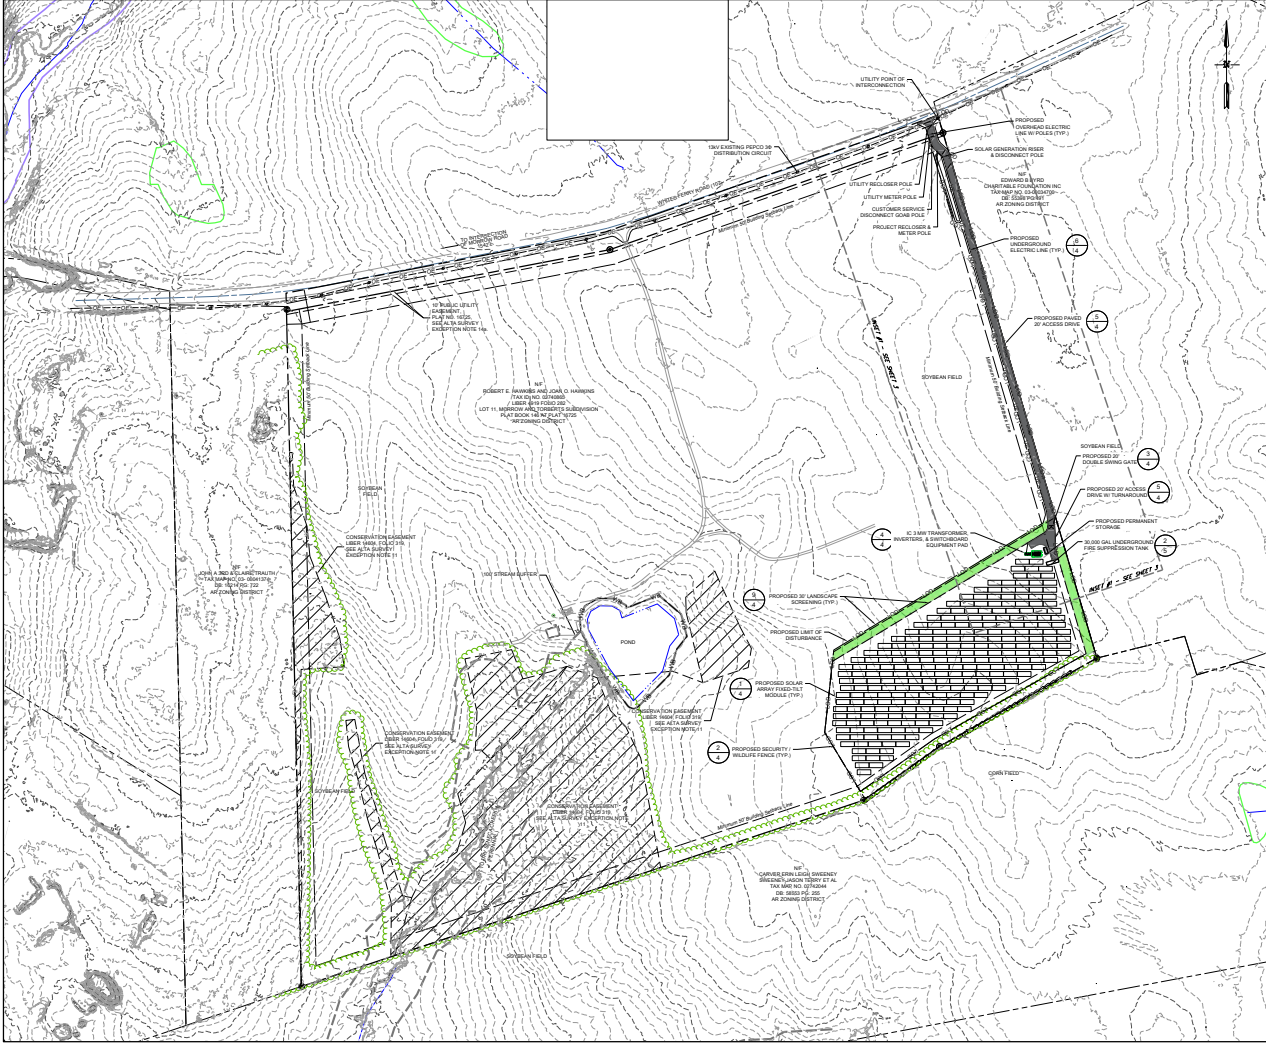

NOTES:

1. THE BASE MAP HAS BEEN CREATED USING AERIAL PHOTOGRAPHY LIMITED TOPOGRAPHIC AND PROPERTY LINES DERIVED FROM A LIMITED TOPOGRAPHIC AND BOUNDARY SURVEY AND ALTA RIGHTS LIMITED TO SURVEY PREPARED BY ARM GROUP LLC ON JULY 10, 2023.
2. WETLANDS AND OTHER SURFACE WATERS WERE DELINEATED BY ARM GROUP LLC ON JULY 10, 2023.
3. SOLAR BOUNDARIES OBTAINED FROM THE MRS WEB SOL SURVEY.
4. ALL LOCATIONS ARE CONCEPTUAL AND SUBJECT TO CHANGE IN FUTURE ITERATIONS OF THE SITE LAYOUT.
5. THE PLAN IS IN THE NAD83 DATUM AND IS COORDINATE SYSTEM.
6. ALL DIMENSIONS TO BE CONFIRMED ON SITE PRIOR TO CONSTRUCTION. ALL DIMENSIONS ARE INDICATED ON AND IN FIELD. DIMENSIONS OF OBJECTS.
7. THE PROPOSED SOLAR ENERGY GENERATING SYSTEMS (SEG) ARE MONITORING COUNTY ZONING ORDINANCE SUBSECTION 3.7.2, FOR SOLAR COLLECTION SYSTEMS LESS THAN 100 AC. THEREFORE, THE PROPOSED SEG ANTICIPATES CERTIFICATE OF PUBLIC CONSENT AND NECESSITY (CPCN) APPROVAL BY THE MONITORING COUNTY ZONING ORDINANCE SUBSECTION 3.7.2. THEREFORE, THE PROPOSED SEG ANTICIPATES CERTIFICATE OF PUBLIC CONSENT AND NECESSITY (CPCN) APPROVAL BY THE MONITORING COUNTY ZONING ORDINANCE SUBSECTION 3.7.2. THEREFORE, THE PROPOSED SEG ANTICIPATES CERTIFICATE OF PUBLIC CONSENT AND NECESSITY (CPCN) APPROVAL BY THE MONITORING COUNTY ZONING ORDINANCE SUBSECTION 3.7.2.
8. SETBACKS AND LANDSCAPING SHALL BE PROVIDED FOR MONITORING COUNTY ZONING ORDINANCE SUBSECTION 3.7.2. THEREFORE, THE PROPOSED SEG ANTICIPATES CERTIFICATE OF PUBLIC CONSENT AND NECESSITY (CPCN) APPROVAL BY THE MONITORING COUNTY ZONING ORDINANCE SUBSECTION 3.7.2.
9. SOLAR ARRAY IS AN UNIMPAIRED FACILITY AND WILL NOT REQUIRE WETLAND OR BERMING FACILITIES.

LEGEND

NOTE: LEGEND IS TYPICAL. NOT ALL OBJECTS IN LEGEND APPEAR IN PLAN.

- EXISTING CONTOURS
- EXISTING VERIFIED WETLANDS
- NATIONAL WETLAND AND WATERSHED ONLY FEATURE
- CONSERVATION EASEMENT
- PROPERTY LINE
- ADJOINING PROPERTY LINE
- PROPERTY LINE SETBACK
- 25' WETLAND BUFFER
- PROPOSED OVERHEAD ELECTRIC LINE
- PROPOSED UNDERGROUND ELECTRIC LINE
- EXISTING STREAM/POD
- EXISTING VERIFIED STREAM
- EXISTING 100' FIRM FLOODPLAIN
- EXISTING DRAINAGE FEATURE
- EXISTING TREELINE
- EXISTING FENCE
- EXISTING EASEMENT
- EXISTING EDGE OF PAVED ROAD
- EXISTING ROAD CENTERLINE
- EXISTING EASEMENT
- EXISTING ROCK WALL
- PROPOSED CONTOUR
- PROPOSED SECURITY FENCE
- PROPOSED LIMIT OF DISTURBANCE
- PROPOSED UNDERGROUND ELECTRIC LINE
- PROPOSED OVERHEAD ELECTRIC LINE
- PROPOSED SOLAR MODULES
- PROPOSED LANDSCAPE SCREENING

PROFESSIONAL CERTIFICATION / HEREBY CERTIFY THAT THESE DOCUMENTS WERE PREPARED OR APPROVED BY ME, AND THAT I AM A QUALIFIED PROFESSIONAL ENGINEER UNDER THE LAWS OF THE STATE OF MONTANA, LICENSE NO. 10836, EXPIRATION DATE: 06/30/26.

STATE OF MONTANA


PROPOSED SITE CONDITIONS (OVERALL)

FIRE DEPARTMENT ACCESS PLAN

ARM GROUP LLC
Engineers and Scientists
www.armgroup.net

POKEVILLE
ARM GROUP LLC
MONTGOMERY COUNTY, MONTANA

Sheet 2

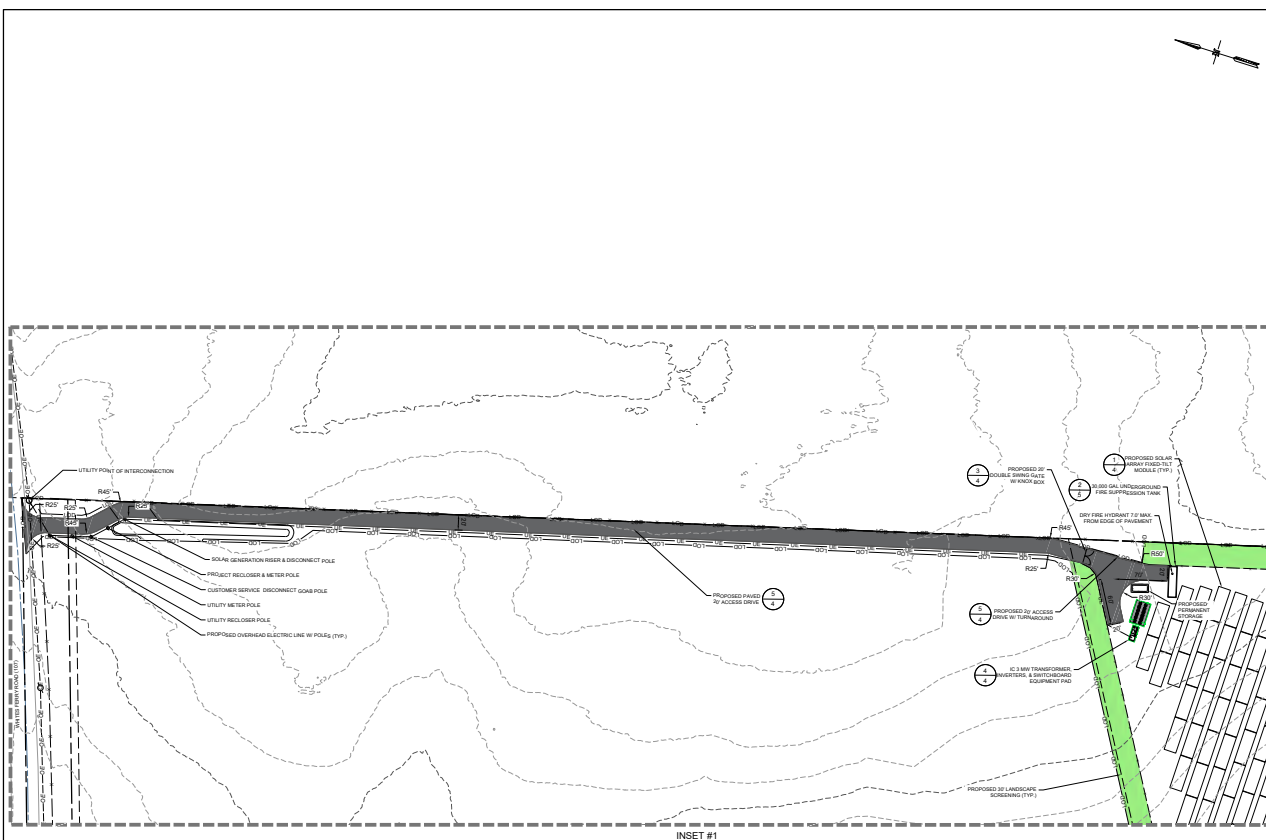

- ## NOTES:
1. THE BASE MAP HAS BEEN CREATED USING AERIAL PHOTOGRAPHY, PHOTOGRAMMETRY, AND PROPERTY LINES OBTAINED FROM A LOCAL TOPOGRAPHIC AND BOUNDARY SURVEY AND ALTA RIGHTS OF WAY. THE PRESENTATION OF THE COMPASSES, DATED JULY 1, 2003, IS FOR INFORMATION ONLY.
 2. WETLANDS AND OTHER SURFACE WATER WERE DELINEATED BY ARMA GROUP LLC ON JULY 1, 2003.
 3. PHASE I ENVIRONMENTAL SITE ASSESSMENT (ESA) WAS CONDUCTED BY ARMA GROUP LLC ON JULY 1, 2003.
 4. SOIL SAMPLES OBTAINED FROM THE MDC'S SOIL SURVEY.
 5. ALL LOCATIONS ARE CONCEPTUAL AND SUBJECT TO CHANGE IN FUTURE ITERATIONS OF THE SITE LAYOUT.
 6. THIS PLAN IS IN THE MARYLAND STATE PLANE, NORTH AMERICAN DATUM 83, WITH THE COORDINATES OF JULY 1, 2003.
 7. ALL DIMENSIONS TO BE CONFIRMED ONCE PRIOR TO CONSTRUCTION. ALL DIMENSIONS ARE INDICATIVE ONLY AND IN NO WAY GUARANTEE THE ACCURACY OF THE PLAN.
 8. THE MONTGOMERY COUNTY ZONING ORDINANCE SUBSECTION 3.7.2, ENVIRONMENTAL PROTECTION AND PRESERVATION, REQUIRES THAT, THEREFORE, THE PROPOSED CSESSE ANTICIPATES CERTIFICATE OF ENVIRONMENTAL PROTECTION AND PRESERVATION APPROVAL BY THE MARYLAND PUBLIC SERVICE COMMISSION (PSC).
 9. SETBACKS AND LANDSCAPING SHALL BE PROVIDED PER MONTGOMERY COUNTY ZONING ORDINANCE SUBSECTION 3.7.2, USE STANDARDS.
 10. SOLAR ARRAY IS AN UNARMED FACILITY AND WILL NOT REQUIRE PROTECTIVE FENCE FACILITIES.

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[illegible]

speed	CDW	calc	1" = 60'			
date	KJM		01/10/2025			
area	CDW	print at scale	23010891			
graph scale						
				THE INFORMATION CONTAINED HEREIN IS UNCLASSIFIED DATE 01/10/2025 BY 60322 EXEMPT FROM GDS		
				Revision		
				No		

RAMIERE SOLAR PROJECT CHABERTON SOLAR RAMIERE, LLC	POOLESVILLE MONTGOMERY COUNTY, MARYLAND
---	--

Sheet 3

Sheet 5

[illegible]

designed	JA	scale	N/A
checked	JA	date	2/21/2025
drawn	CDW	project no.	23010891

ER SHEET
FOREST CONSERVATION PLAN
LECTION DISTRICT: 7 WSSC: 222NW17 TM: DS13
POOLESVILLE,
MONTGOMERY COUNTY, MARYLAND


1. THE FOREST STAND DELINEATION WAS CONDUCTED ON SEPTEMBER 21, 2023, BY MICHELLE S. COHEN, QUALIFIED PROFESSIONAL, AND DETERMINED THAT THERE WERE NO FOREST STANDS PRESENT WITHIN THE PROJECT AREA. THE APPROXIMATE 10.6 AC. REMAINDER OF THE FOREST SUBJECT PROPERTY WAS IDENTIFIED ON THE REMAINDER OF THE PROPERTY ON SEPTEMBER 4, 2024 BY JOSEPH ATZERTI, QUALIFIED PROFESSIONAL. A DIAMETER TAPE WAS USED TO MEASURE THE DIAMETER OF THE TREES. NR#40202810 WAS APPROVED ON 11/6/2025.
2. FOREST CONSERVATION PLAN WAS PREPARED BY JOSEPH ATZERTI, QUALIFIED PROFESSIONAL.
3. WETLANDS AND OTHER SURFACE WATERS WERE DELINEATED BY ARM GROUP LLC ON JULY 13, 2023 FOR THE PROJECT AREA APPROXIMATELY 16.1 AC. THE REMAINDER OF THE FOREST SUBJECT PROPERTY WAS INVESTIGATED AND SURFACE WATERS DELINEATED ON OCTOBER 16, 2024 BY ARM GROUP LLC.
4. SIGNIFICANT (>24") AND CRITICAL ROOT ZONE LIMITS ARE PRESENT IN THE WOODED TO THE WEST OF THE PROJECT AREA. HOWEVER, ANY SPECIFIC ROOT ZONE LIMITS ARE AVOIDED.
5. THE PURPOSE OF THIS PROJECT IS FOR THE INSTALLATION OF A COMMUNITY SOLAR ENERGY SYSTEM WITHIN AN AGRICULTURAL RESERVE AREA. APPROXIMATELY 92.51 ACRES WILL REMAIN IN AGRICULTURAL LAND USE.
6. NO MAPPED STREAMS WERE IDENTIFIED WITHIN THE SOLAR PROJECT AREA (APPROXIMATELY 10.6 AC) BASED UPON REVIEW OF USGS MAPPING. HOWEVER, AN UNNAMED TRIBUTARY WITHIN THE PROPERTY AREA APPROXIMATELY 0.2 AC. COULD BE PRESENT. THE TRIBUTARY DRAINAGE INTO THE POTOMAC RIVER (HUC 22140208), WHICH FLOWS TO THE CHESAPEAKE BAY VIA THE POTOMAC RIVER. ACCORDING TO CODE 26.1-1-1, THE REGULAR FLOODPLAIN OF THE POTOMAC RIVER, WHICH INCLUDES THE TRIBUTARY, HAS A USE OF CLASS 1P - WATER CATCHMENT RECREATION, PROTECTION OF AESTHETIC LIFE, AND PUBLIC WATER SUPPLY. SENECA CREEK HAS NOT BEEN DESIGNATED AS A TIER I RIVER OR CATCHMENT BASIN.
7. ACCORDING TO THE FEMA FLOOD INSURANCE RATE MAP PANEL NO. 2403103050, EFFECTIVE ON 09/29/2008, FEMA 100-YEAR FLOODPLAIN IS NOT PRESENT WITHIN THE PROJECT AREA.
8. A LETTER WAS SUBMITTED ON AUGUST 22, 2023 TO THE MARYLAND DEPARTMENT OF NATURAL RESOURCES (MDNR) WILDLIFE AND HERITAGE DIVISION REQUESTING INFORMATION ON ANY SPECIES OF CONCERN FOR THE PROJECT AREA. ON PROPOSED PROJECT AREA, A SENECA CREEK AND SENECA CREEK TRIBUTARY RECEIVED FROM MDNR, WHICH INDICATED THERE ARE NO ANIMAL RECORDS FOR STATE OR FEDERAL LISTED CANDIDATE, PROPOSED OR RARE PLANT OR OFFICIAL SPECIES KNOWN TO THE AREA.
9. THE UNITED STATES FISH AND WILDLIFE SERVICE (USFWS) INFORMATION FOR PLANNING AND CONSULTATION FOR THE PROJECT AREA ON JANUARY 20, 2024, INDICATED THAT THERE ARE NO SPECIES OF CONCERN OR ENDANGERED SPECIES AT THE PROJECT SITE AND THERE ARE NO SPECIFIC REQUIREMENTS PERTAINING TO PROTECTIVE MEASURES. CRITICAL HABITAT IS NOT PRESENT. HOWEVER, THE MONARCH BUTTERFLY, A FEDERAL SPECIES, WAS IDENTIFIED AND MEASURES FOR CONSERVATION OF SPECIES SHOULD BE CONSIDERED.

10. A LETTER WAS SUBMITTED ON AUGUST 22, 2023 TO THE MARYLAND HISTORICAL TRUST (MHT) REQUESTING INFORMATION ON ANY KNOWN HISTORICAL RESOURCES WITHIN THE PROJECT AREA. THE PROJECT AREA RESPONSE, DATED 10/10/2023, STATED THAT THERE WAS NO RECORD OF ANY DETERMINING THAT THERE ARE NO HISTORIC PROPERTIES AFFECTED BY THE PROPOSED PROJECT.
11. THE FOREST (APPROXIMATELY 1743 AC) IS CURRENTLY IN A CONSERVATION EASEMENT. THE FORESTED AREAS REMAIN INTACT AS ILLUSTRATED. OVERALL, THE FORESTED AREA IS DEVOIDS WITHIN THE PARCEL. THE FORESTED AREAS INCLUDE: WHITE PINE (*Pinus strobus*), WHITE BARKED PINE (*Pinus strobus*), PINE (*Pinus strobus*), TOXICODENDRON RADICANS, JAPANESE STILTGRASS, JAPANESE HONEYUCKLE, JAPANESE BARBERRY, AUTUMN OLIVE, AND MULTIFLORA ROSE (*Rosa multiflora*). OVER THE FOREST ASSOCIATED WITH THE FORESTED AREAS, THERE ARE SEVERAL SPECIES OF FOREST OAK SPECIES. THE FORESTED AREA IS SITUATED TO THE SOUTH TO OTHER FORESTS VIA THE RIPARIAN CORRIDOR (LIMITED IN WIDTH). THE UNDERSTORY IS OPEN TO MODERATELY OPEN. THE FORESTED AREAS ARE ASSOCIATED WITH THE FORESTED AREAS.
12. THE FORESTED AREA (STAND A) IS PROBABLY WITH THE UNNAMED TRIBUTARY DRY SENECA CREEK IS A RED MAPLE (*Acer rubrum*) AND OAK (*Quercus* sp.) SPECIES AND SPICEBUSH (*Lindera benzoin*) IS NOTED IN THE FORESTED AREA. THE FORESTED AREAS INCLUDE: WHITE PINE (*Pinus strobus*), WHITE BARKED PINE (*Pinus strobus*), PINE (*Pinus strobus*), TOXICODENDRON RADICANS, JAPANESE STILTGRASS, JAPANESE HONEYUCKLE (*Lonicera japonica*), INVASIVE SPECIES INCLUDING THE JAPANESE HONEYUCKLE AS WELL AS JAPANESE BARBERRY (*Berberis thunbergii*) AND JAPANESE STILTGRASS (*Microstegium*). THE FORESTED AREAS ARE PROBABLY WITH THE UNNAMED TRIBUTARY DRY SENECA CREEK. THE FORESTED AREAS ARE PRESENT IN THE FORESTED AREAS IN CONSERVATION EASEMENT.
13. THE FOREST TO THE SOUTHWEST (STAND B) OF THE STORAGE SHED / BUILDING COMBINES SURFACE DRAINAGE FEATURES TO THE UNNAMED TRIBUTARY AND IS COMPRISED OF A SYCAMORE AND RIVER BIRCH (*Betula nigra*). THE FORESTED AREAS INCLUDE: WHITE PINE (*Pinus strobus*), WHITE BARKED PINE (*Pinus strobus*), PINE (*Pinus strobus*), TOXICODENDRON RADICANS, JAPANESE STILTGRASS, JAPANESE HONEYUCKLE (*Lonicera umbellata*), AND AUTUMN OLIVE (*Elaeagnus umbellata*) WERE NOTED IN THE UNDERSTORY.
14. STAND D IS LOCATED ALONG THE WESTERN EXTENT OF THE AOI. THE FOREST AT THIS LOCATION HAD 60 PERCENT CANOPY CLOSURE SO THE FOREST HAD A SHRUBBY UNDERSTORY. A MAJORITY OF THE TREES ARE UNDER 18-INCH DIAMETER AT BREAST HEIGHT (DBH). TREES OBSERVED INCLUDE SYCAMORE AND WHITE BIRCH (*Betula nigra*). THE FORESTED AREAS INCLUDE: WHITE PINE (*Pinus strobus*), WHITE BARKED PINE (*Pinus strobus*), PINE (*Pinus strobus*), TOXICODENDRON RADICANS, JAPANESE STILTGRASS, JAPANESE HONEYUCKLE (*Lonicera umbellata*), AND AUTUMN OLIVE (*Elaeagnus umbellata*) WERE NOTED IN THE UNDERSTORY.
15. SYCAMORE AND PIN OAK (*Quercus palustris*) WERE NOTED AROUND THE POND AREA.
16. THE TREE ROW ALONG THE SOUTHEASTERN PROPERTY EXTENT IS COMPRISED OF BLACK CHERRY, BLACK WALNUT (*Juglans nigra*), RED MAPLE, HACKBERRY (*Celtis occidentalis*), WHITE MULBERRY (*Morus alba*), AND WHITE BIRCH (*Betula nigra*). THE FORESTED AREAS INCLUDE: WHITE PINE (*Pinus strobus*), WHITE BARKED PINE (*Pinus strobus*), PINE (*Pinus strobus*), TOXICODENDRON RADICANS, JAPANESE STILTGRASS, JAPANESE HONEYUCKLE (*Lonicera umbellata*), AND AUTUMN OLIVE (*Elaeagnus umbellata*) WERE NOTED IN THE UNDERSTORY.

Developer's Name:	CHABERTON SOLAR RAMIERE LLC <i>Printed Company Name</i>
Contact Person or Owner:	MICHAEL DONIGER <i>Printed Name</i>
Address:	1700 ROCKVILLE PIKE, SUITE 305 ROCKVILLE, MD 20852
Phone and Email:	(804) 929-8418 MIKE.DONIGER@CHABERTON.COM
Signature:	

A map of the study area showing the location of the site. The map includes three roads: Whites Ferry Rd running horizontally across the top, Sugarland Rd running vertically on the right, and Morrow Rd running vertically on the left. A dashed rectangular boundary encloses a portion of the area. Inside this boundary, a black dot marks the 'SITE'. A small triangle is also visible within the dashed boundary, to the left of the site. The map is oriented with North at the top.

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DEVELOPER'S CERTIFICATE

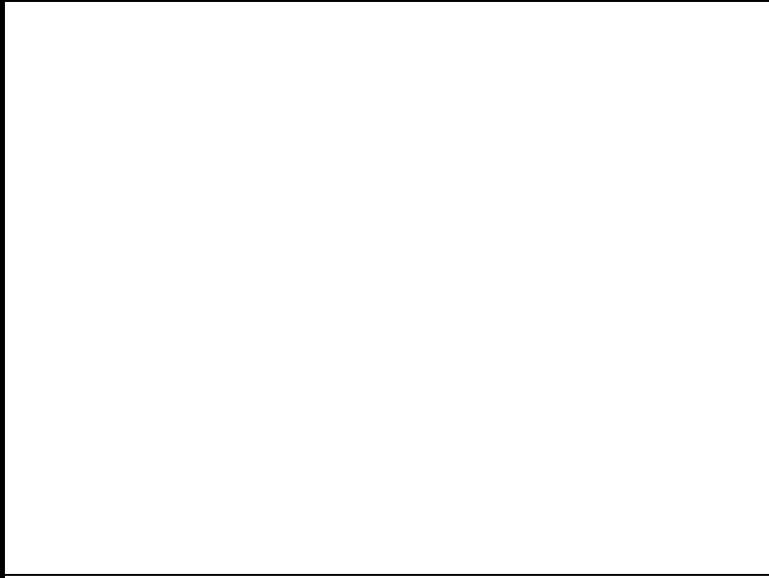The Undersigned agrees to execute all the features of the Approved Final Forest Conservation Plan No. F20250480 including, financial bonding, forest planting, maintenance, and all other applicable agreements.

Developer's Name:

CHABERTON SOLAR RAMIERE LLC

Printed Company Name

Contact Person or Owner:

MICHAEL DONIGER

Printed Name

Address:

1700 ROCKVILLE PIKE, SUITE 305 ROCKVILLE, MD 20852

Phone and Email:

(804) 929-8418 MIKE.DONIGER@CHABERTON.COM

Signature:

Sheet

2

Drawing Title

FUTURE APPROVALS
PRELIMINARY/FINAL FOREST CONSERVATION PLAN

Project Title

RAMIERE SOLAR PROJECT
#F20250480
ELECTION DISTRICT: 7 WSSC: 222NW17 TM: DS13
POOLESVILLE,
MONTGOMERY COUNTY, MARYLAND

For Chaberton Project: 23101081 Ramier Solar Production (CFP 23101081) S&B's (C) 2024, Revised February 21, 2024



ARM Group LLC
Engineers and Scientists
www.armgroup.net

0	ISSUED FOR COUNTY REVIEW		01/29/2025	ARM	By
No.	Revision		Date		

