THE CITY OF TAKOMA PARK PLANNING AND COMMUNITY DEVELOPMENT MAPLE AVENUE CONNECTIVITY PROJECT

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CARROLL AVENUE TO HILLTOP ROAD /SLIGO CREEK PARKWAY

SHA TRACKING No. FAP No. CITY IFB No.



HORIZONTAL DATUM	NAD 83/11
VERTICAL DATUM	NAVD 88
WSSC TWO-HUNDRED FOOT SHEET NUMBER	

	SCALE:	1"=2000'	
2000	0	2000	4000 feet

30% SUBMISSION
NOT FOR CONSTRUCTION
MAY 2024

AASHTO DESIGN CRITERIA

THIS PROJECT WAS DESIGNED IN ACCORDANCE WITH THE 2018 (7TH EDITION) PUBLICATION OF AASHTO'S "A POLICY ON GEOMETRIC DESIGN OF HIGHWAYS AND STREETS."

STANDARD SPECIFICATIONS BOOK,

BOOK OF STANDARDS AND MUTCD

ALL WORK ON THIS PROJECT SHALL CONFORM TO: THE LATEST APPROVED MARYLAND DEPARTMENT OF TRANSPORTATION STATE HIGHWAY ADMINISTRATION (MDOT SHA) "STANDARD SPECIFICATIONS FOR CONSTRUCTION AND MATERIALS" REVISIONS THEREOF OR ADDITIONS THERETO, AS INDICATED IN THE PROJECT DESCRIPTION OF THE INVITATIONS FOR BIDS BOOK; THE SPECIAL PROVISIONS INCLUDED IN THE INVITATION FOR BIDS BOOK; THE ADMINISTRATION'S "BOOK OF STANDARDS FOR HIGHWAYS AND INCIDENTAL STRUCTURES" AND THE LATEST ADOPTED MUTCD.

RIGHT OF WAY

RIGHT OF WAY AND EASEMENT LINES SHOWN ON THESE PLANS ARE FOR ASSISTANCE IN INTERPRETING THE PLANS. THEY ARE NOT OFFICIAL. FOR OFFICIAL FEE RIGHT OF WAY AND EASEMENT INFORMATION, SEE THE APPROPRIATE RIGHT OF WAY PLATS.

UTILITIES

THE LOCATION OF UTILITIES SHOWN ON THE PLANS ARE FOR INFORMATION AND GUIDANCE ONLY. NO GUARANTEE IS MADE OF THE ACCURACY OF SAID LOCATIONS.

ADA COMPLIANCE

THE DESIGN OF THIS PROJECT HAS INCORPORATED FACILITIES TO ACCOMODATE PERSONS WITH DISABILITIES IN COMPLINACE WITH STATE AND FEDERAL LEGISLATION

ENVIRONMENTAL INFORMATION

ALL STORMWATER MANAGEMENT FACILITIES CONSTRUCTED FOR THIS CONTRACT SHALL BE INSPECTED AND MAINTAINED IN ACCORDANCE WITH THE CITY OF TAKOMA PARK MUNICIPAL CODE TITLE 16 (SECTIONS 16.04.210 THROUGH 16.04.260)

SEDIMENT AND EROSION CONTROL REGULATIONS WILL BE STRICTLY ENFORCED DURING CONSTRUCTION.

STANDARD STABILIZATION NOTE:

FOLLOWING INITIAL SOIL DISTURBANCE OR REDISTURBANCE, PERMANENT OR TEMPORARY STABILIZATION SHALL BE COMPLETED WITHIN THREE (3) CALENDER DAYS AS TO THE SURFACE OF ALL PERIMETER CONTROLS, DIKES, SWALES, DITCHES, PERIMETER SLOPES, AND ALL SLOPES GREATER THAN 3 HORIZONTAL TO 1 VERTICAL (3:1), AND SEVEN DAYS (7) AS TO ALL OTHER DISTURBED OR GRADED AREAS ON THE PROJECT SITE.

OWNERS / DEVELOPERS CERTIFICATION

I / WE HEREBY CERTIFY THAT ANY CLEARING, GRADING, CONSTRUCTION AND/OR DEVELOPMENT WILL BE DONE PURSUANT TO THIS PLAN, AND THAT ANY RESPONSIBLE PERSONNEL INVOLVED IN THE CONSTRUCTION PROJECT WILL HAVE A CERTIFICATE OF ATTENDANCE AT A MARYLAND DEPARTMENT OF THE ENVIRONMENT APPROVED TRAINING PROGRAM FOR THE CONTROL OF SEDIMENT AND EROSION BEFORE BEGINNING THE PROJECT. I HEREBY AUTHORIZE THE RIGHT OF ENTRY FOR PERIODIC ON-SITE EVALUATION BY STATE OF MARYLAND, DEPARTMENT OF THE ENVIRONMENT, COMPLIANCE INSPECTORS.

Signature	

DATE

ROSALIND GRIGSBY - COMMUNITY DEVELOPMENT MANAGER Printed Name and Title

REVISIONS				

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ABBREVIATIONS

AASHTO	American Association of State Highway
	Transportation Officials
ADT	Average Daily Traffic
AHD	Ahead
APPROX	. Approximate
₿ or B/L	Baseline
BK	Back /Book
BIT	
B.C.	Bituminous Concrete
B.M	
BOT.	
	Center of Curve
	Corrugated Aluminum Pipe
	Corrugated Aluminum Pipe Arch
	Cable Television
	California Bearing Ratio
© or C/L	
CL.	
	Chass Chainlink Fence
	Corrugated Metal Pipe
C.O.	
CONC.	
CONSTR	
COR	
CORR.	
	Corrugated Polyethylene Pipe – Type 'S'
	Corrugated Steel Pipe – Aluminized Type 2
	Corrugated Steel Pipe Arch –
	Aluminized Type 2
	Degree of Curve
	Design Hourly Volume
D.I.	
DIA	_ Diameter
	Double Opening
Ε	. East
Ε	
Ε	External Distance
EA	
EB	_Eastbound
ELEV	_ Elevation
ES	End Section
EX or EXIST.	Existing
FT	_ Feet
F or FL	_ Flowline
F.B.D.	Flat Bottom Ditch
F.H	Fire Hydrant
FWD	-
G	
G.V.	
Н.В.	
	High Density Polyetheylene

HDWL	Headwall
HERCP	Horizontal Ellipitical Reinforced
	Concrete Pipe
HP	High Point
IN	_ Inch
I.S.T	. Inlet Sediment Trap
INV	Invert
	.Junction Box
Κ	K Inlet
L	-
LF	Linear Feet
	Liquid Limit
LP	Low Point
L.P	_ Light Pole
LT	_ Left
MAC	Macadam
M.C	. Moisture Content
MAX	Maximum
M.D.D.	Maximum Dry Content
MOD,	_ Modified
MIN	Minimum
N	_ North
NB	Northbound
NE	_ Northeast
N.P	Non-Plastic
O.C	On Center
OHE	Overhead Electric
O.M	Optimum Moisture
PAV' T	
	. Point of Curvature
PCC	Point of Compound Curvature
	Point of Crown
P⁄GE	Profile Grade Elevation
P.G.E	Profile Ground Elevation
P.G.L	Profile Grade Line
	Profile Ground Line
	Point of Rotation
P.I	Plasticity Index
	Point of Intersection
POC	Point On Curve
РОТ	Point On Tangent
	Polyvinyl Chloride Profile Wall Pipe
PROP	
	Point of Reverse Curve
PT	
	Point of Tangency
	Point of Vertical Curve
	Polyvinyl Chloride
	Point of Vertical Intersection
	Point of Vertical Reverse Curve
	Point of Vertical Tangency
R	
	Rock Fragments
RT	Right



PLOTTED: 6/25/2024

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I HEREBY CERTIFY THAT THESE DOCUMENTS WERE PREPARED OR APPROVED BY ME, AND THAT I AM A DULY LICENSED PROFESSIONAL ENGINEER UNDER THE LAWS OF THE STATE OF MARYLAND.

MD LICENSE NUMBER

EXPIRATION DATE

30% DESIGN NOT FOR CONSTRUCTION

PROPOSED MEDIAN BARRIER ELECTRICAL HAND BOX – SIGNALS	
STATE, COUNTY OR CITY LINES PROPOSED TRAFFIC BARRIER EXISTING TRAFFIC BARRIER PROPOSED FENCE LINE	
BASE LINE OR SURVEY LINE	
	\bullet \bullet \bullet \bullet

GENERAL NOTES

- UTILITY" AT LEAST 48 HOURS IN ADVANCE OF ANY EXCAVATION WORK AT 1-800-257-7777.
- THE CONTRACTOR SHALL PROTECT AND NOT INTERRUPT EXISTING UTILITY SERVICES UNLESS OTHERWISE NOTED ON THE PLANS OR AUTHORIZED BY THE ENGINEER. SEE UTILITY 2. STATEMENT.
- З.
- 4.
- 5. STANDARD PLATES AS OF THE DATE OF ADVERTISEMENT OF THESE PLANS. STANDARD PLATES ARE AVAILABLE AT WWW.MARYLANDROADS.COM.
- THE CONTRACTOR SHALL GRADE FOR POSITIVE DRAINAGE AT ALL ROADWAY INTERSECTIONS, ENTRANCES AND YARDS. 6.
- 7 THE ADMINISTRATION OR THE OWNER.
- 9.
- 10. ADDITIONAL E&S DEVICES.
- 11. SPILLED, DROPPED OR TRACKED ONTO THE ROAD MUST BE REMOVED IMMEDIATELY BY VACUUMING, SCRAPING OR SWEEPING.
- SAW CUTS WILL NOT BE MEASURED BUT WILL BE INCIDENTAL TO OTHER RELATED ITEMS AS SPECIFIED IN THE CONTRACT DOCUMENTS. 12.
- ADJUSTMENT, CONSTRUCTION AND/OR RELOCATION OF WSSC FACILITIES SHALL BE IN ACCORDANCE WITH THE CONDITIONS, SPECIFICATIONS AND DETAILS CONTAINED HEREIN. 13.

	Right of Way
	Reinforced Concrete Pipe
RCPP	Reinforced Concrete Pressure Pipe
	Rock Quality Designation
R.M	Rootmat
S	South
	Sanitary Sewer
	Southbound
	. Storm Drain
	. Surface Drain Ditch
	Super Elevation
SF	
	Square Feet
SHT	Sheet
SPP	Structural Steel Plate Pipe
SPPA	Structural Steel Plate Pipe Arch
S.P.T.	Standard Penetration Testing
SRP	Steel Spiral Rib Pipe –
•••	Aluminized Type 2
SBDV	Steel Spiral Rib Pipe Arch –
000	Aluminized Type 2
	Stopping Sight Distance
	Super Silt Fence
STD	
STA	Station
SO	Single Opening
SY	Square Yards
SWM	Stormwater Management
	Tangent
Т	-
Т Т	Telephone
T T T.C	Telephone Top of Cover
T T T.C T.G	Telephone Top of Cover Top of Grate
T T T.C T.G T or TL	Telephone Top of Cover Top of Grate Traverse Line
T T.C. T.G. T or TL T.M.	Telephone Top of Cover Top of Grate Traverse Line Top of Manhole
T T.C T.G T or TL T.M. TRAV	Telephone Top of Cover Top of Grate Traverse Line Top of Manhole Traverse
T T.C. T.G. T or TL T.M. TRAV. TS	Telephone Top of Cover Top of Grate Traverse Line Top of Manhole Traverse Temporary Swale
T T.C T.G T or TL T.M. TRAV. TS T.S.	Telephone Top of Cover Top of Grate Traverse Line Top of Manhole Traverse Temporary Swale Top of Slab
T T.C. T.G. T or TL T.M. TRAV. TS	Telephone Top of Cover Top of Grate Traverse Line Top of Manhole Traverse Temporary Swale Top of Slab
T T.C T.G T or TL T.M. TRAV. TS T.S.	Telephone Top of Cover Top of Grate Traverse Line Top of Manhole Traverse Temporary Swale Top of Slab Topsoil
T T.C T.G T or TL T.M. TRAV TS T.S. T.S. T.S. TYP.	Telephone Top of Cover Top of Grate Traverse Line Top of Manhole Traverse Temporary Swale Top of Slab Topsoil
T T.C. T.G. T or TL T.M. T.M. TRAV. TS T.S. T.S. T.S. T.S. TYP. U.D.	Telephone Top of Cover Top of Grate Traverse Line Top of Manhole Traverse Temporary Swale Top of Slab Topsoil Typical Under Drain
T T.C. T.G. T.G. T.Or TL T.M. TRAV. TS T.S. T.S. T.S. TYP. U.D. U.G.	Telephone Top of Cover Top of Grate Traverse Line Top of Manhole Traverse Temporary Swale Top of Slab Topsoil Topsoil Typical Under Drain Underground
T T.C. T.G. T.G. T or TL T.M. TRAV. TS T.S. T.S. T.S. T.S. TYP. U.D. U.D. U.G. U.P.	Telephone Top of Cover Top of Grate Traverse Line Top of Manhole Traverse Temporary Swale Top of Slab Topsoil Topsoil Typical Under Drain Underground Utility Pole
T T.C. T.G. T.G. T or TL T.M. TRAV. TS T.S. T.S. T.S. T.S. TYP. U.D. U.D. U.G. U.P.	Telephone Top of Cover Top of Grate Traverse Line Top of Manhole Traverse Temporary Swale Top of Slab Top of Slab Topsoil Typical Under Drain Underground Underground Utility Pole United States Department
T T T.C. T.G. T.G. T or TL T.M. TRAV. TS T.S. T.S. T.S. T.S. TYP. U.D. U.G. U.P. USDA	Telephone Top of Cover Top of Grate Traverse Line Top of Manhole Traverse Temporary Swale Top of Slab Topsoil Topsoil Under Drain Under ground Underground United States Department of Agriculture
T T T.C. T.G. T.G. T.G. T.M. T.M. TRAV. TS T.S. T.S. T.S. TYP. U.D. U.D. U.D. U.G. U.P. USDA	Telephone Top of Cover Top of Grate Traverse Line Top of Manhole Traverse Temporary Swale Top of Slab Top of Slab Topsoil Typical Under Drain Underground Underground Utility Pole United States Department of Agriculture Vertical Clearance
T T T.C. T.G. T or TL T.M. TRAV. TS T.S. T.S. TYP. U.D. U.G. U.P. USDA VCL V.C.L.	Telephone Top of Cover Top of Grate Traverse Line Top of Manhole Top of Manhole Traverse Temporary Swale Top of Slab Topsoil Topsoil Typical Under Drain Under ground Underground Utility Pole United States Department of Agriculture Vertical Clearance Vertical Curve Length
T T T.C. T.G. T or TL T.M. TRAV. TS T.S. T.S. TYP. U.D. U.D. U.G. U.P. USDA VCL V.C.L. W	Telephone Top of Cover Top of Grate Traverse Line Top of Manhole Top of Manhole Top of Manhole Top of Slab Topsoil Top of Slab Topsoil Topsoil Under Drain Under ground Underground United States Department of Agriculture Vertical Clearance Vertical Curve Length Water
T T T.C. T.G. T or TL T.M. TRAV. TS T.S. T.S. TYP. U.D. U.D. U.G. U.P. USDA VCL V.C.L. W W	Telephone Top of Cover Top of Grate Traverse Line Top of Manhole Top of Manhole Traverse Temporary Swale Top of Slab Topsoil Topsoil Topsoil Under Drain Under ground Underground United States Department of Agriculture Vertical Clearance Vertical Curve Length Water West
T T T.C. T.G. T or TL T.M. TRAV. TS T.S. T.S. TYP. U.D. U.D. U.G. U.P. USDA VCL V.C.L. W WB	Telephone Top of Cover Top of Grate Traverse Line Top of Manhole Top of Manhole Traverse Temporary Swale Top of Slab Top of Slab Topsoil Typical Under Drain Underground Underground Utility Pole United States Department of Agriculture Vertical Clearance Vertical Clearance Vertical Curve Length Water West West
T T T.C. T.G. T or TL T.M. TRAV. TS T.S. T.S. TYP. U.D. U.D. U.G. U.P. USDA VCL V.C.L. W WB	Telephone Top of Cover Top of Grate Traverse Line Top of Manhole Top of Manhole Traverse Temporary Swale Top of Slab Topsoil Topsoil Topsoil Under Drain Under ground Underground United States Department of Agriculture Vertical Clearance Vertical Curve Length Water West
T T T.C. T.G. T.G. T or TL T.M. TRAV. TS T.S. T.S. TYP. U.D. U.D. U.G. U.P. USDA VCL V.C.L. W WB WB	Telephone Top of Cover Top of Grate Traverse Line Top of Manhole Top of Manhole Traverse Temporary Swale Top of Slab Top of Slab Topsoil Typical Under Drain Underground Underground Utility Pole United States Department of Agriculture Vertical Clearance Vertical Clearance Vertical Curve Length Water West West
T T T.C. T.G. T or TL T.M. TRAV. TS T.S. T.S. TYP. U.D. U.D. U.D. U.G. U.P. USDA VCL V.C.L. W WB WB WB. W.M.	Telephone Top of Cover Top of Grate Traverse Line Top of Manhole Traverse Temporary Swale Top of Slab Top of Slab Topsoil Typical Under Drain Underground Underground United States Department of Agriculture Vertical Clearance Vertical Clearance Vertical Curve Length Water West West West West Westbound Wetland Buffer Water Meter
T T T.C. T.G. T or TL T.M. TRAV. TS T.S. T.S. T.S. TYP. U.D. U.D. U.D. U.G. U.P. USDA VCL V.C.L. W W WB WB W.M. W.S.	Telephone Top of Cover Top of Grate Traverse Line Top of Manhole Traverse Temporary Swale Top of Slab Topsoil Topsoil Typical Under Drain Under Drain Underground Utility Pole United States Department of Agriculture Vertical Clearance Vertical Clearance Vertical Curve Length Water West West West Westbound Wetland Buffer Water Meter Wrapped Steel
T T T.C T.G T or TL T.M TRAV TS T.S TYP U.D U.D U.G U.SDA VCL V.C.L W W WB WB W.S WUS	Telephone Top of Cover Top of Grate Traverse Line Top of Manhole Traverse Temporary Swale Top of Slab Top of Slab Topsoil Typical Under Drain Underground Underground United States Department of Agriculture Vertical Clearance Vertical Clearance Vertical Curve Length Water West West West West Westbound Wetland Buffer Water Meter

LEGEND

PROPOSED PIPE / CULVERT EXISTING PIPE / CULVERT EXISTING DROP INLET UTILITY POLE	
WETLAND	
WETLAND BUFFER ·····	
WATERS OF THE U.S	, WUS
HEDGE /TREE LINE ····· BUSH /TREE	$\overline{\bigcirc}$
CONIFEROUS TREE	N. W.
GROUND ELEVATION	OP MC DATUM LINE
GRADE ELEVATION	DATUM LINE
ROADWAY BORING PLAN LOCATION	G C-1
UTILITY TEST HOLE LOCATION	TP -'

THE EXISTING UTILITIES AND OBSTRUCTIONS SHOWN ON THESE PLANS ARE FROM THE BEST AVAILABLE RECORDS AND SHALL BE VERIFIED BY THE CONTRACTOR PRIOR TO CONSTRUCTION. THE CONTRACTOR SHALL NOTIFY ALL UTILITY OWNERS CONCERNED AND MISS UTILITY PRIOR TO CONSTRUCTION ACTIVITIES. THE CONTRACTOR SHALL CALL "MISS

THE CONTRACTOR IS RESPONSIBLE TO ENSURE THAT THE SAFETY OF THE PUBLIC AND ALL WORKERS IS MAINTAINED AT ALL TIMES THROUGHOUT THE TERM OF THE CONTRACT. MOTORISTS SHALL BE GUIDED IN A CLEAR AND POSITIVE MANNER WHILE APPROACHING AND PASSING THROUGH CONSTRUCTION WORK AND EQUIPMENT AREAS. HORIZONTAL CONTROL: THE LOCATION AND ELEVATION OF BENCH MARKS ARE SHOWN ON THE PLANS. ALL ELEVATIONS ARE IN FEET AND ARE BASED ON THE NAVD 88. WHERE REFERENCE IS MADE TO MDOT SHA STANDARD PLATES IT SHALL BE THE CONTRACTOR'S RESPONSIBILITY TO HAVE IN HIS POSSESSION THE LATEST UP-TO-DATE

REPAIRS TO UTILITIES OR PROPERTY DAMAGE AS A RESULT OF CONTRACTOR'S NEGLIGENCE OR METHOD OF OPERATION SHALL BE MADE AT NO ADDITIONAL COST TO THE CITY,

8. MATERIAL REMOVED DURING CONSTRUCTION SHALL BECOME THE CONTRACTOR'S PROPERTY UNLESS OTHERWISE NOTED ON THE PLANS OR IN THE SPECIAL PROVISIONS. THE CONTRACTOR SHALL RESET ANY SIGN POSTS OR MAIL BOXES TO FACILITATE THE WORK, EXCEPT WHERE SPECIFIED ON THE PLANS OR AS DIRECTED BY THE ENGINEER. FINAL DETERMINATION AS TO THE LOCATION OF EROSION AND SEDIMENT CONTROLS WILL BE AT THE DIRECTION OF THE ENGINEER WHO RESERVES THE RIGHT TO ORDER

CONSTRUCTION EQUIPMENT SHALL HAVE TREADS/TIRES CLEANED PRIOR TO LEAVING THE LOD. ALL MATERIAL REMOVAL/LOAD OUT SHALL BE LIFTED FROM THE LOD. ALL SEDIMENT

AB--01

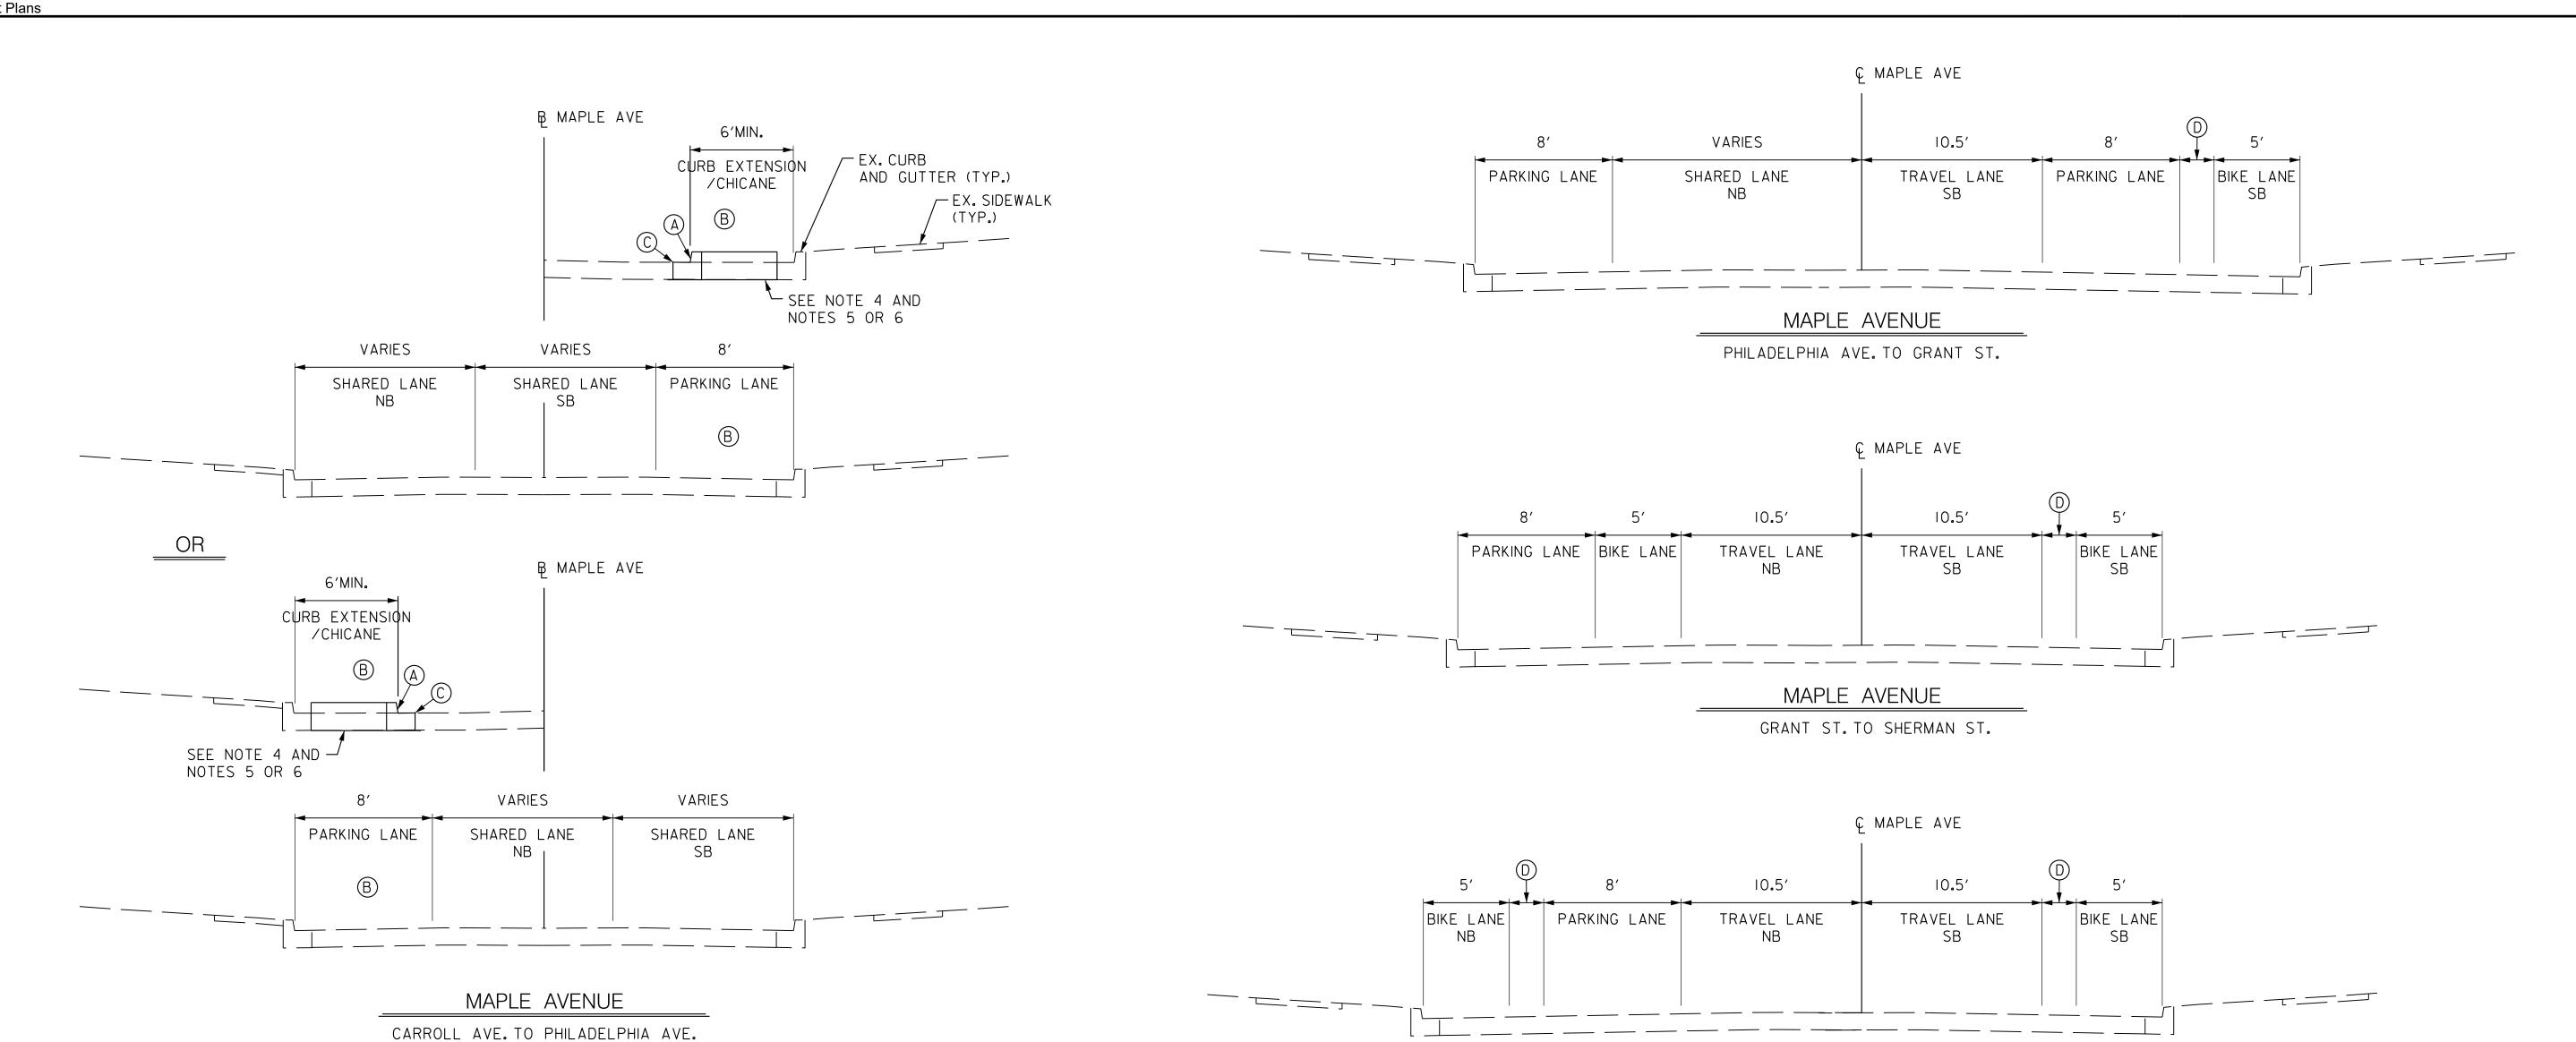
CITY OF TAKOMA PARK MAPLE AVENUE CONNECTIVITY PROJECT FROM CARROLL AVENUE TO HILLTOP ROAD / SLIGO CREEK PARKWAY

ABBREVIA	TIONS, LE	GE	ND	&	GENERAL	NOTES
SCALE <u>N.T.S.</u>	ADVERTISED DA	TE <u>N</u>	/IAY 202	<u>24</u> (CONTRACT NO	T.B.D.
DESIGNED BY DRAWN BY CHECKED BY MDE/PRD	OFG /RJG				MONTGOM	
TS NO.	DRAWING	1	OF	1	SHEET NO.	2 OF 15

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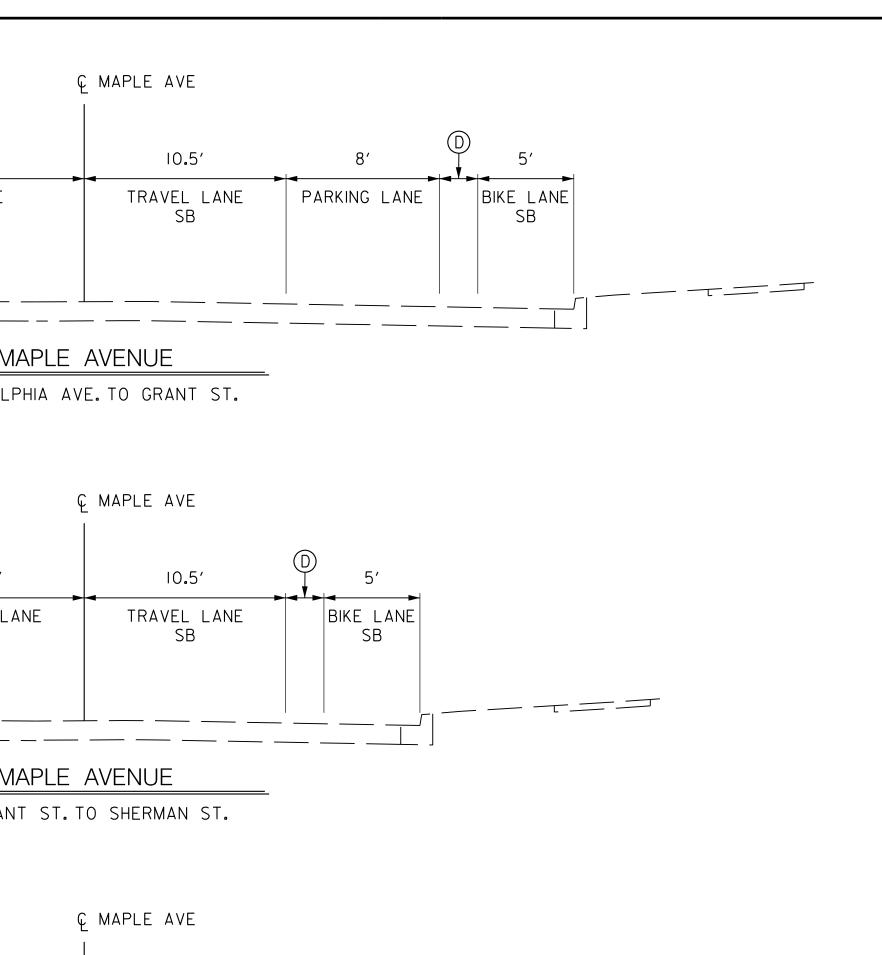


NOTES

- I. EXISTING CURB AND GUTTER TO REMAIN UNLESS OTHERWISE NOTED ON THE PLANS.
- 2. SAW CUTS ARE INCIDENTAL TO THE EXCAVATION OR PAVING ITEMS.
- 3. ALL ROADWAY EXCAVATION SHALL BE DEFINED AS CLASS I REGARDLESS OF THE WIDTH OF THE EXCAVATION.
- 4. LIMIT OF CLASS I EXCAVATION AND TOP OF SUBGRADE.
- EXCAVATE TO THE TOP OF EXISTING SUBGRADE. BACKFILL WITH COMMON 5. BORROW TO BOTTOM OF CONCRETE SIDEWALK.
- 6. EXCAVATE TO THE TOP OF EXISTING SUBGRADE.BACKFILL WITH FURNISHED SUBSOIL TO 4" BELOW PROPOSED GRADE. PLACE 4" FURNISHED TOPSOIL TO PROPOSED GRADE. PROVIDE TURFGRASS SOD ESTABLISHMENT.
- 7. ALL CONCRETE CURB AND GUTTER WILL BE PAID FOR AS STANDARD TYPE A COMBINATION CURB & GUTTER, ANY HEIGHT OR DEPTH.
- 8. NEW COMBINATION CURB AND GUTTER PLACEMENT ALONG EXISTING PAVEMENT USE STANDARD No. MD 580.03.

а 1	P: 410.728.2900 700 E. Pratt Street, Suite 500 Baltimore, MD 21202	I HEREBY CERTIFY THAT THESE DOCUMENTS WERE PREPARED OR APPROVED BY ME, AND THAT I AM A DULY LICENSED PROFESSIONAL ENGINEER UNDER THE LAWS OF THE STATE OF MARYLAND.	30% DI NOT I
ogarcia	Engineers Construction Managers Planners Scientists www.rkk.com	MD LICENSE NUMBER	
BΥ: (Responsive People Creative Solutions	EXPIRATION DATE	

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MAPLE AVENUE

SHERMAN ST. TO HILLTOP RD.



TYPICAL SECTION LEGEND

- (A) COMBINATION CURB & GUTTER MDOT SHA TYPE B
- (B) SEE PLANS FOR LOCATIONS AND TREATMENTS
- © FULL DEPTH PAVEMENT SAW CUT SEE NOTE 8
- (D) PROTECTED BIKE LANE BUFFER 2' WIDE MIN.

TS-01

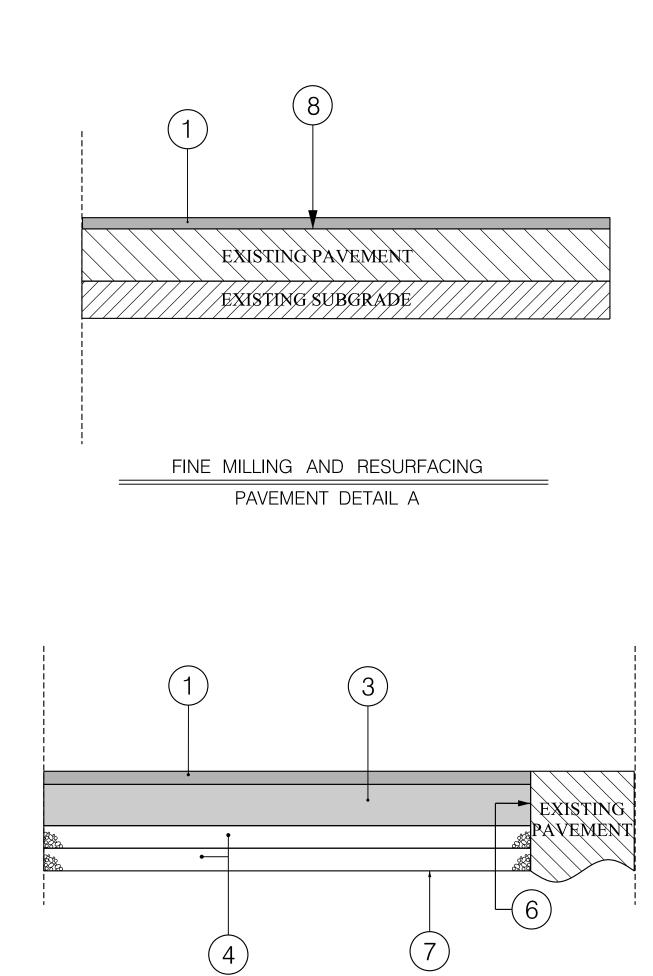
CITY OF TAKOMA PARK MAPLE AVENUE CONNECTIVITY PROJECT FROM CARROLL AVENUE TO HILLTOP ROAD / SLIGO CREEK PARKWAY

TYPICAL SECTIONS					
SCALE <u>N.T.S.</u>	ADVERTISED DATE	MAY 2024 (CONTRACT NO	T.B.D.	
DRAWN BY	OFG RJP OFG /RJG		MONTGC		
TS NO.	DRAWING 1	OF 1	SHEET NO.	3 OF 15	

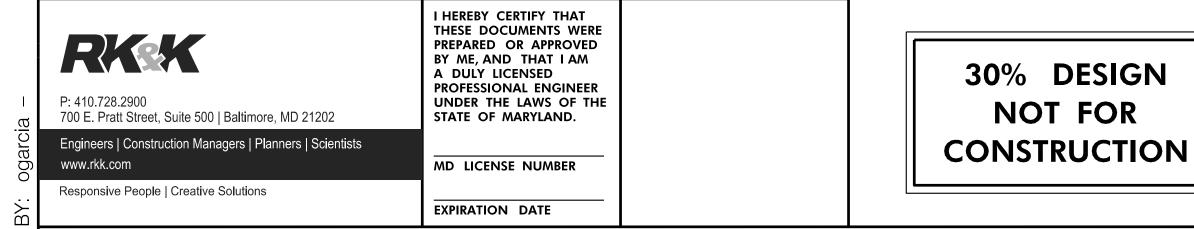
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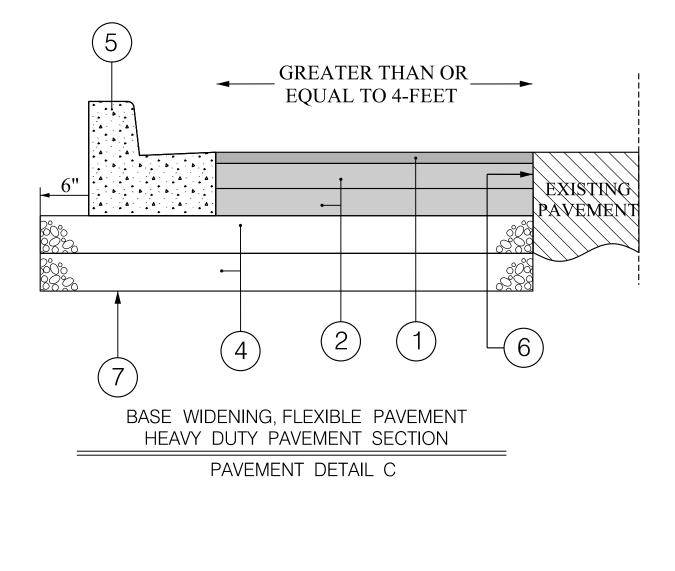
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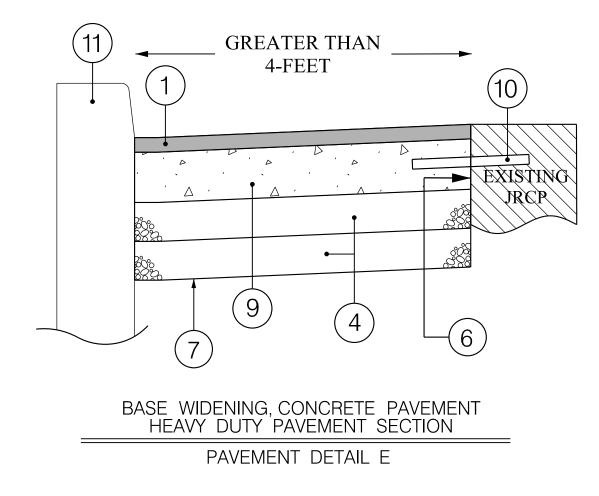


ASPHALT SECTION FOR FRONTAGE ROAD PAVEMENT DETAIL B



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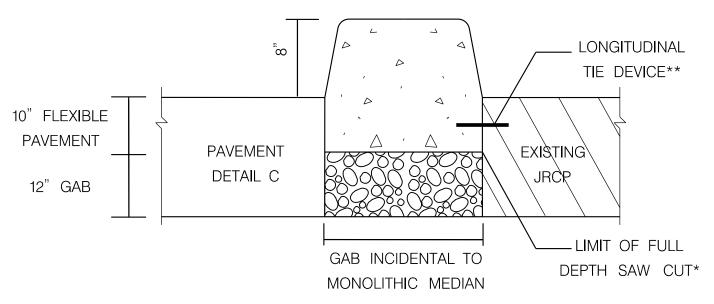


PAVEMENT LEGEND

- (1) 2" SUPERPAVE ASPHALT MIX 12.5 mm FOR SURFACE, HDFV, PG64S-22, LEVEL 2
- (2) 4" SUPERPAVE ASPHALT MIX 19.0 mm FOR BASE, PG 64S-22, LEVEL 2
- (3) 3" SUPERPAVE ASPHALT MIX 19.0 mm FOR BASE, PG 64S-22, LEVEL 2
- (4) 6" GRADED AGGREGATE BASE COURSE
- (5) MDOT SHA STANDARD TYPE A COMBINATION CURB AND GUTTER OR CAST-IN-PLACE RETAINING WALL (SEE PLANS)
- 6 FULL-DEPTH SAW CUT INCIDENTAL TO FULL-DEPTH PAVING, CURB AND GUTTER AND EXCAVATION ITEMS
- (7) TOP OF SUBGRADE AND LIMIT OF EXCAVATION (SEE NOTE 2)
- (8) TOP OF EXISTING PAVEMENT AFTER 2" FINE MILLING
- (9) 9" PLAIN PORTLAND CEMENT CONCRETE MIX NO.7
- (1) LONGITUDINAL TIE DEVICE. SEE NOTE 9
- (11) CAST-IN-PLACE RETAINING WALL, MONOLITHIC MEDIAN, OR MOOT SHA STANDARD TYPE B CURB (SEE PLANS)

PAVEMENT DETAIL NOTES

- 1. REMOVE AND DISPOSE OF ALL SOFT AND UNSTABLE MATERIAL PER SECTION 208 OF THE MDOT SHA STANDARD SPECIFICATIONS FOR CONSTRUCTION AND MATERIALS.
- 2. IN AREAS WHERE EXISTING PAVEMENT IS BEING REMOVED, THE LIMIT OF EXCAVATION SHALL BE AT THE BOTTOM OF THE BOUND MATERIALS IN THE EXISTING PAVEMENT OR AT THE TOP OF SUBGRADE, WHICHEVER IS LOWER.
- 3. REFER TO MDOT SHA STD. NO. 580.03 FOR NEW CURB AND GUTTER PLACEMENT ALONG EXISTING PAVEMENT.



- * INCIDENTAL TO MONOLITHIC MEDIAN AND EXCAVATION PAY ITEMS
- ** LONGITUDINAL TIE DEVICES SHALL BE PROVIDED ON THE SOUTHBOUND MD 650 SIDE ONLY. FOLLOWING MDOT SHA STD. NO. 572.61-01. TIE DEVICES SHALL BE STEEL DOWELS 1.5" x 18", 1' ON CENTER. PLACE DOWELS ALONG THE PERIMETER OF THE NEW CONSTRUCTION AND ALONG ANY EXISTING TRANSVERSE PAVEMENT JOINT.

MONOLITHIC CONCRETE MEDIAN TYPE A-2 (MODIFIED MD STD. 645.01)	
N.T.S.	

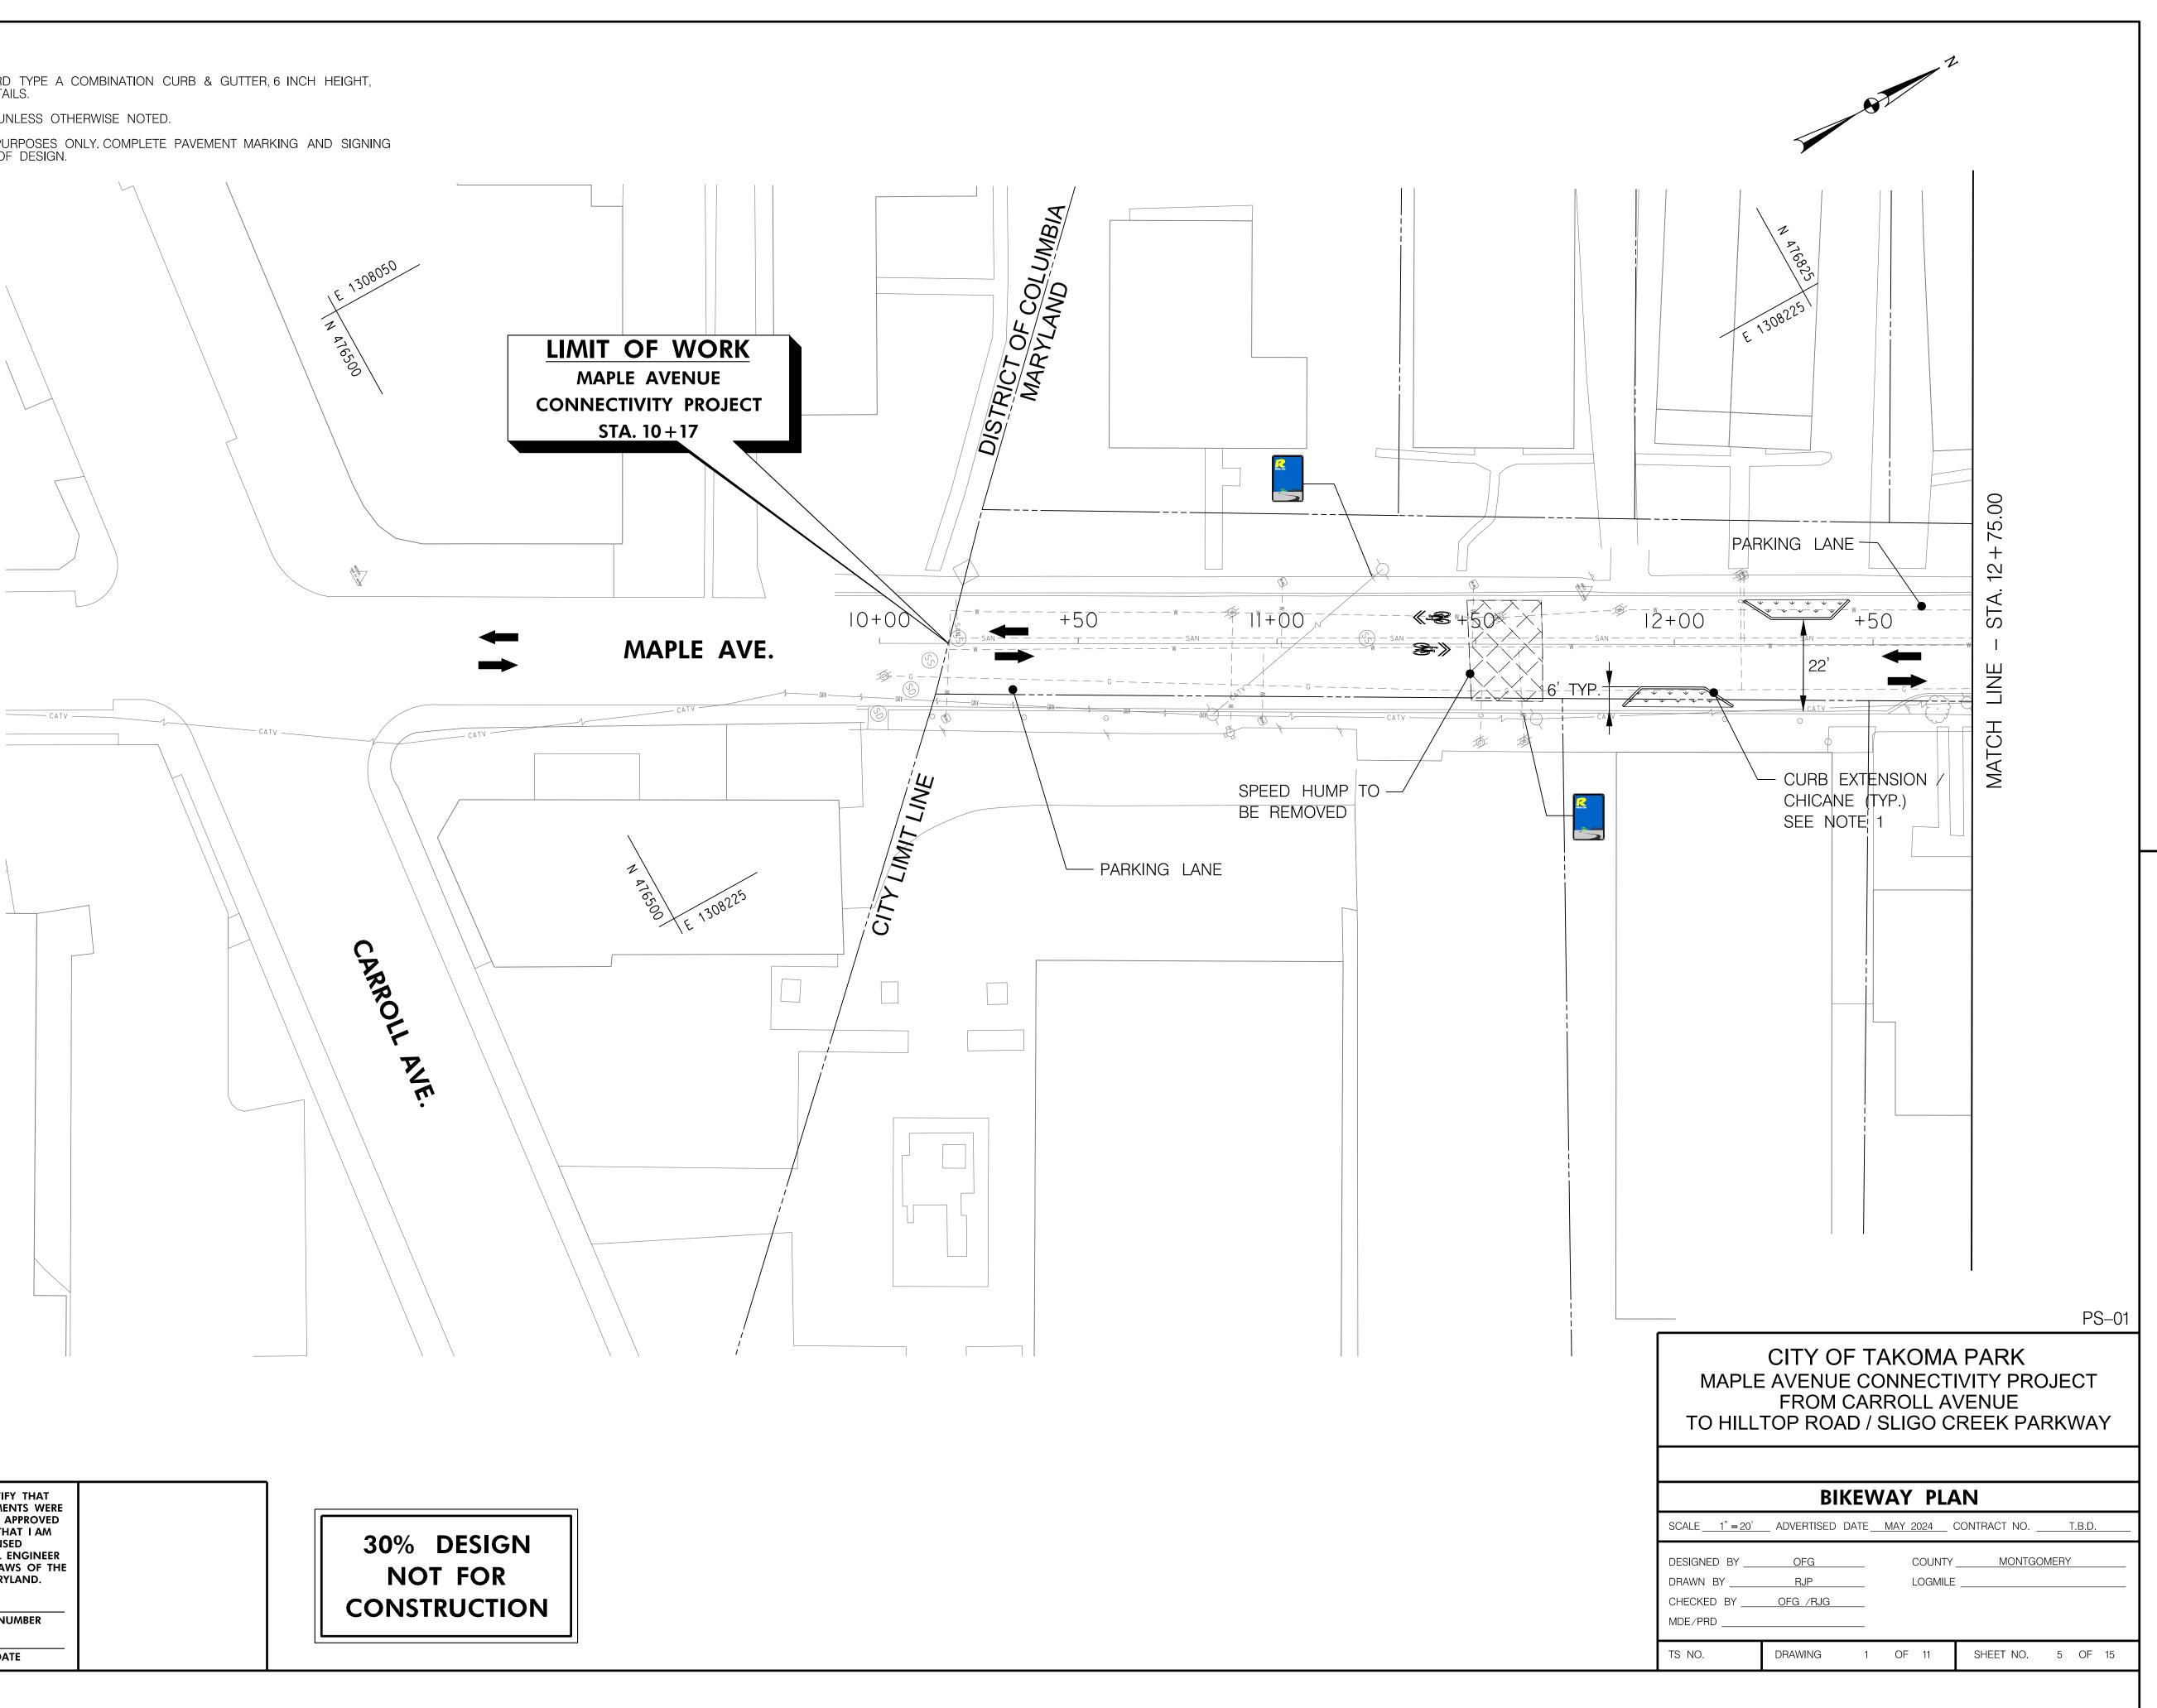
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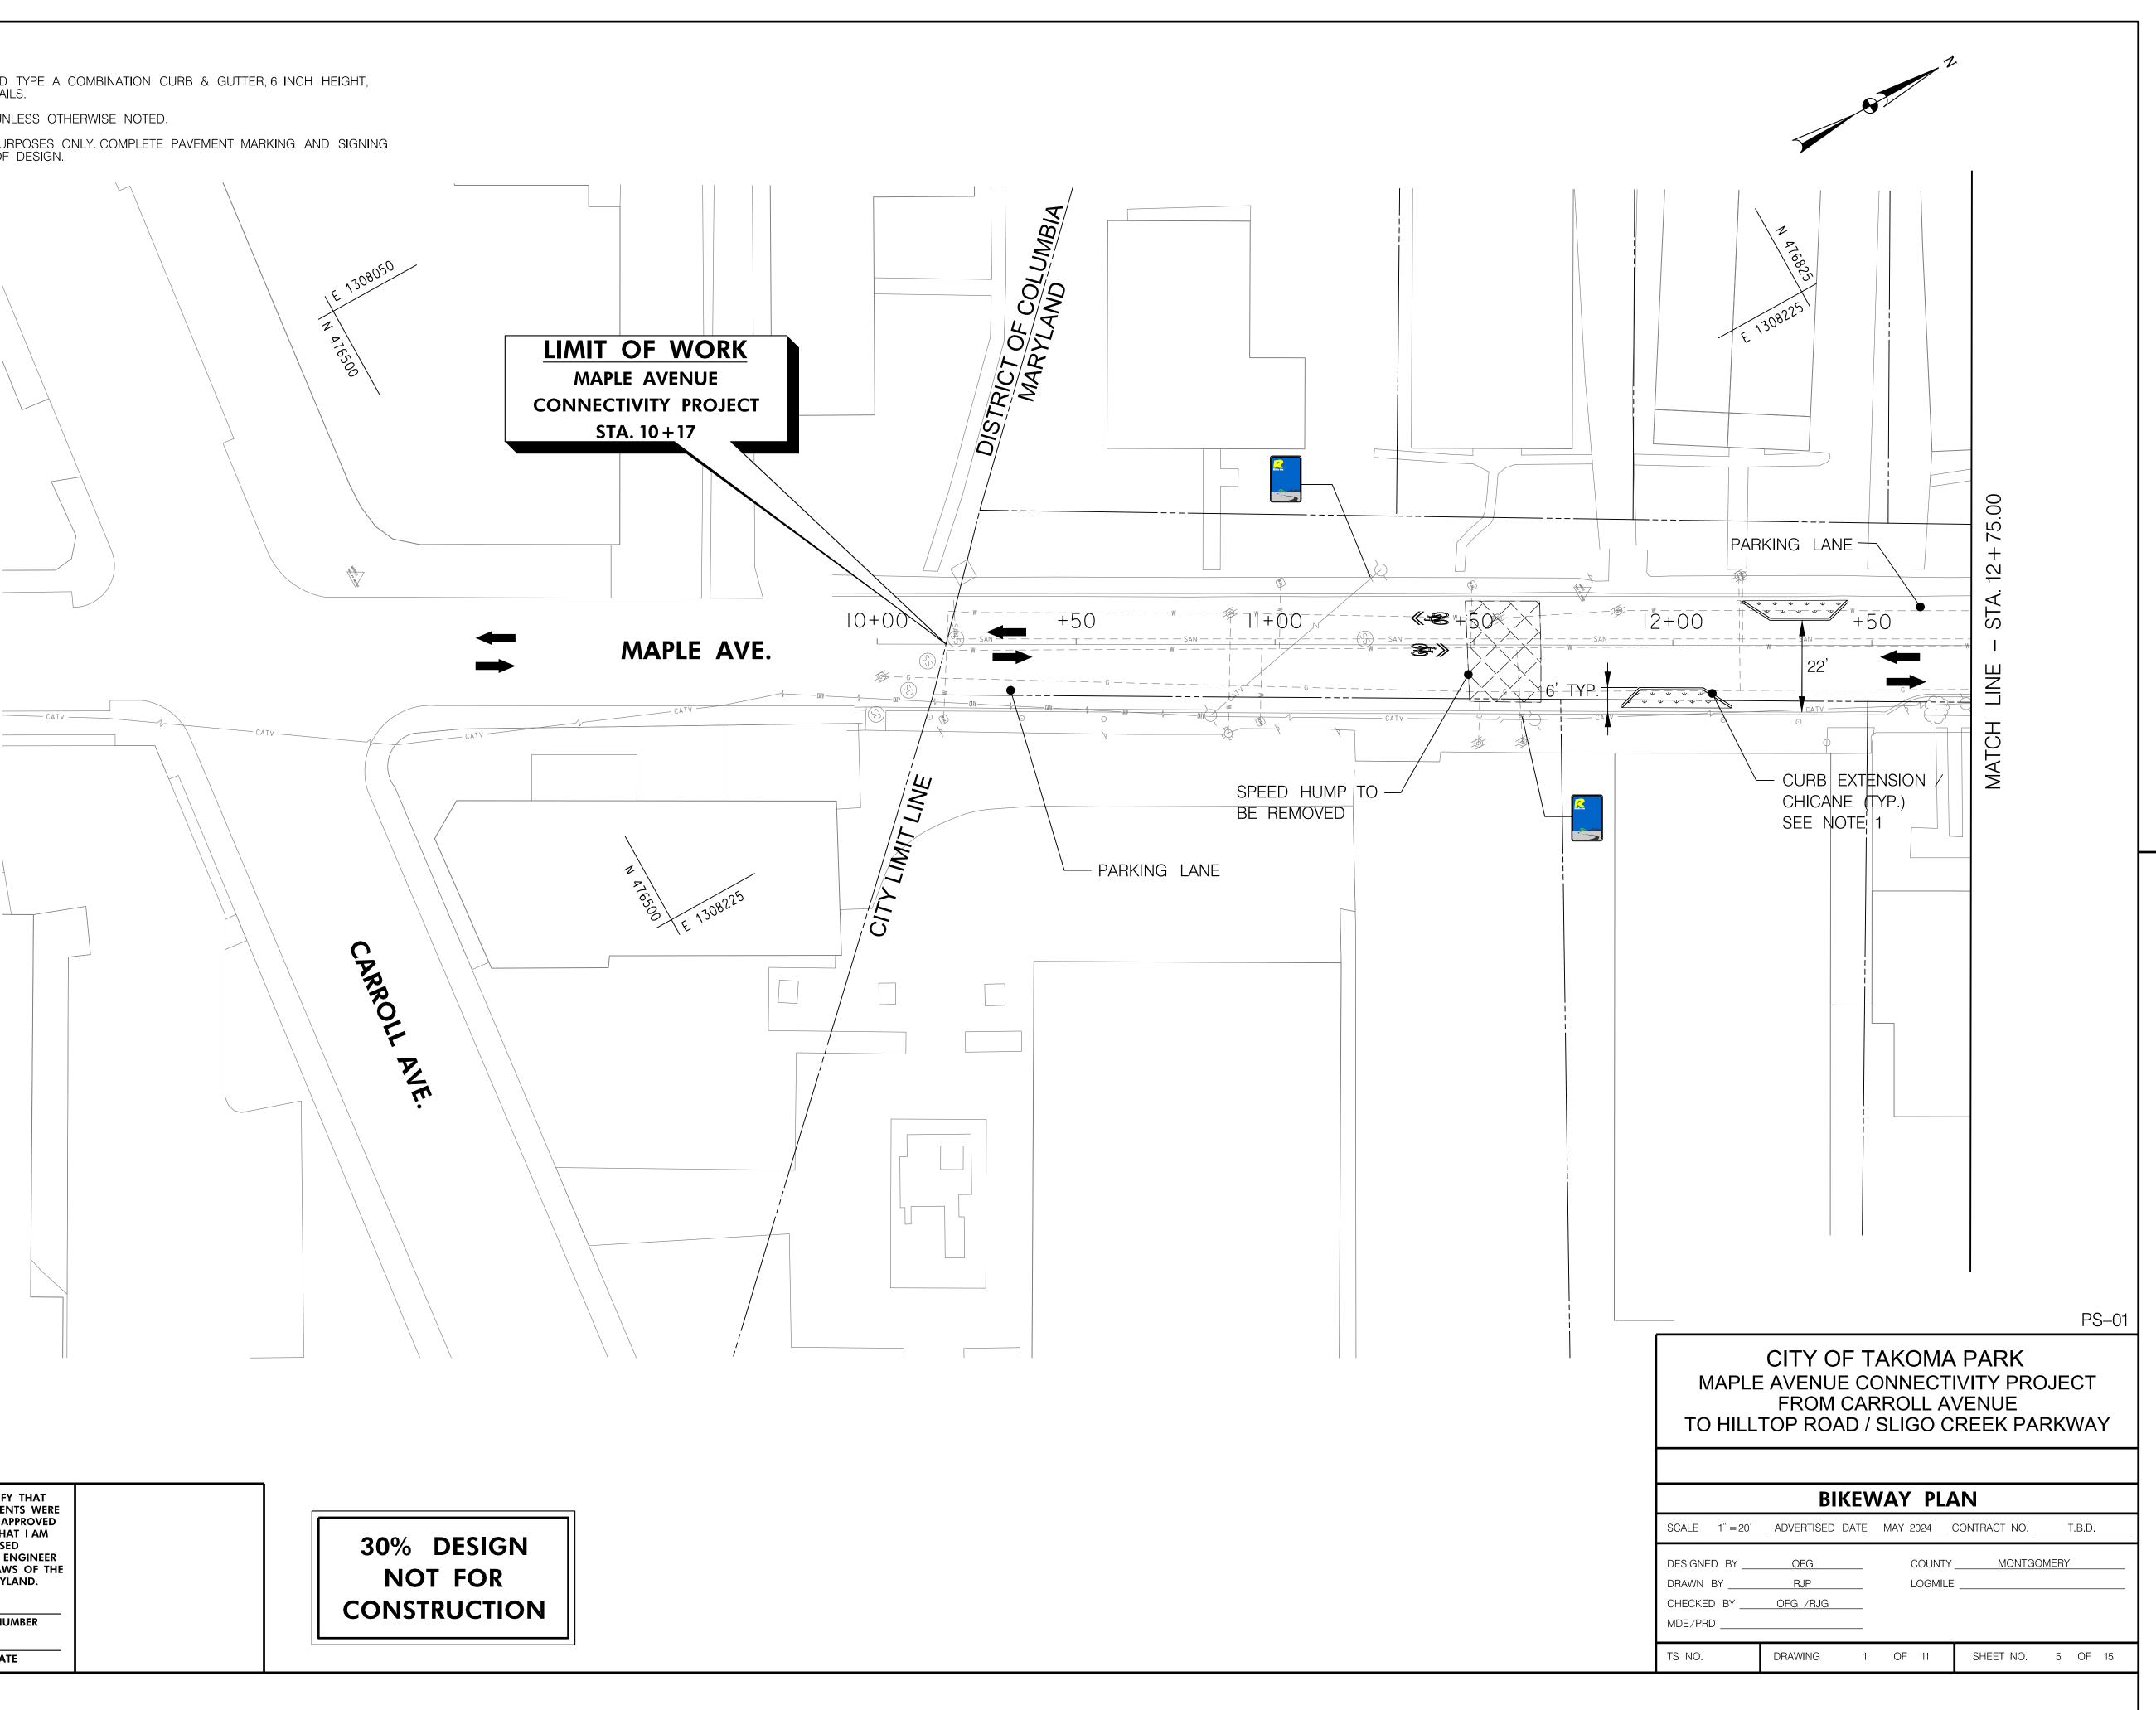
CITY OF TAKOMA PARK MAPLE AVENUE CONNECTIVITY PROJECT FROM CARROLL AVENUE TO HILLTOP ROAD / SLIGO CREEK PARKWAY							
PAVEMENT DETAILS							
SCALE <u>N.T.S</u>	ADVERTISED DATE	E <u>MAY 2024</u>	CONTRACT NO. <u>T.B.D.</u>				
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TS NO.	DRAWING	1 OF 1	SHEET NO. 4 OF 15				
1 OF 9							

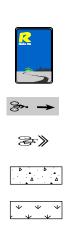
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- 2. ALL BUS STOPS WILL REMAIN AT EXISTING LOCATION UNLESS OTHERWISE NOTED.
- 3. PAVEMENT MARKINGS ARE SHOWN FOR CONTEXTUAL PURPOSES ONLY COMPLETE PAVEMENT MARKING AND SIGNING PLAN WILL BE INCLUDED WITH SUBSEQUENT PHASES OF DESIGN.







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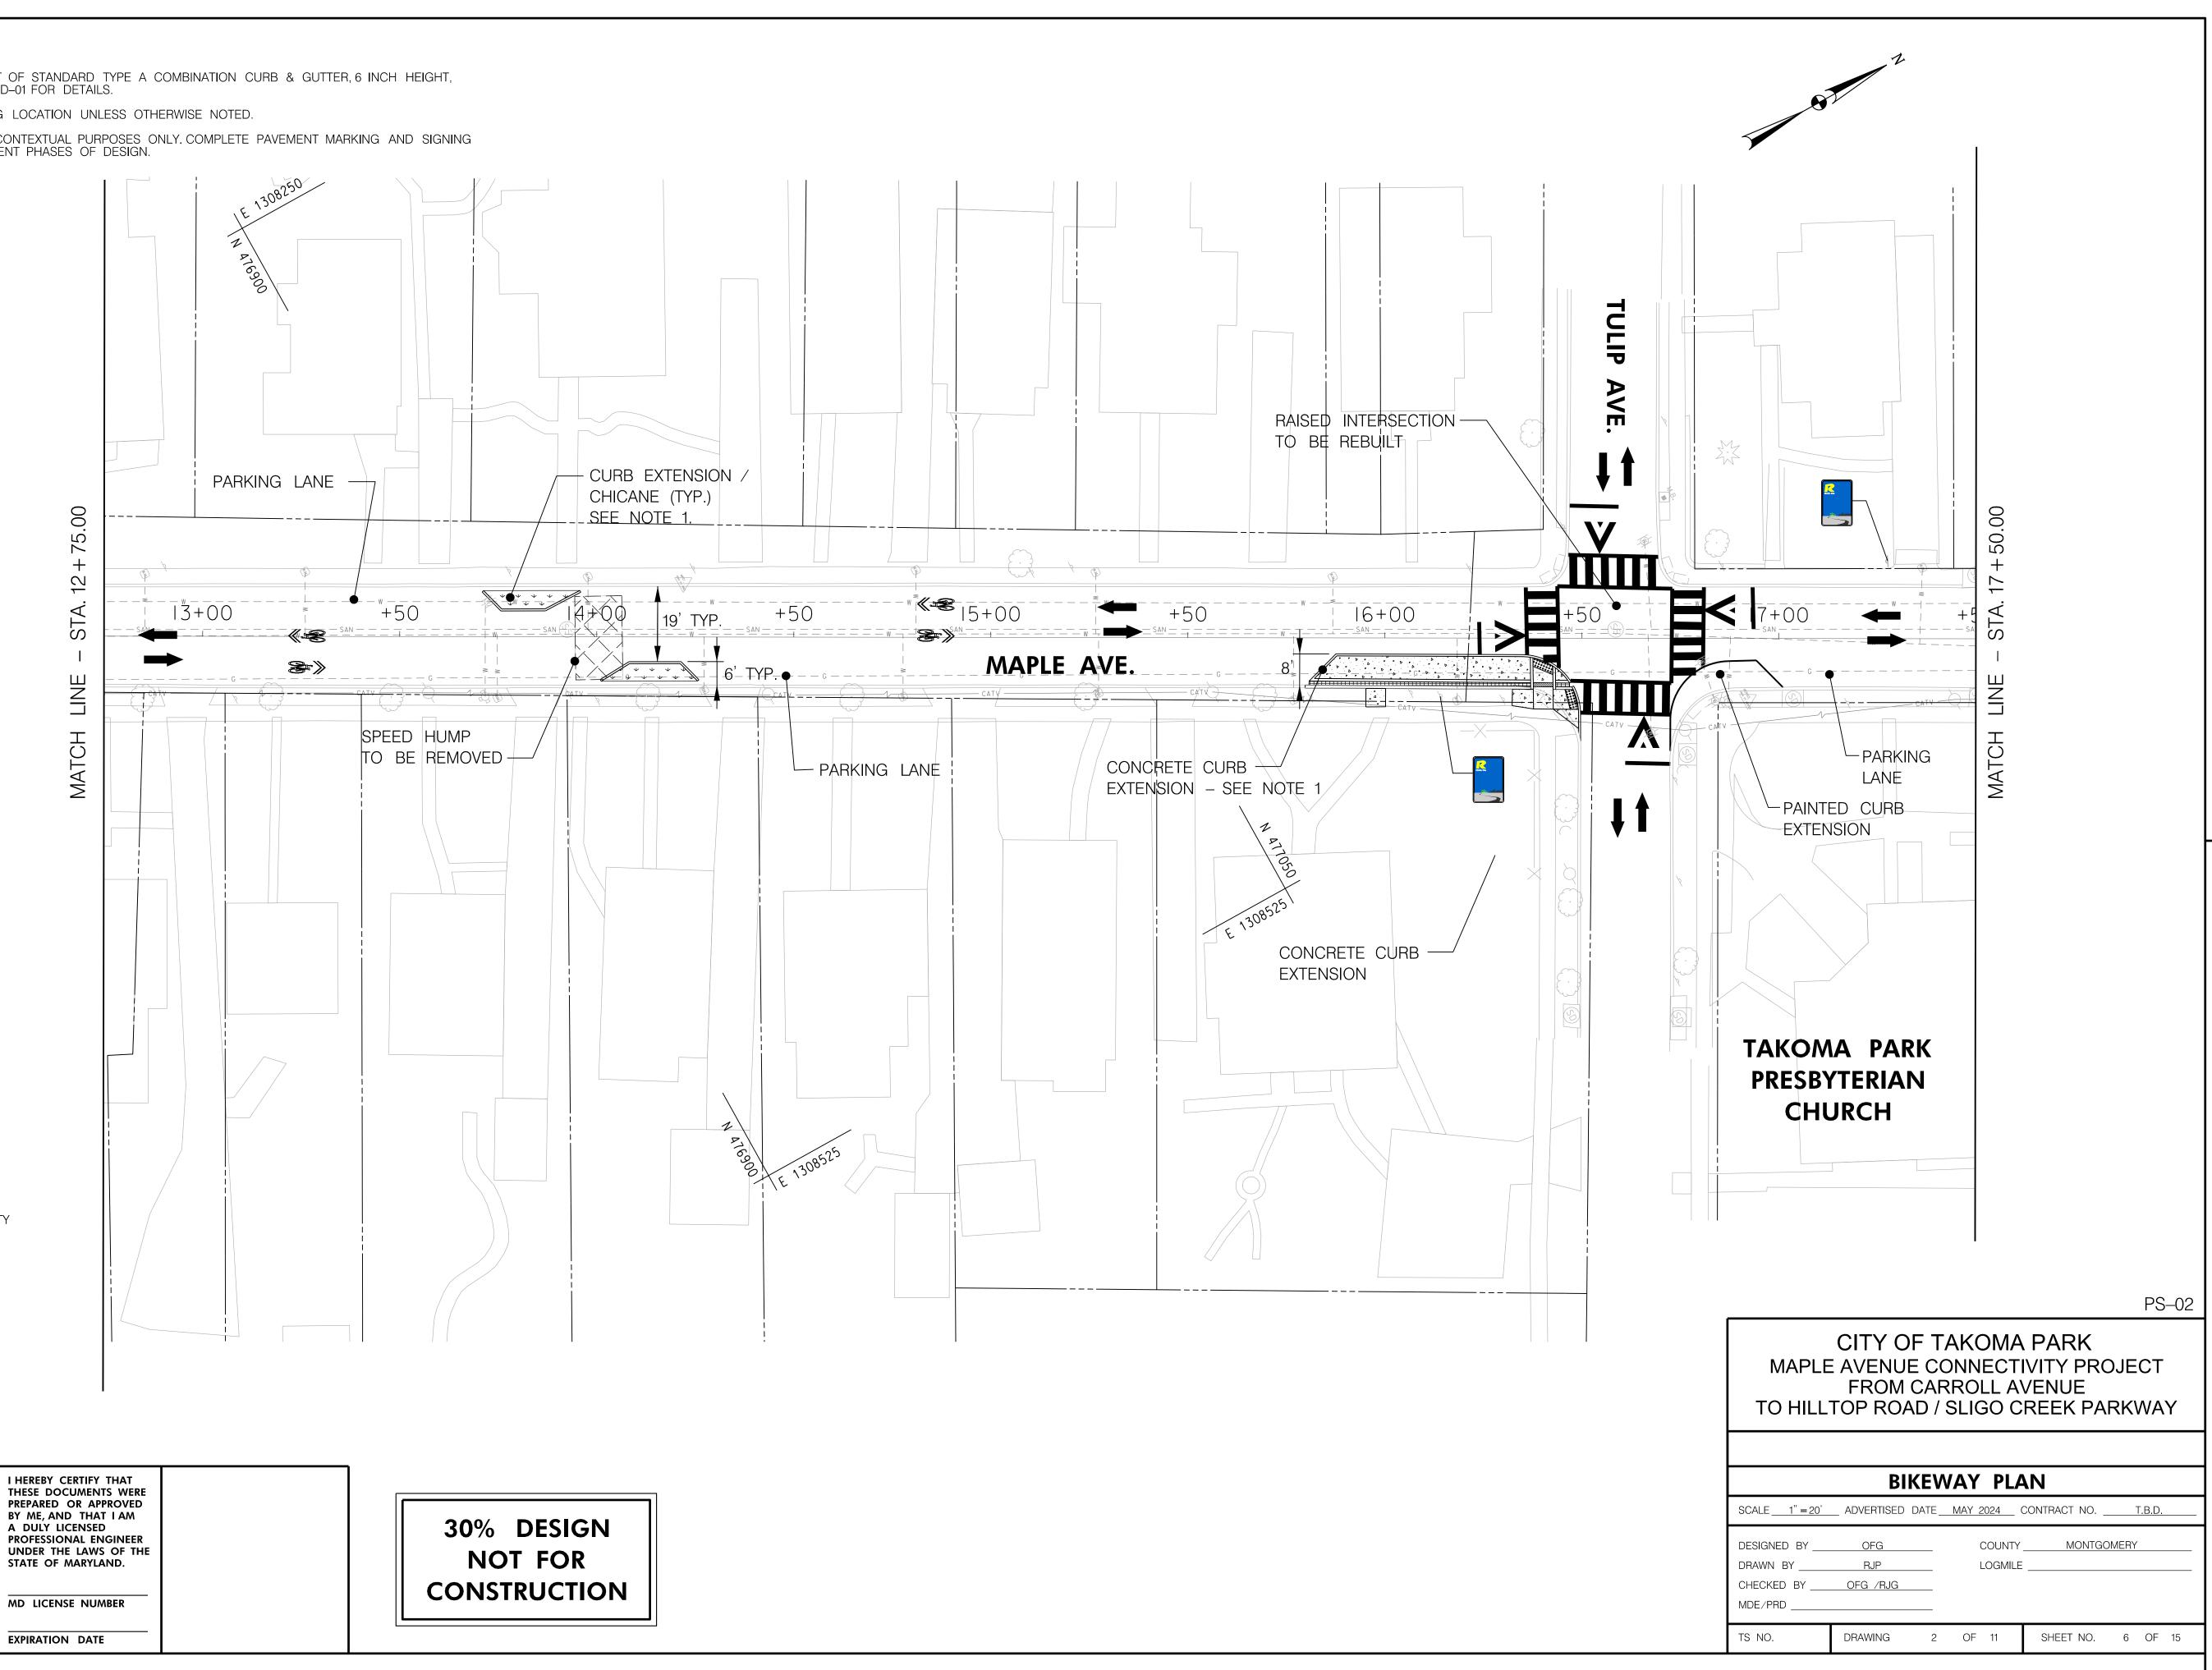
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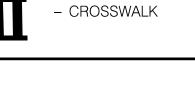
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 - PLANTED /GRASS AREA
 - TO BE REMOVED
 - DIRECTION OF TRAFFIC

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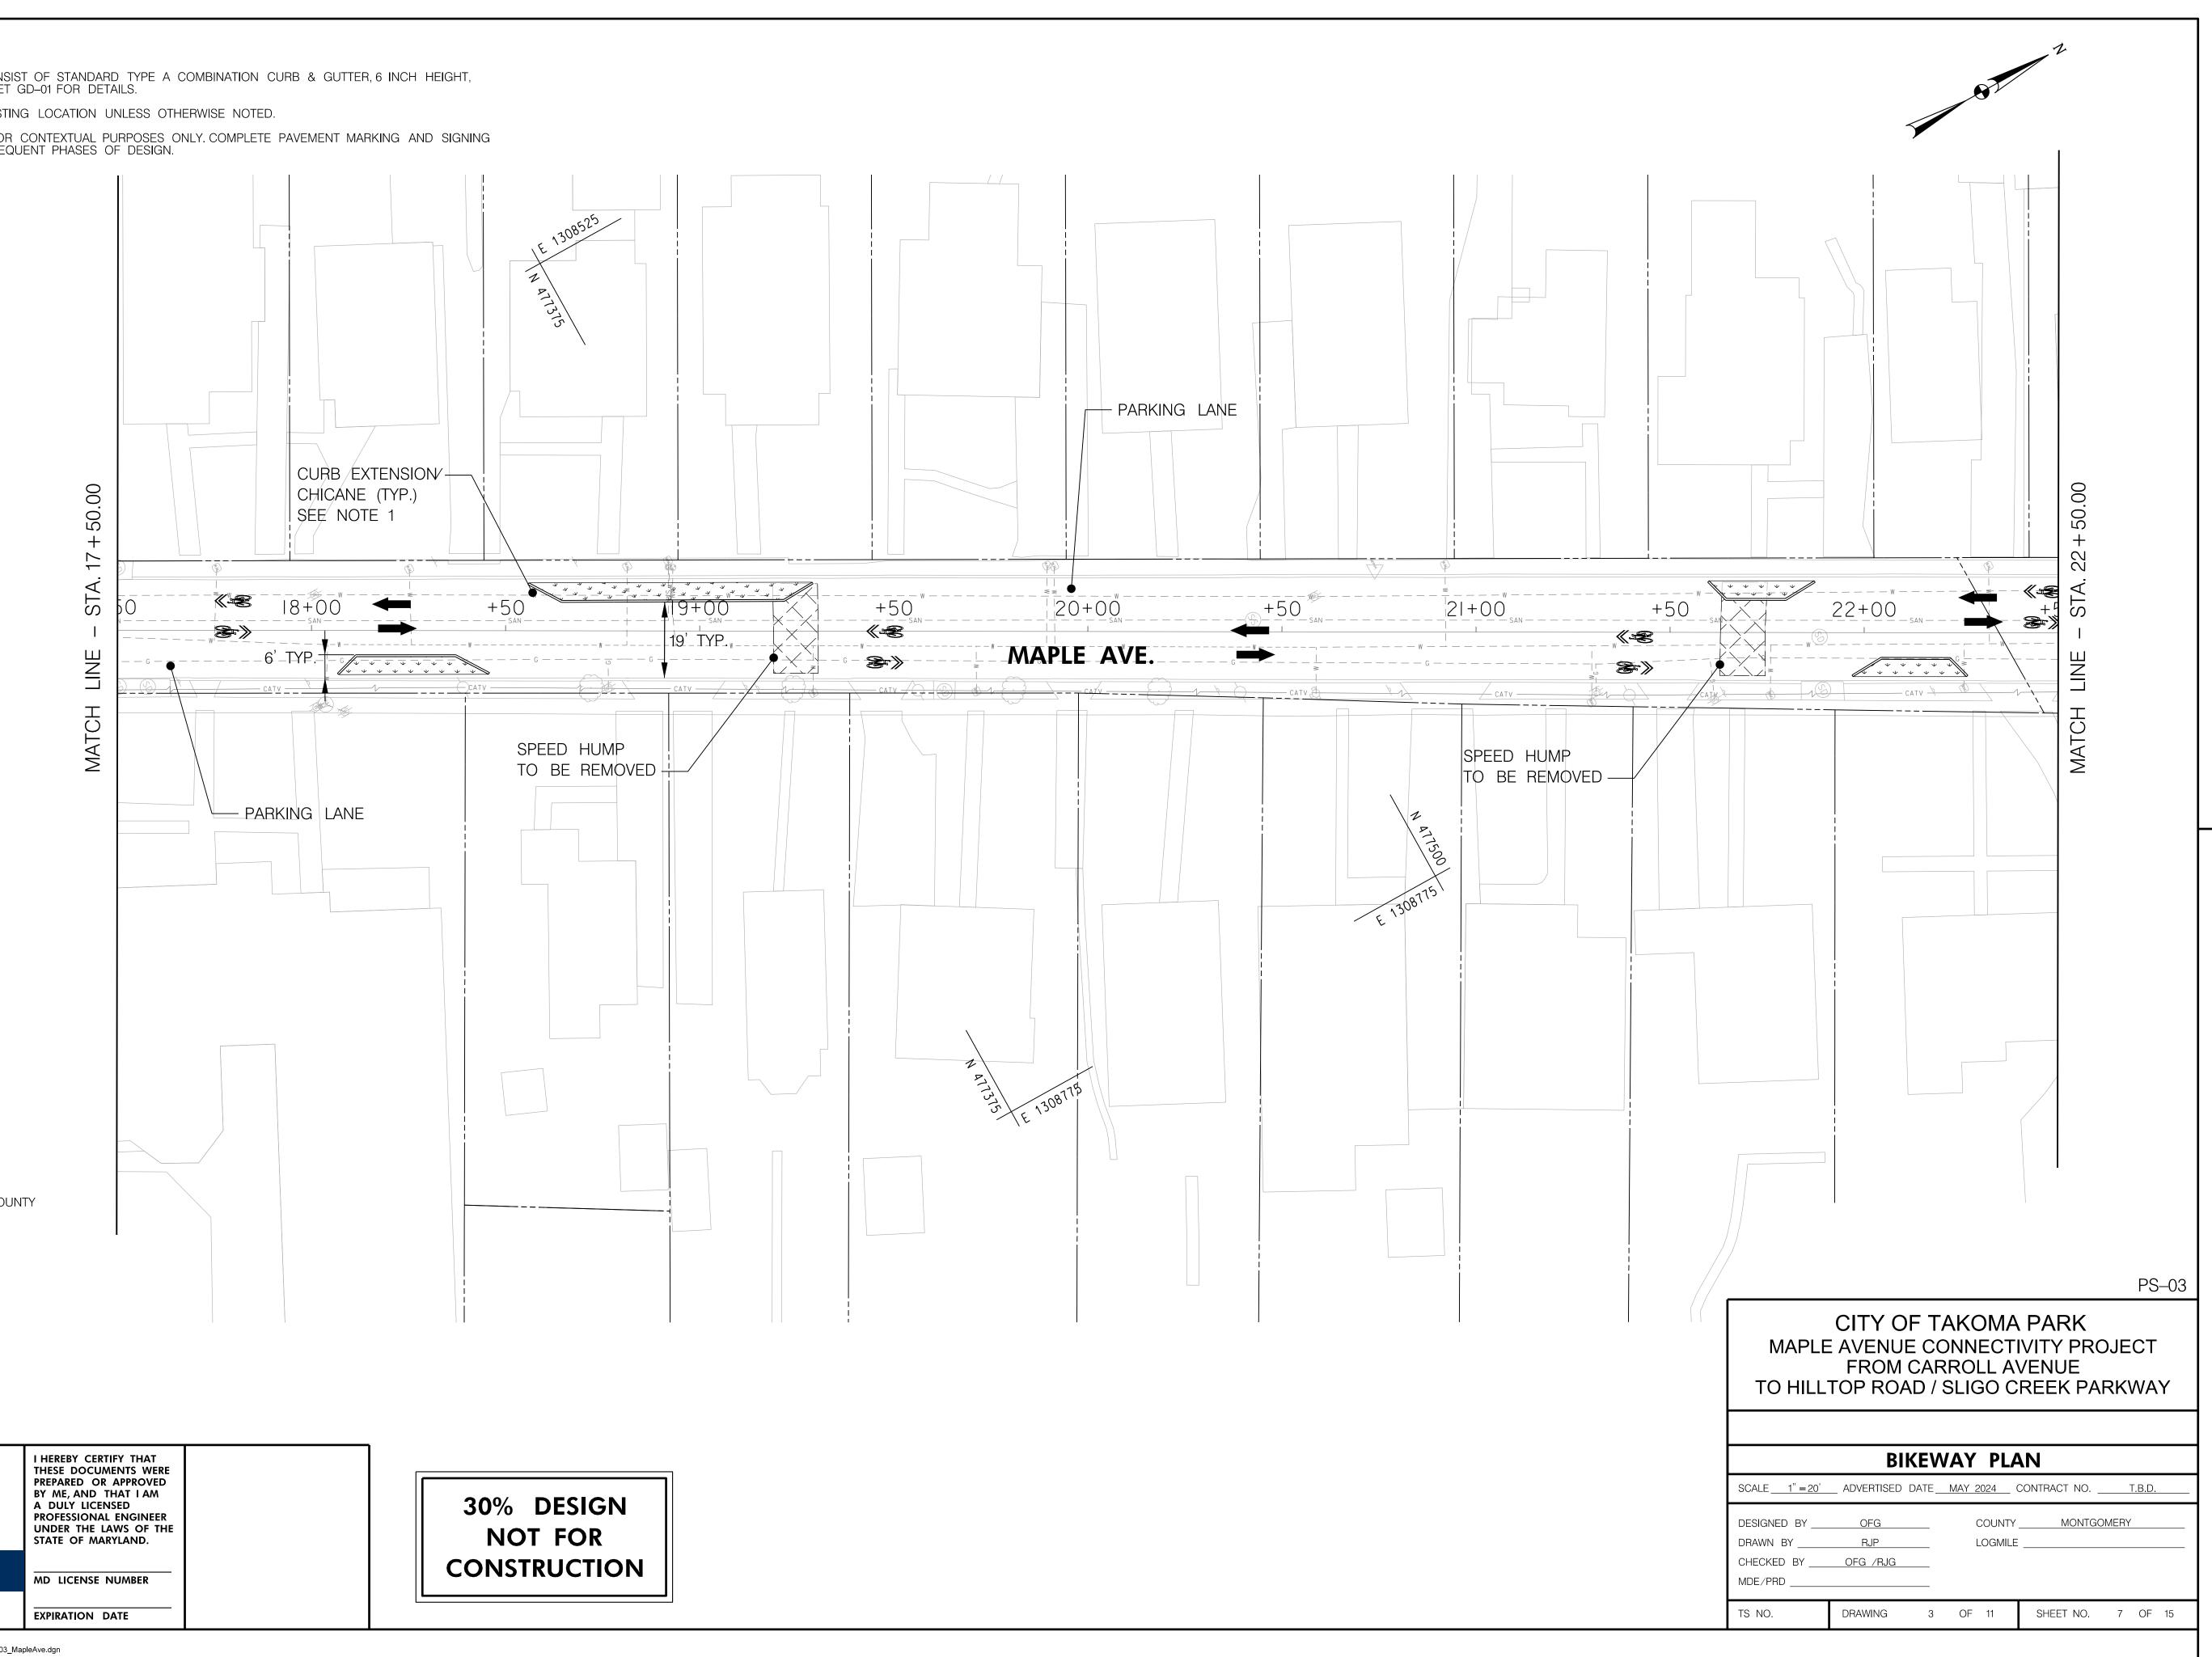


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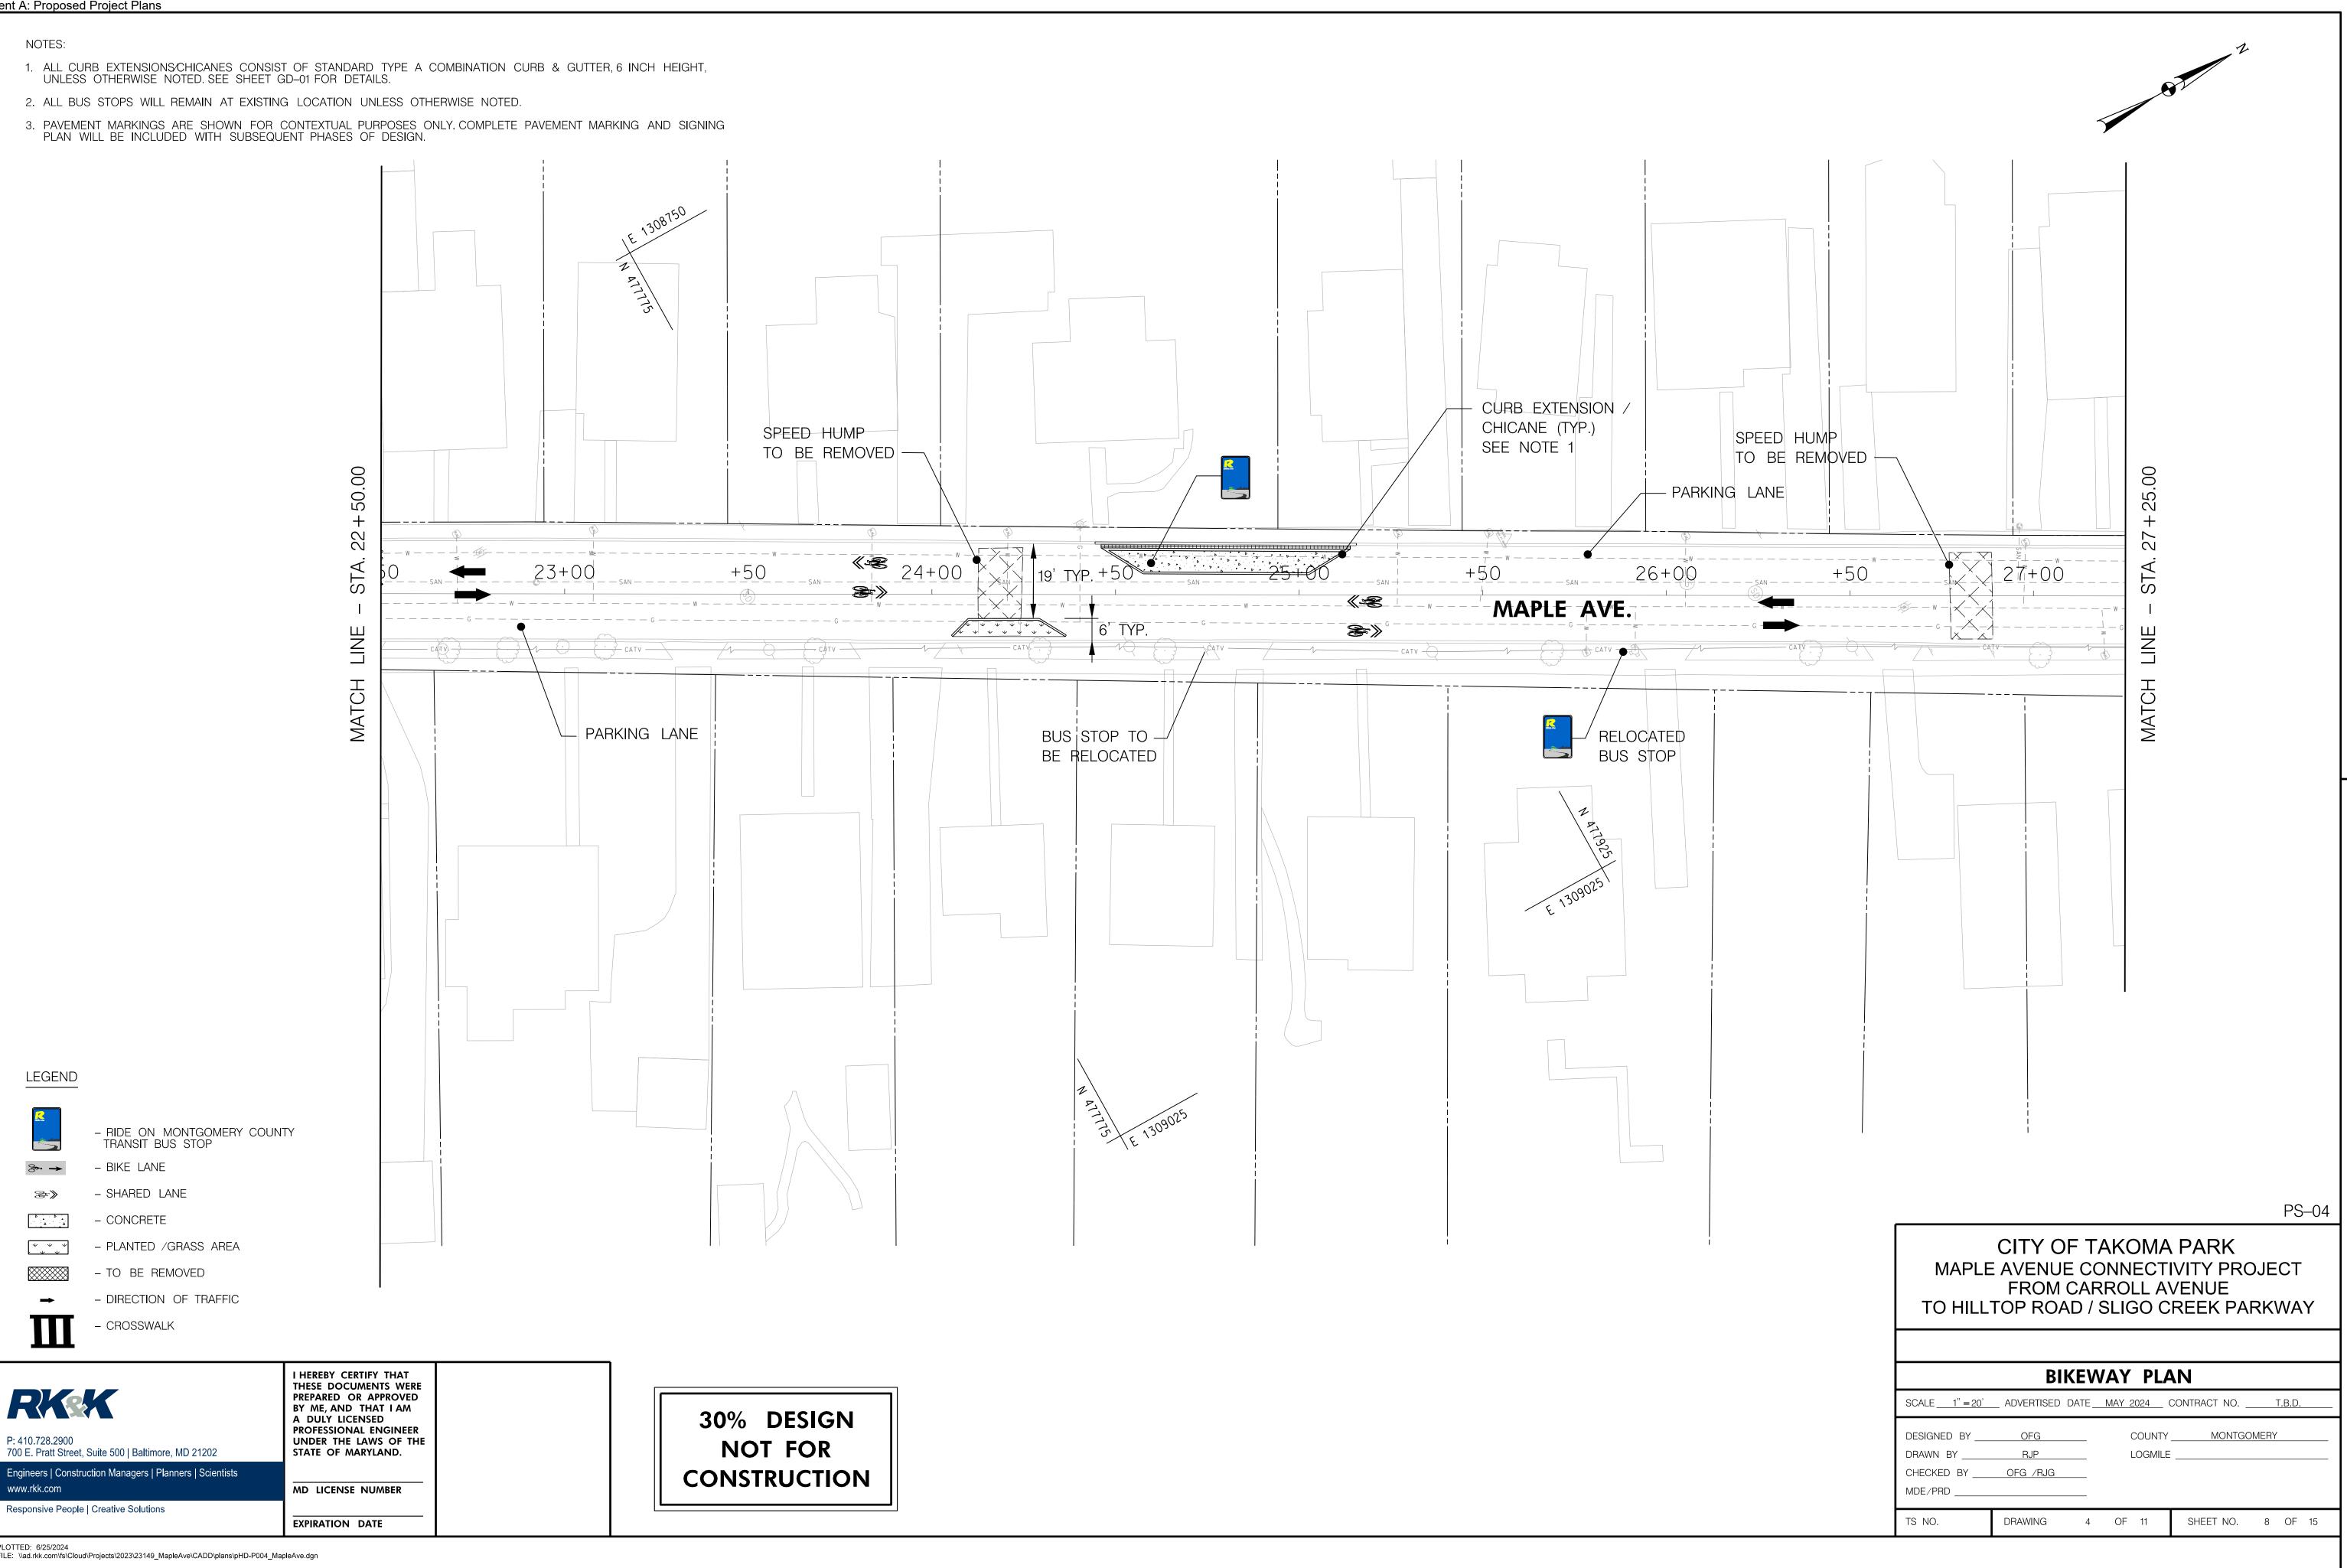
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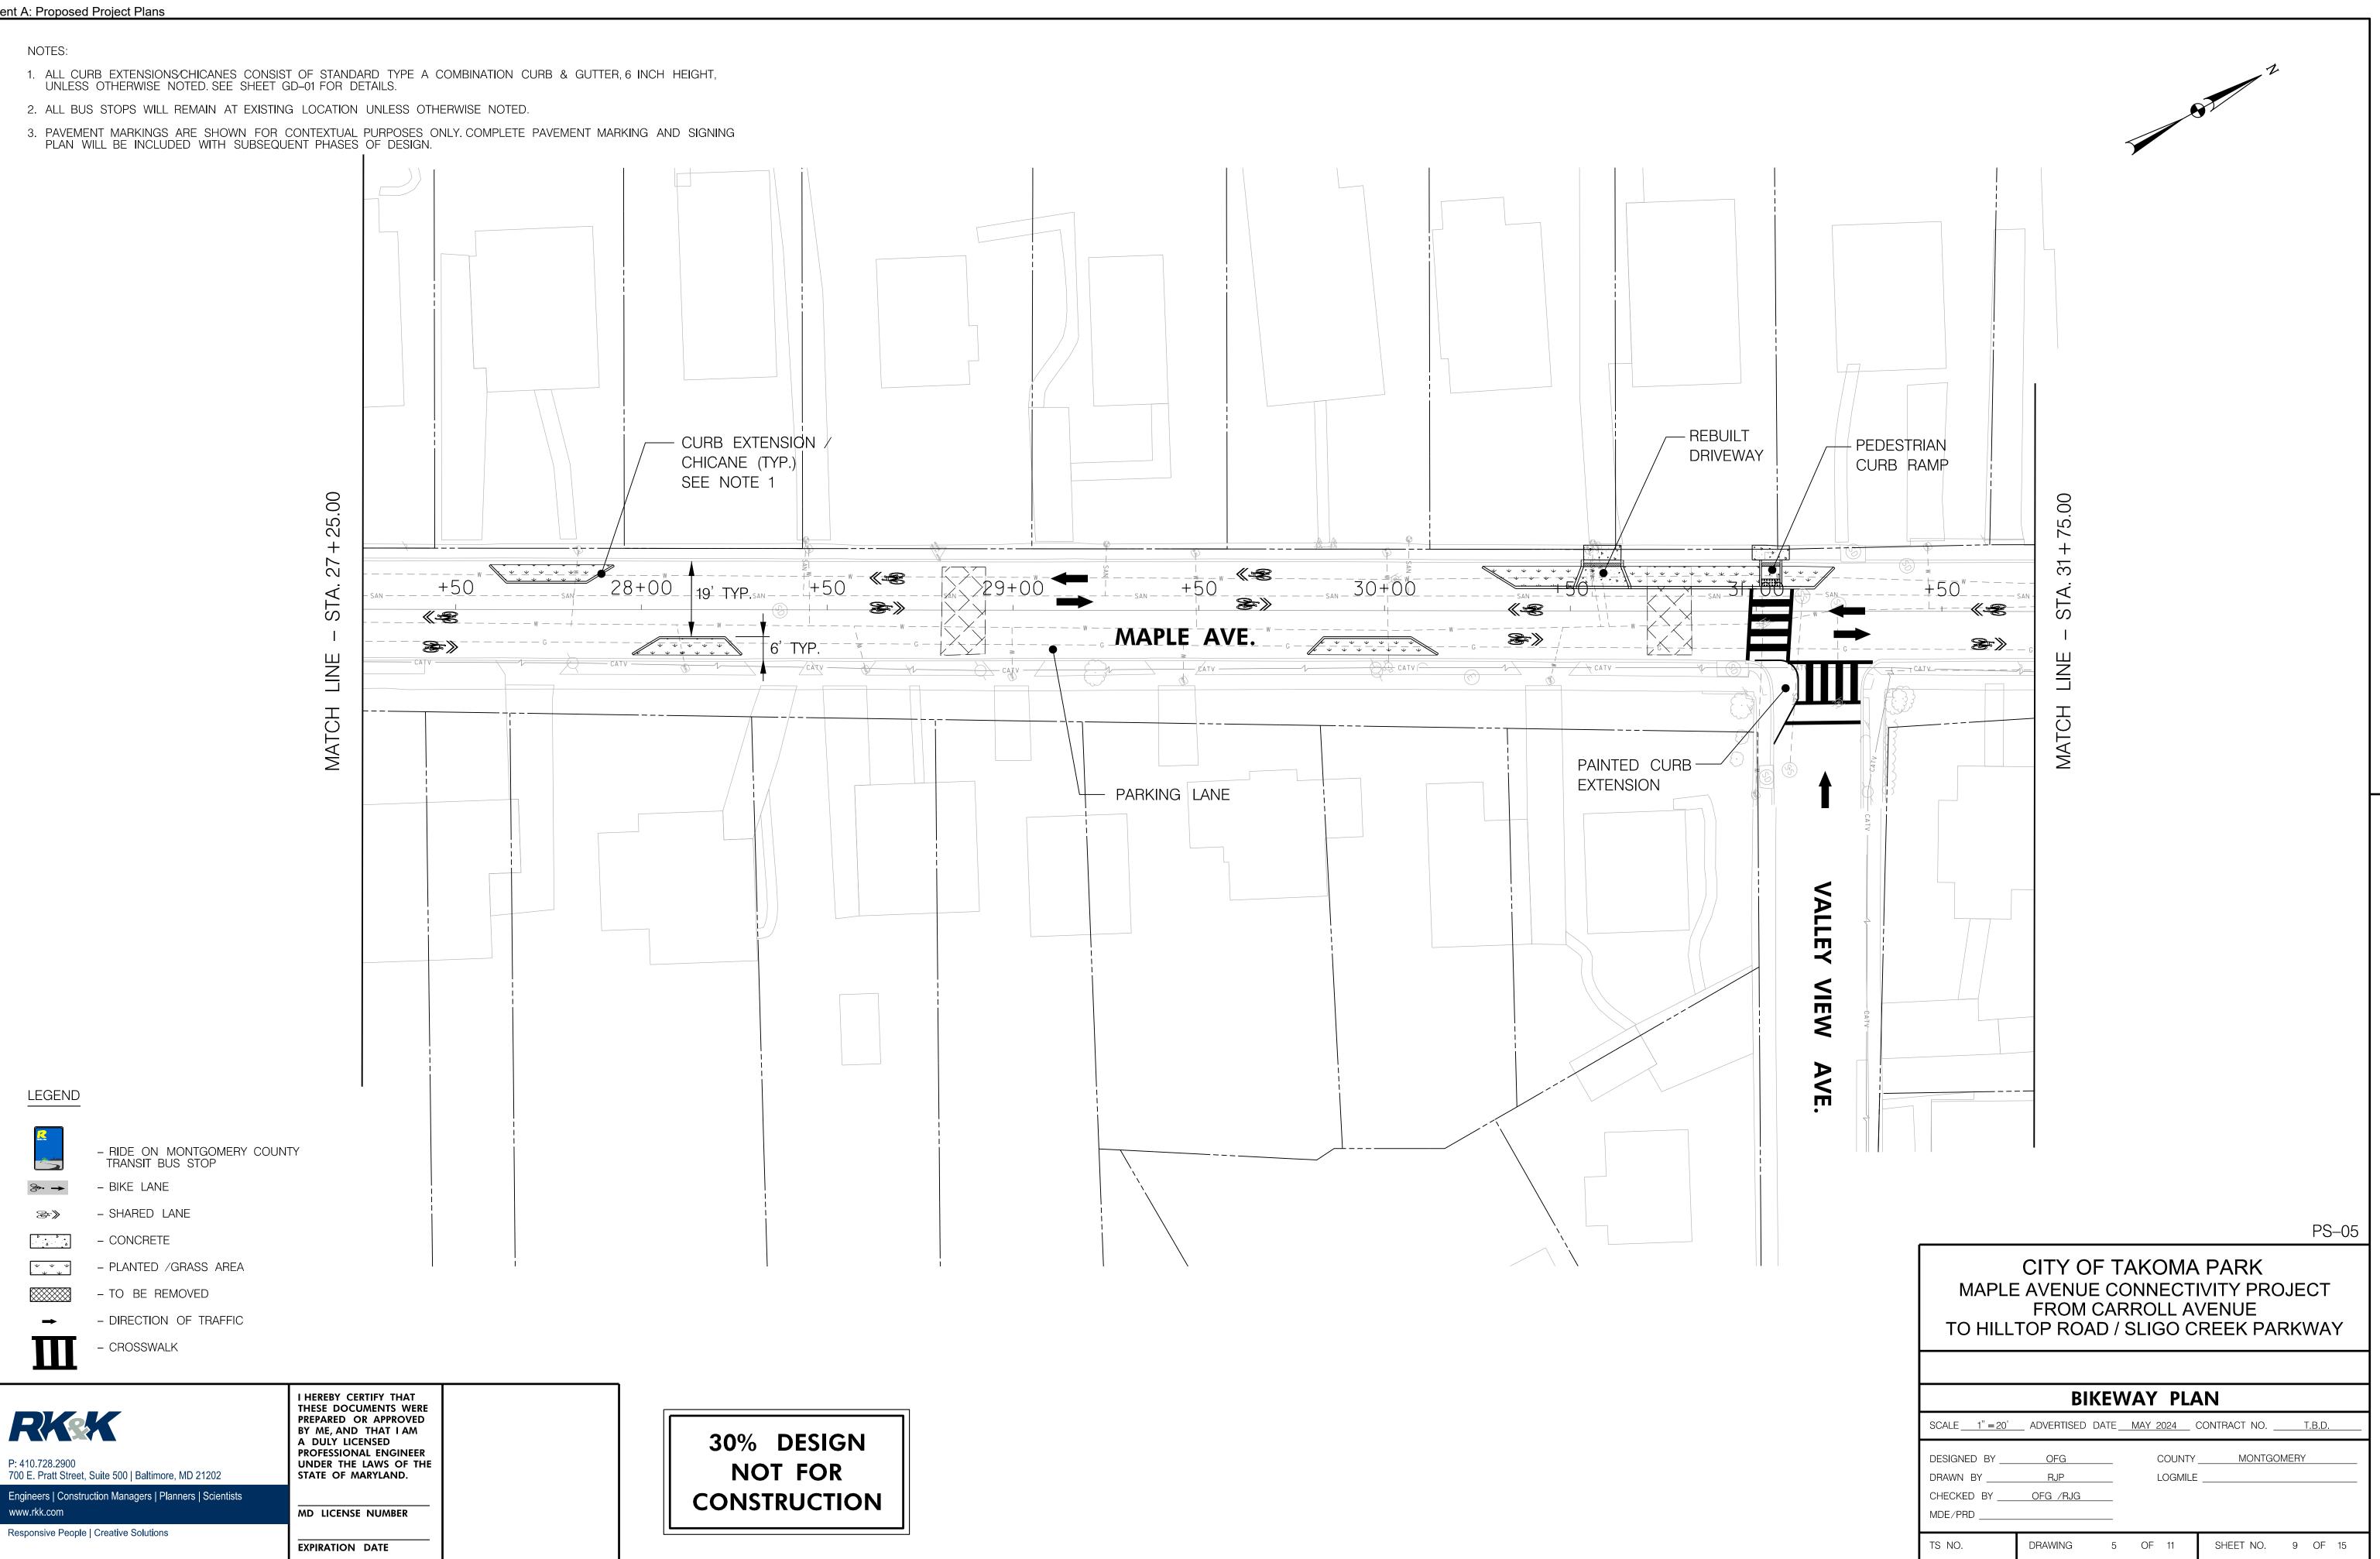
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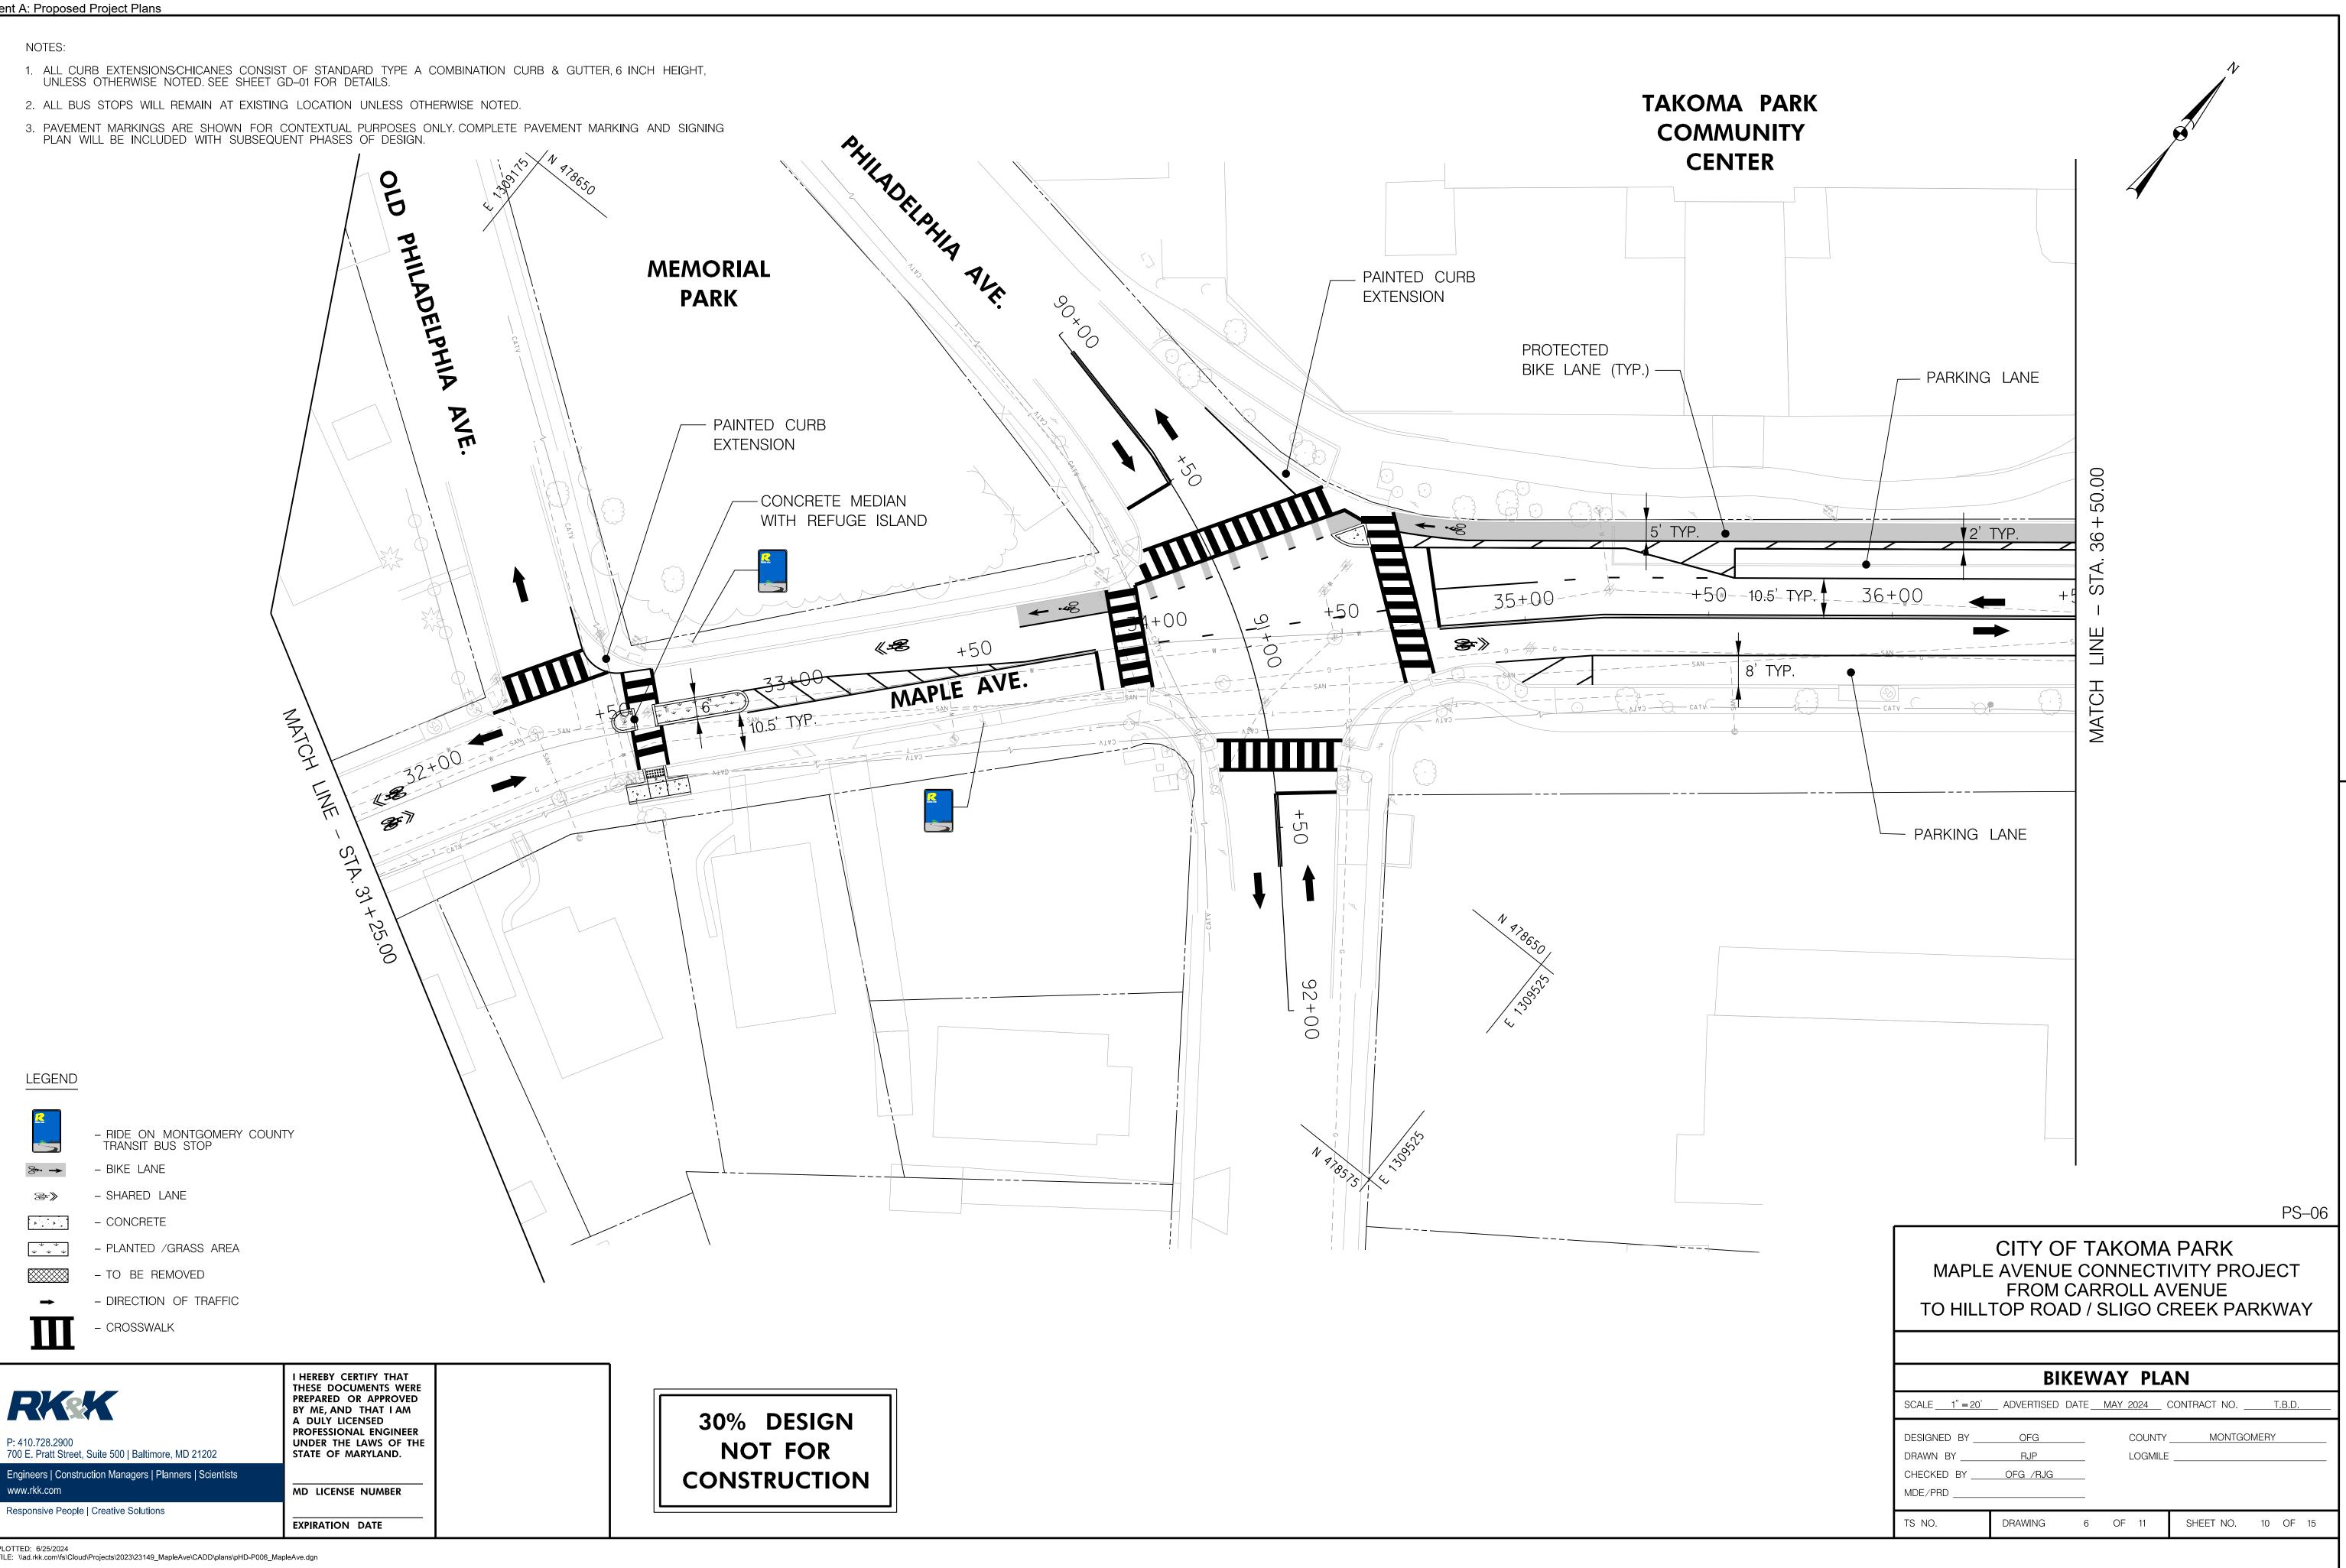
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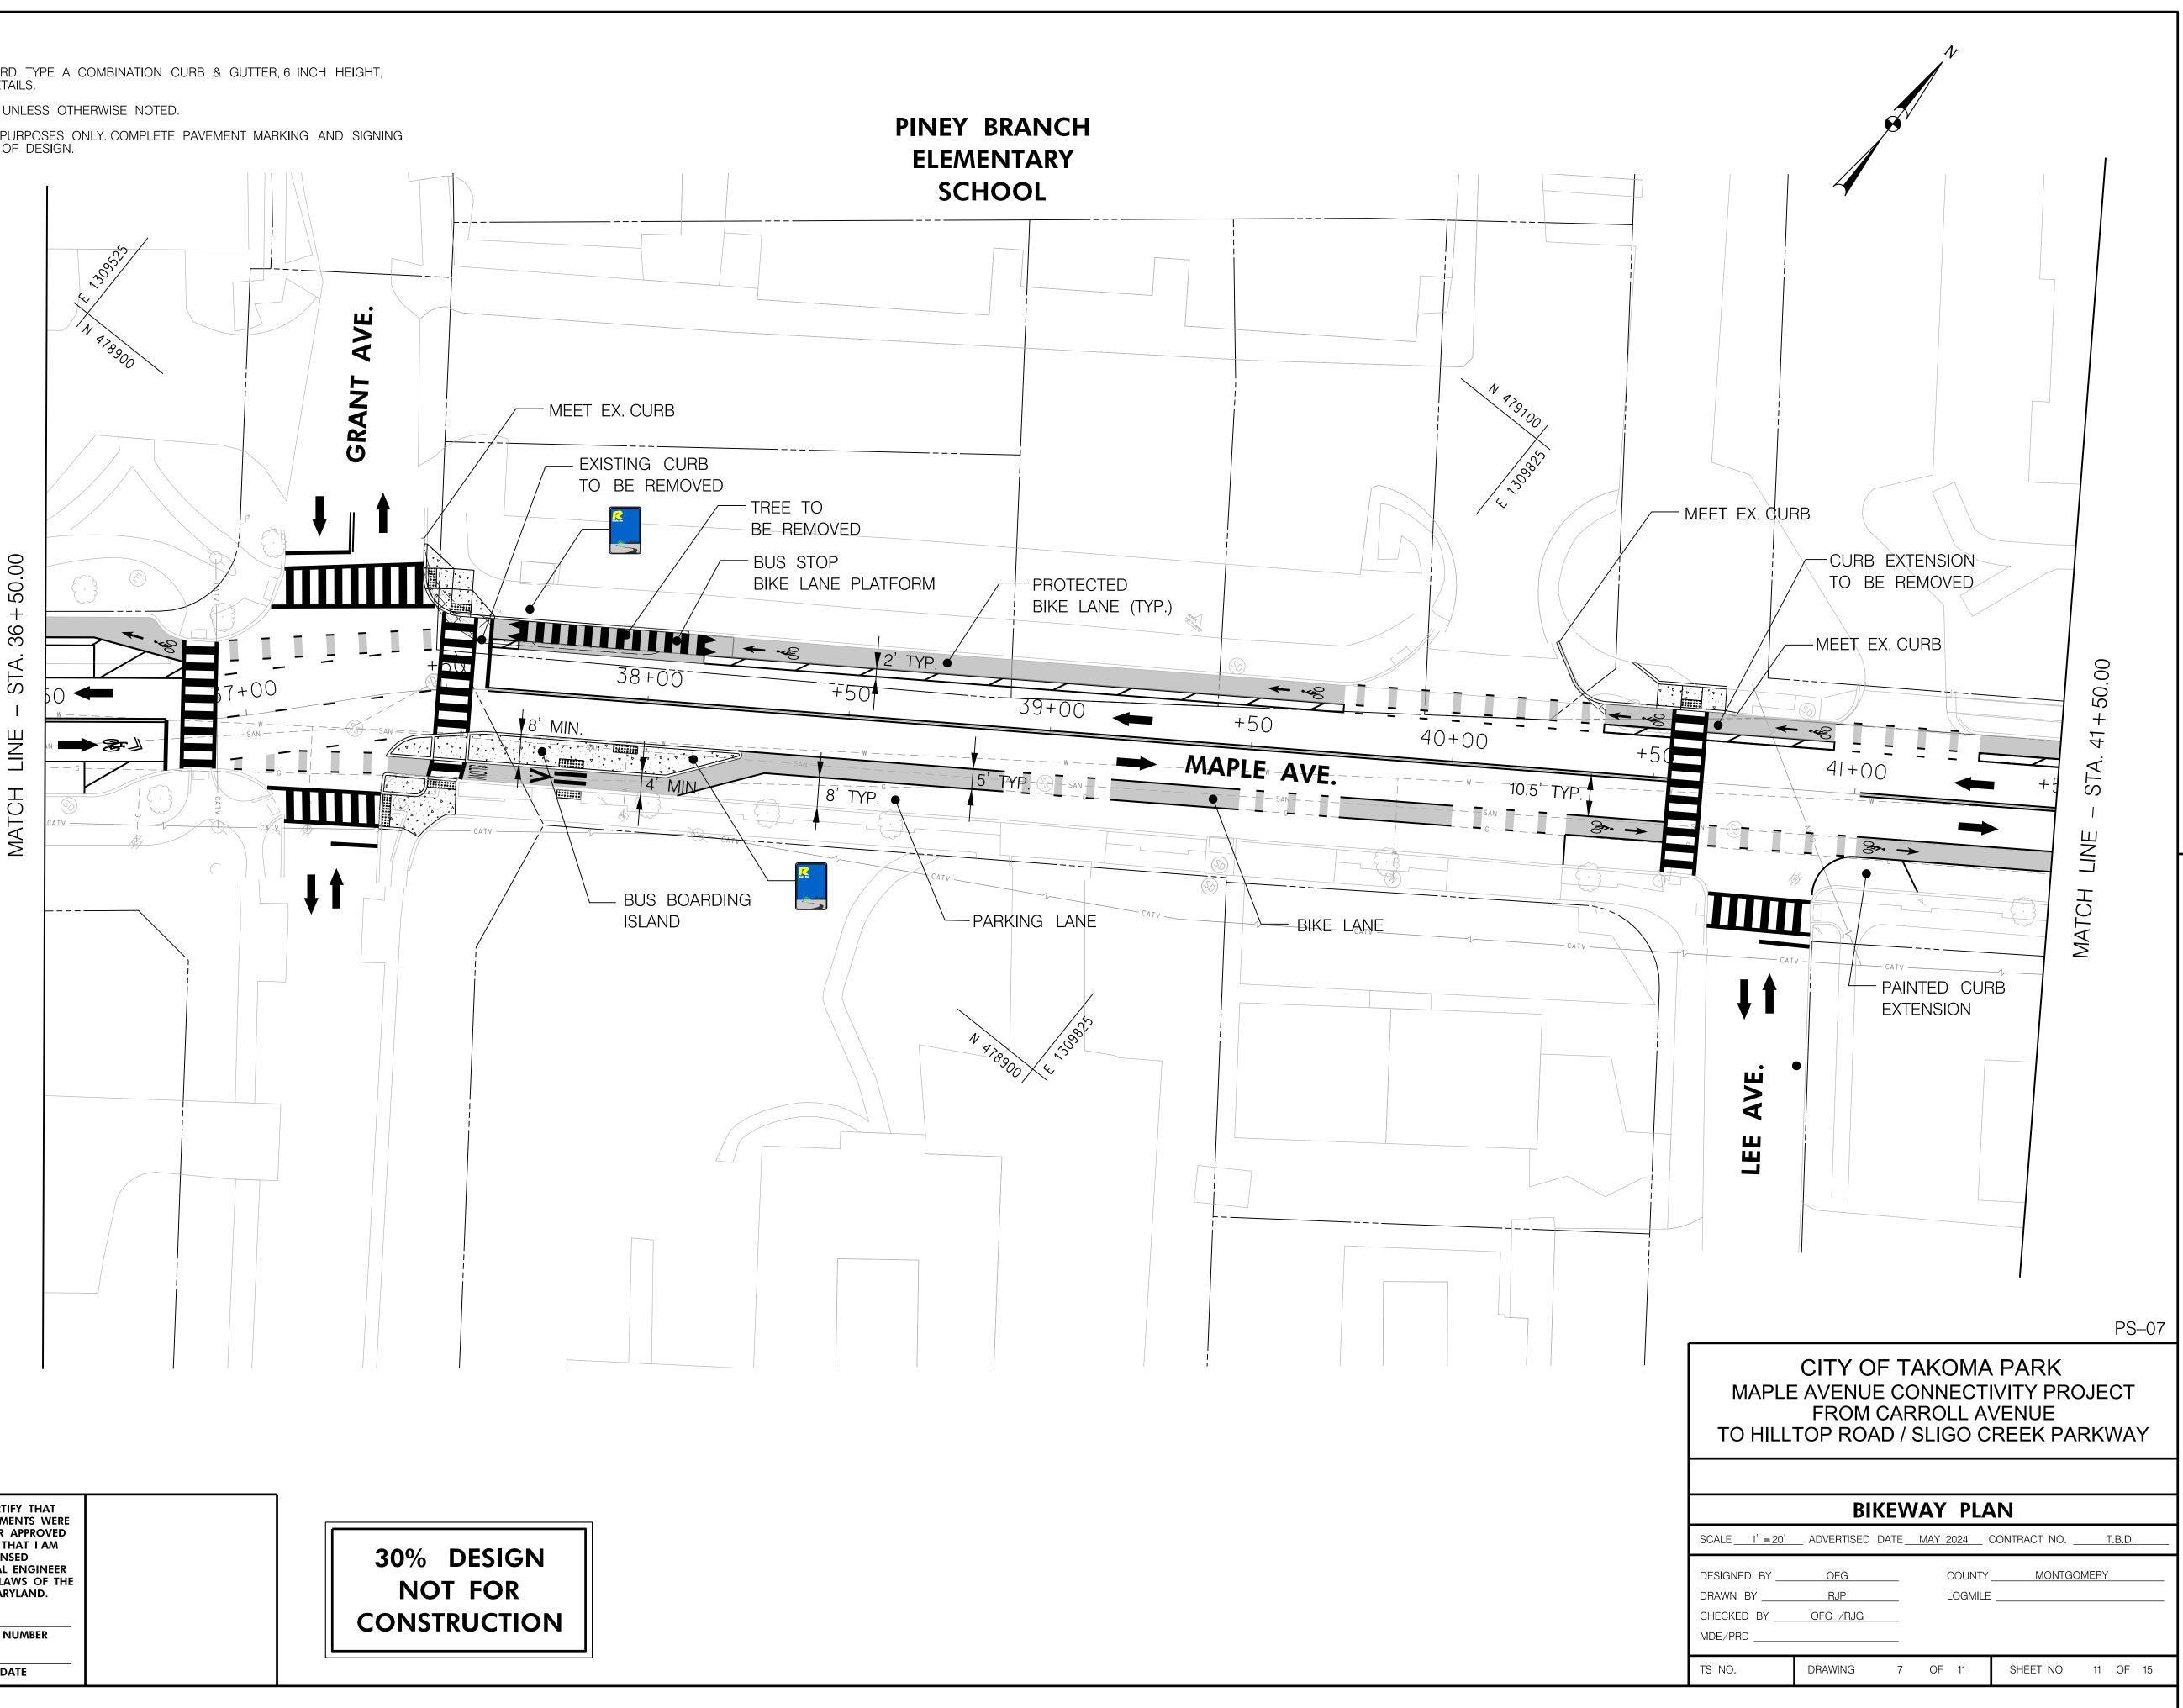
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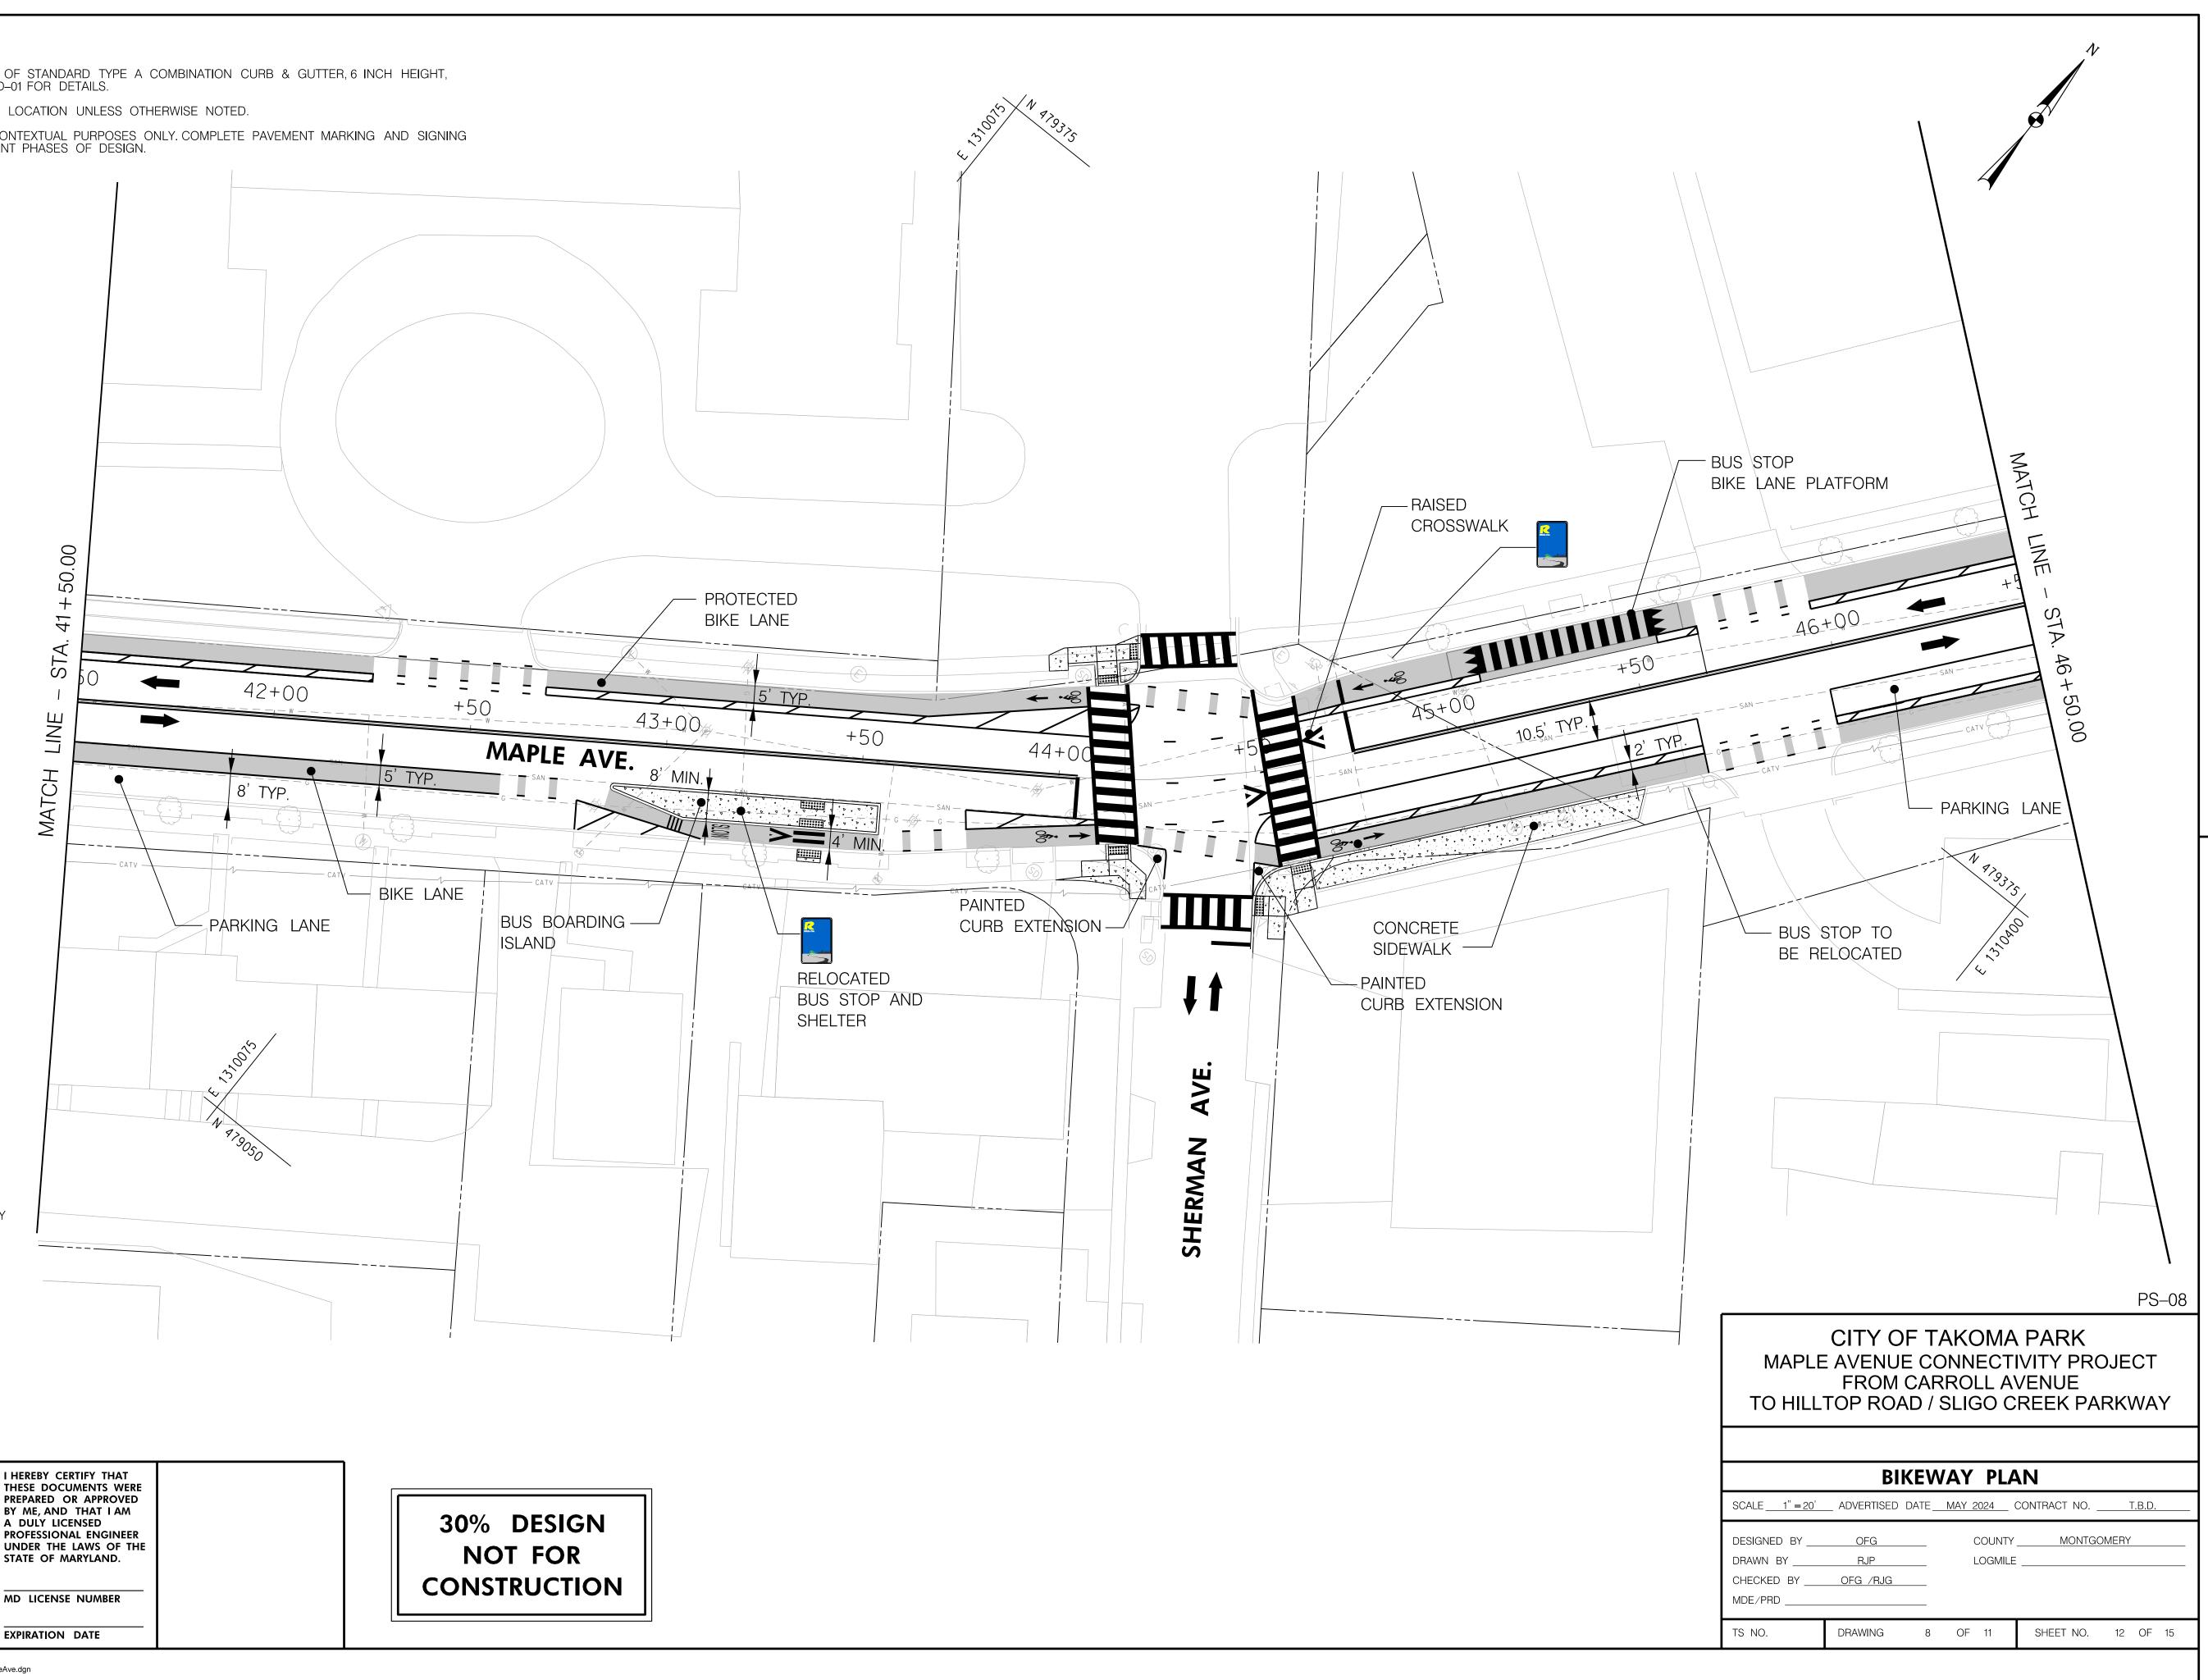
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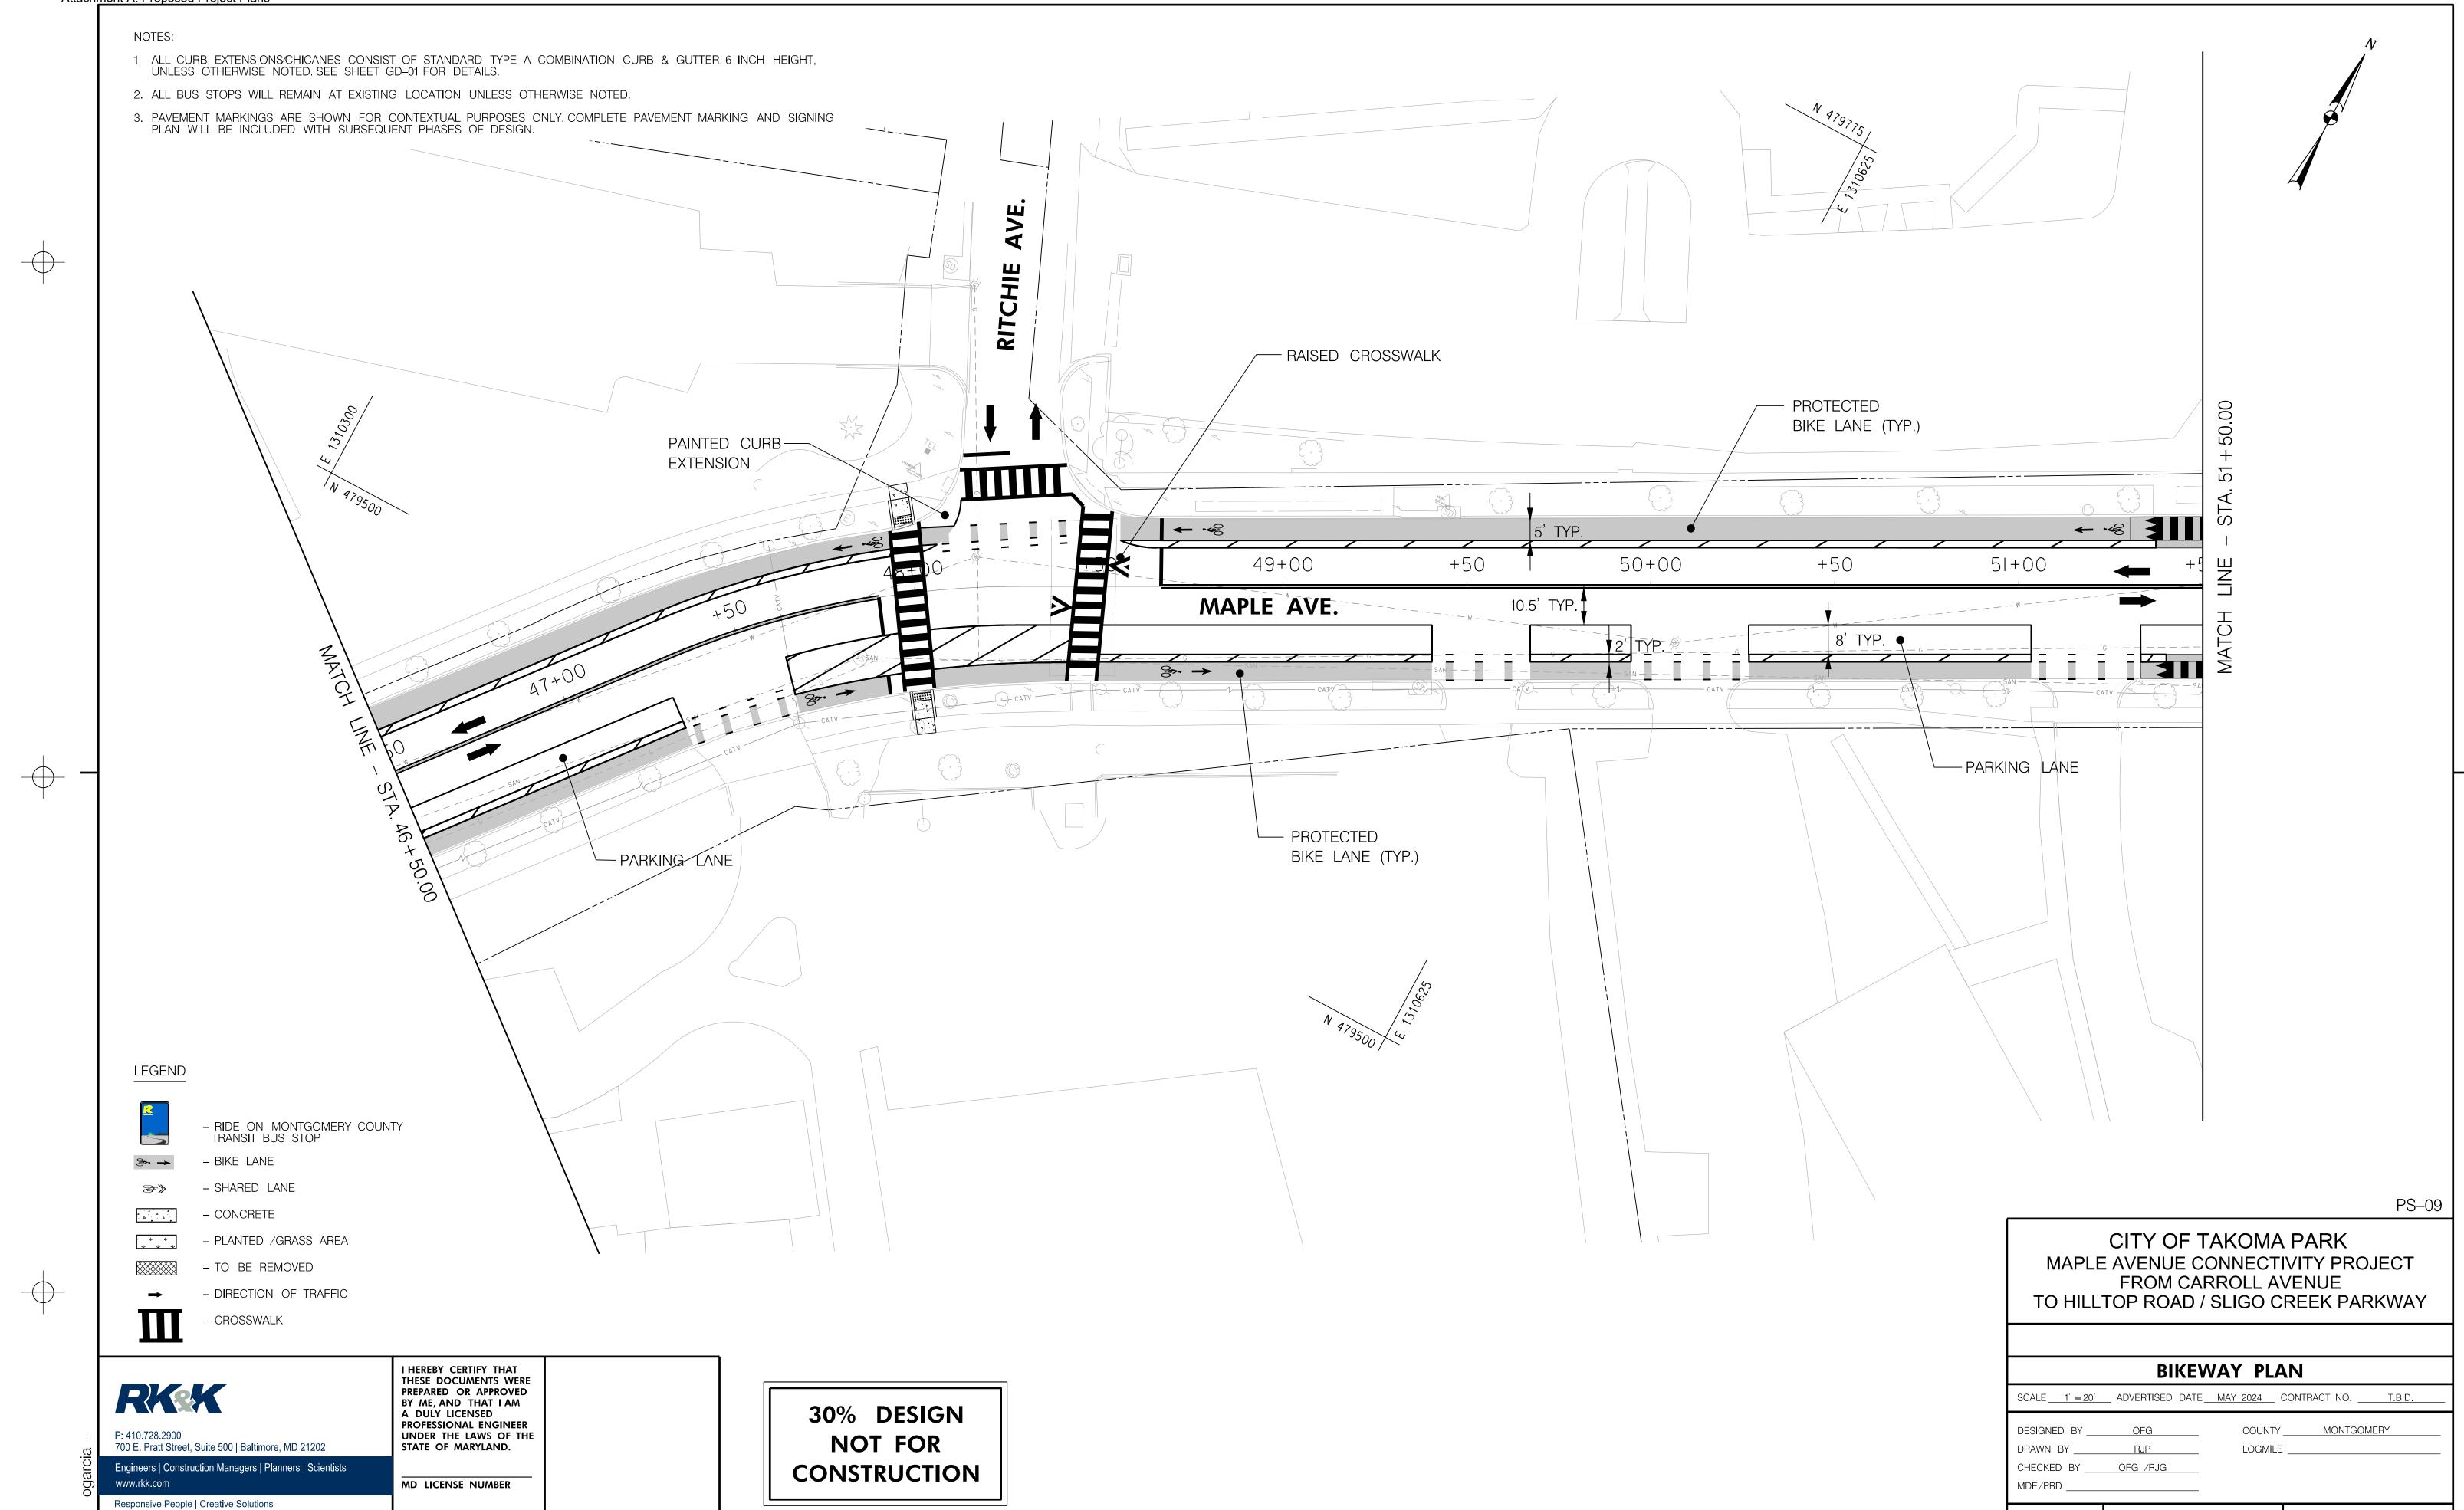
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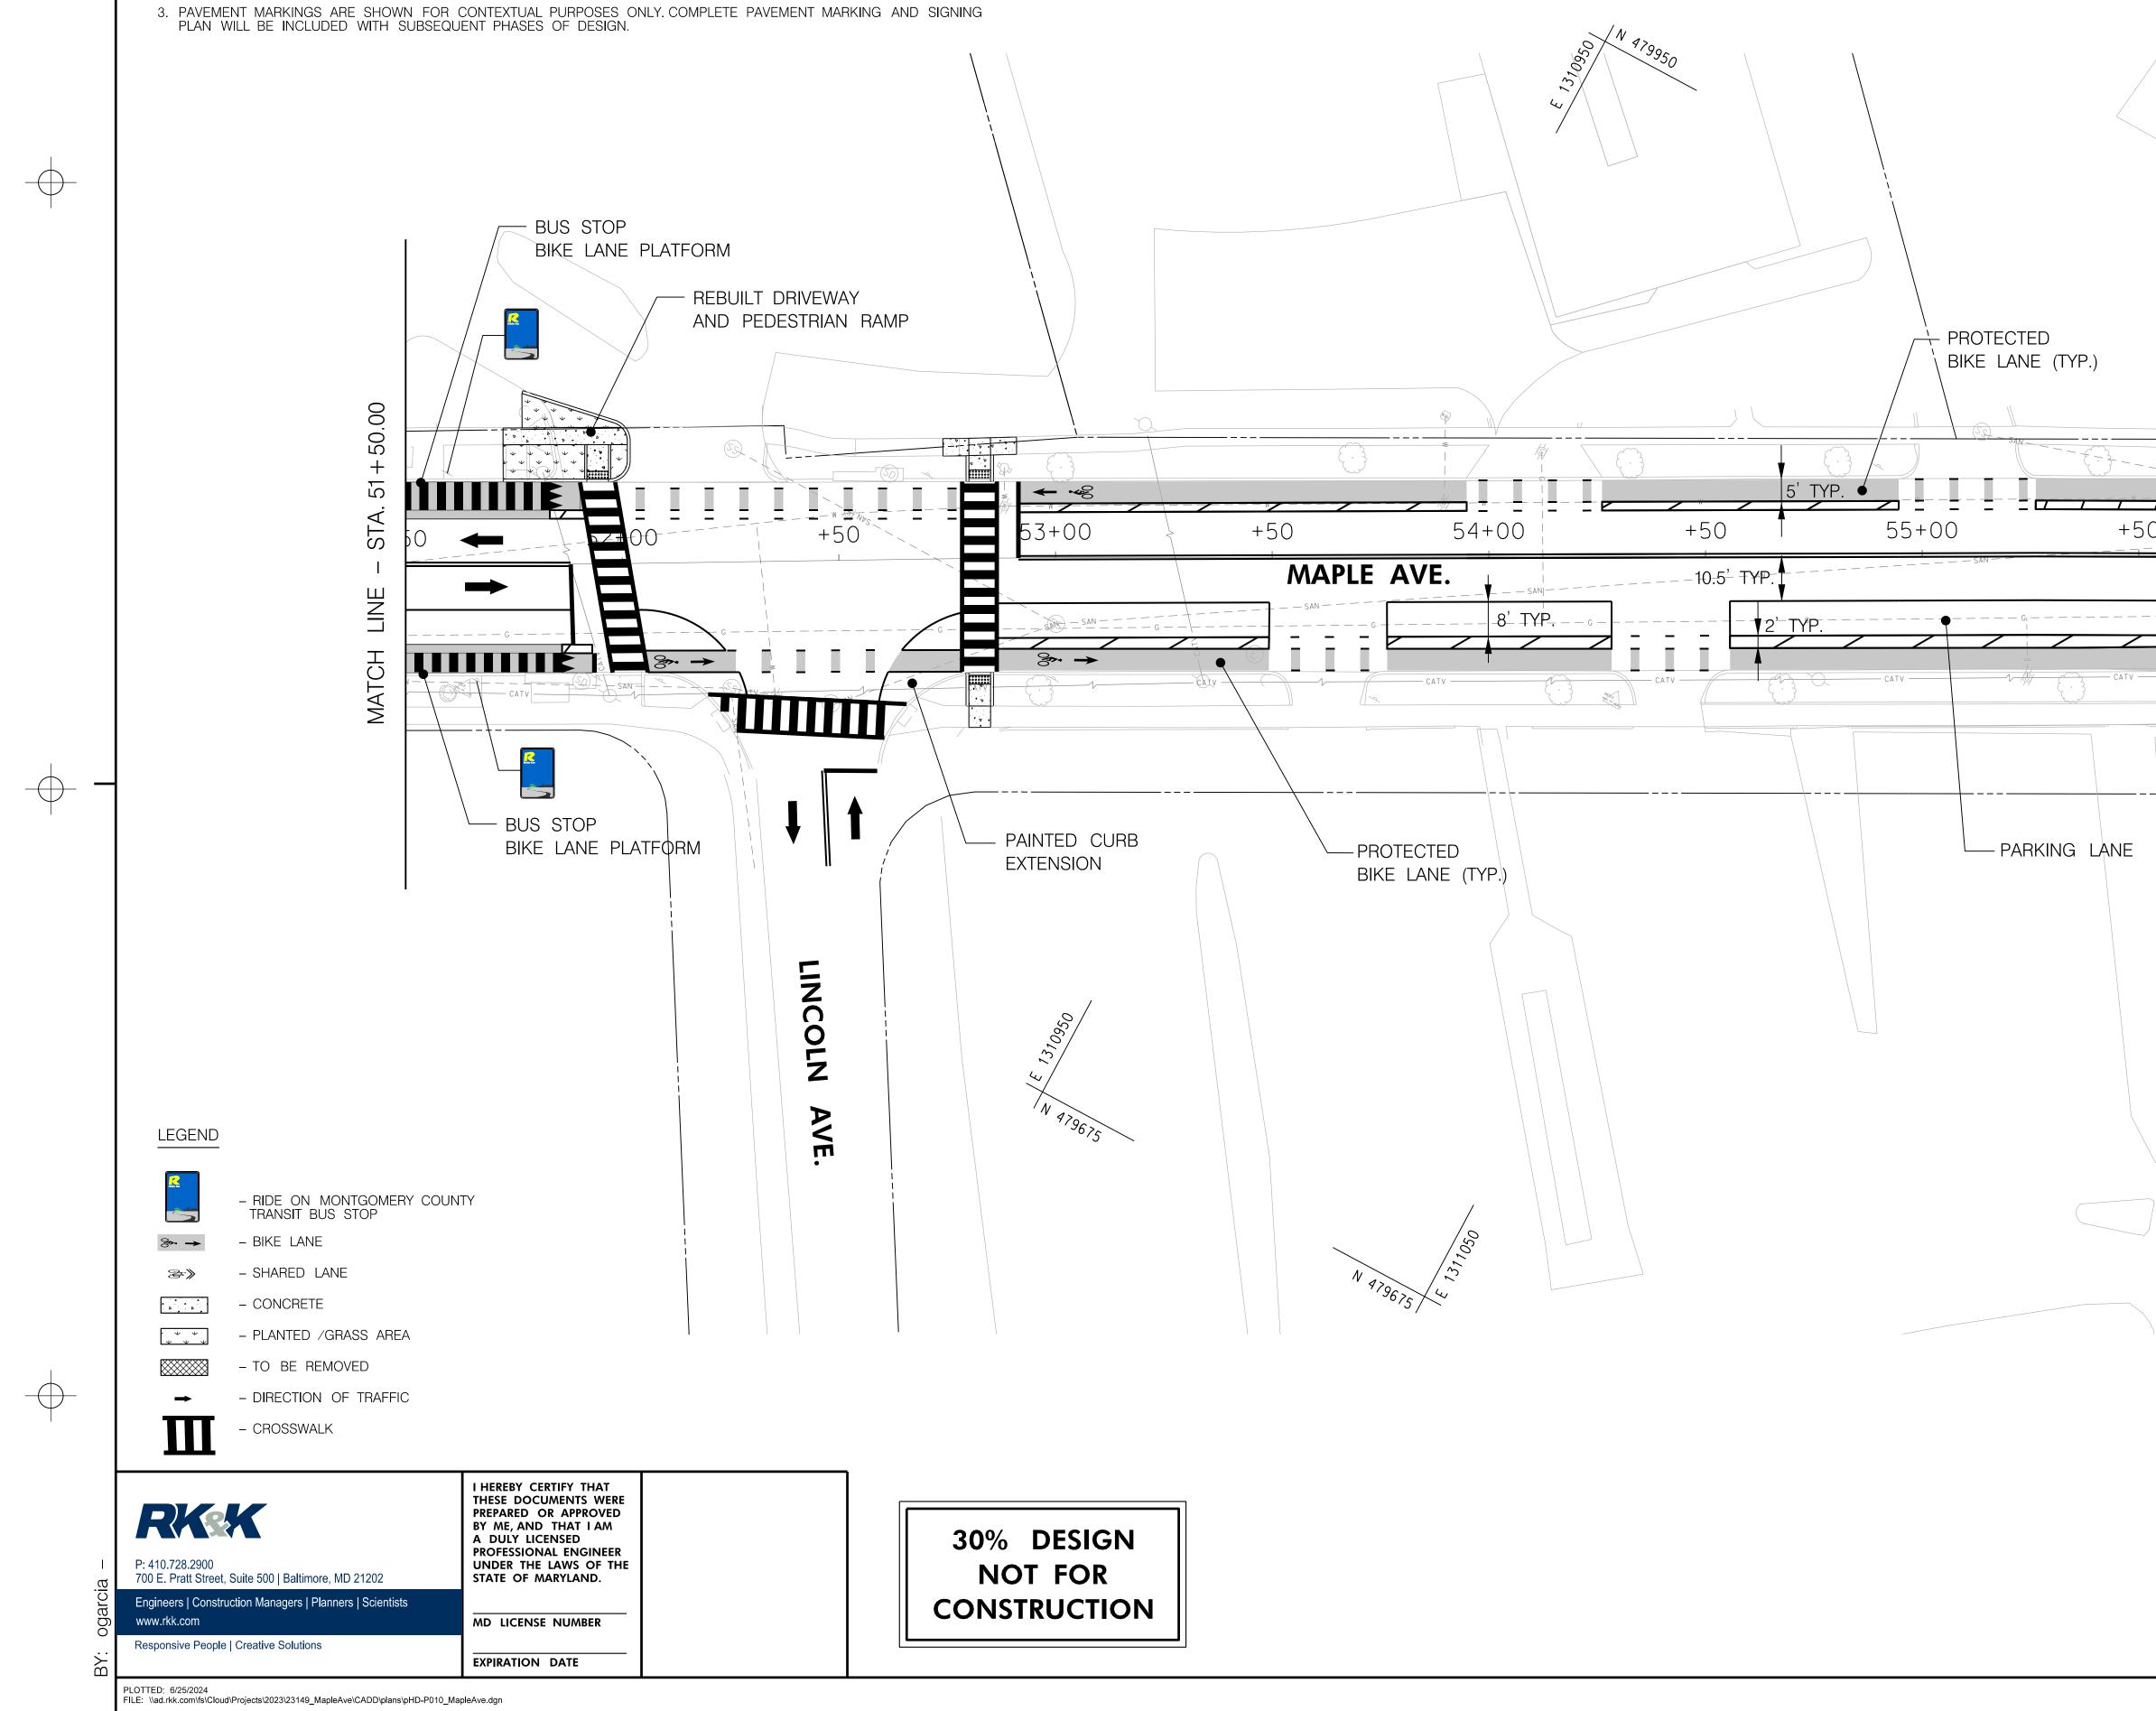
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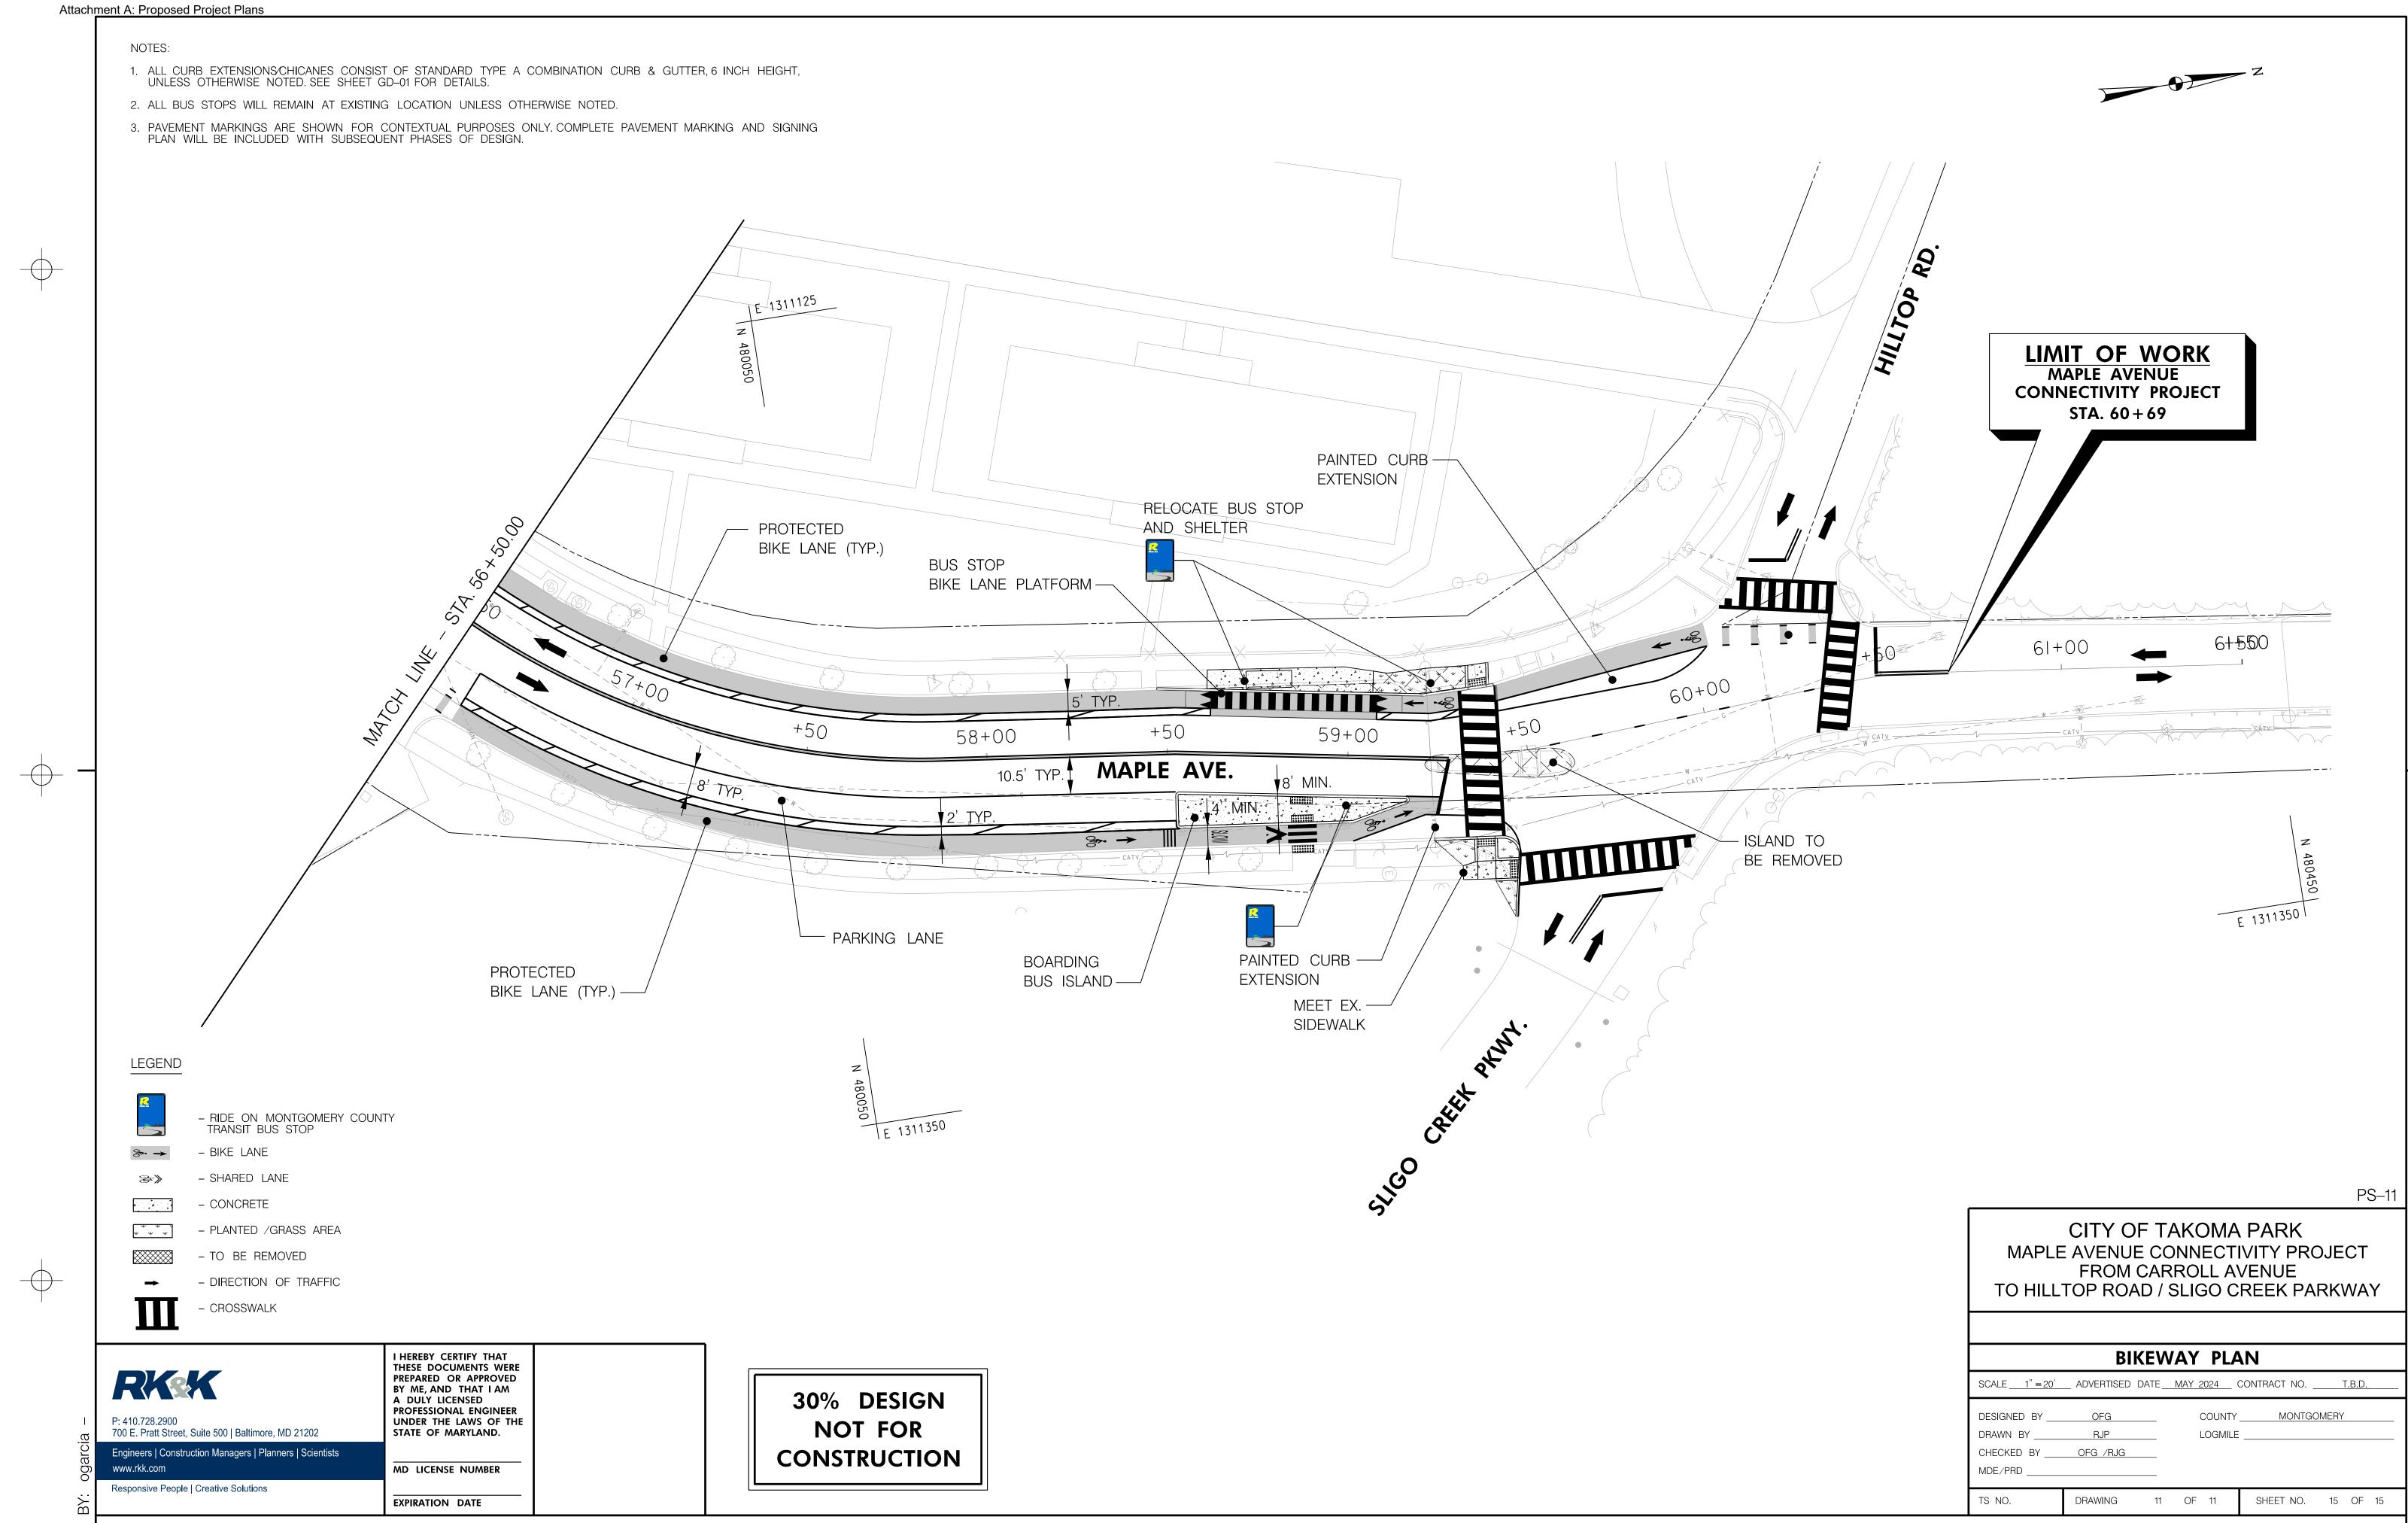
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PS-10 CITY OF TAKOMA PARK MAPLE AVENUE CONNECTIVITY PROJECT FROM CARROLL AVENUE TO HILLTOP ROAD / SLIGO CREEK PARKWAY DHILLTOP ROAD / SLIGO CREEK PARKWAY DESIGNED BY OFG OFG MAY 2024 CONTRACT NO. TS NO. DRAWING 10 OF



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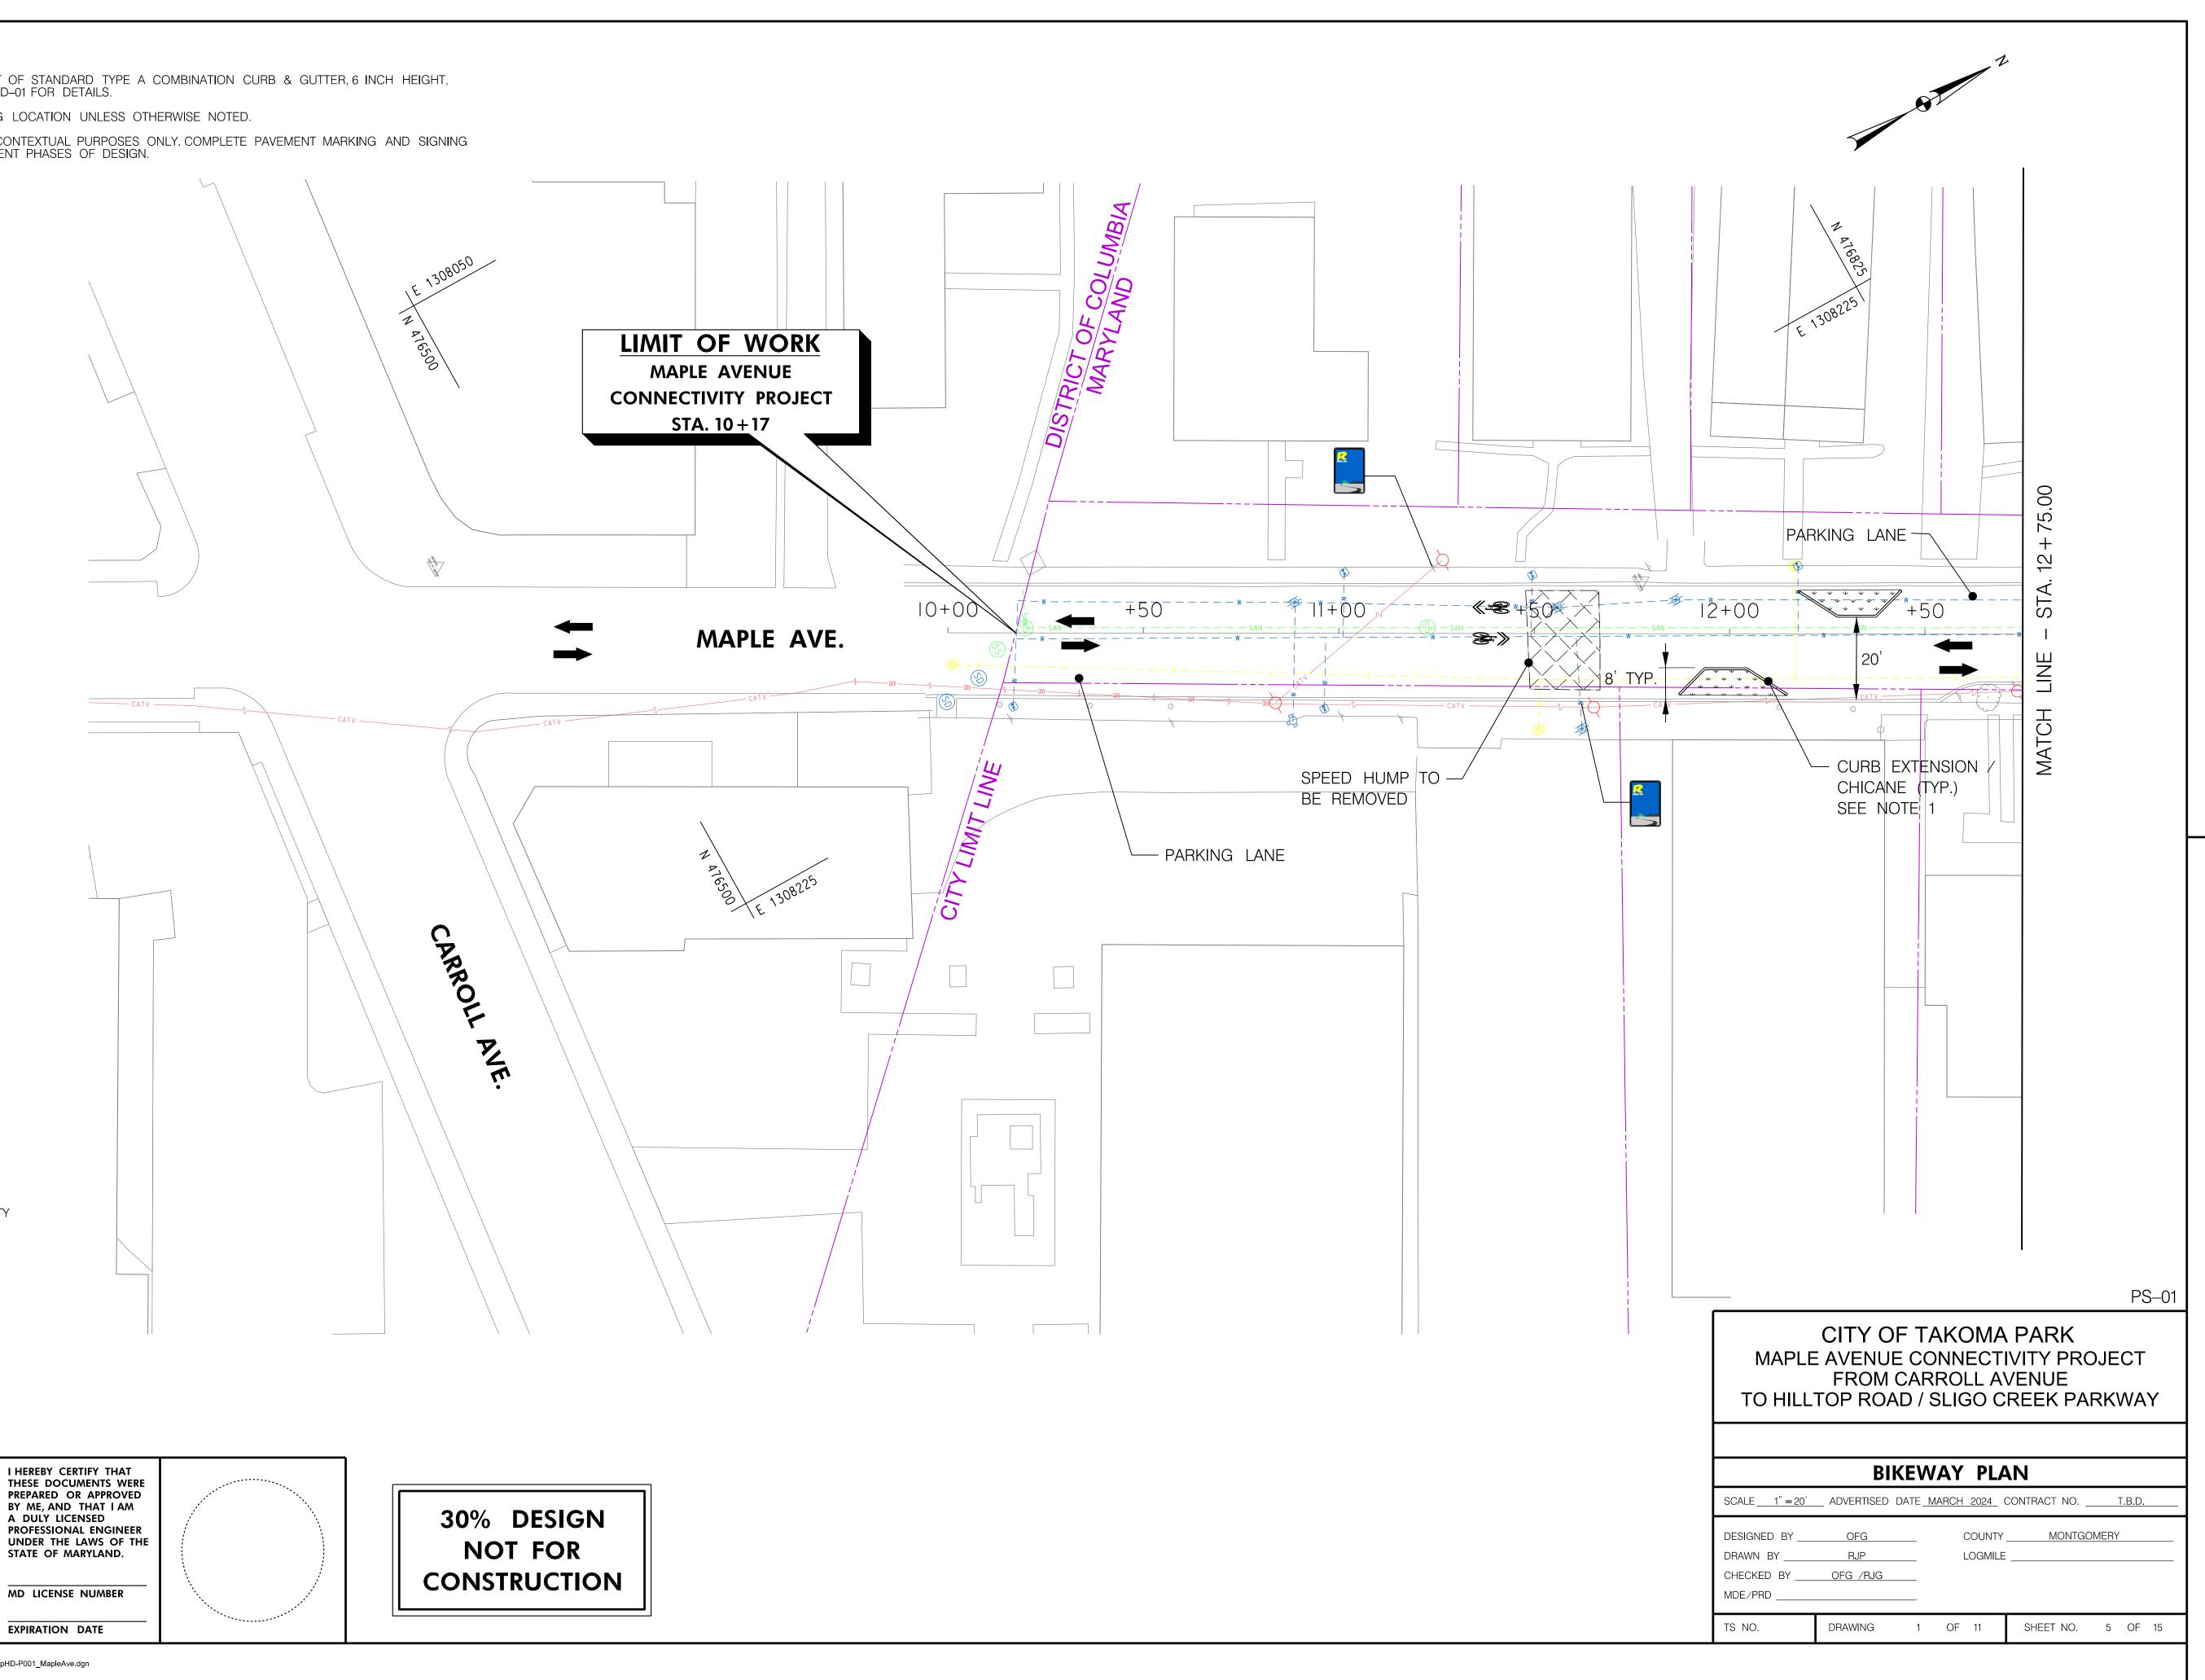
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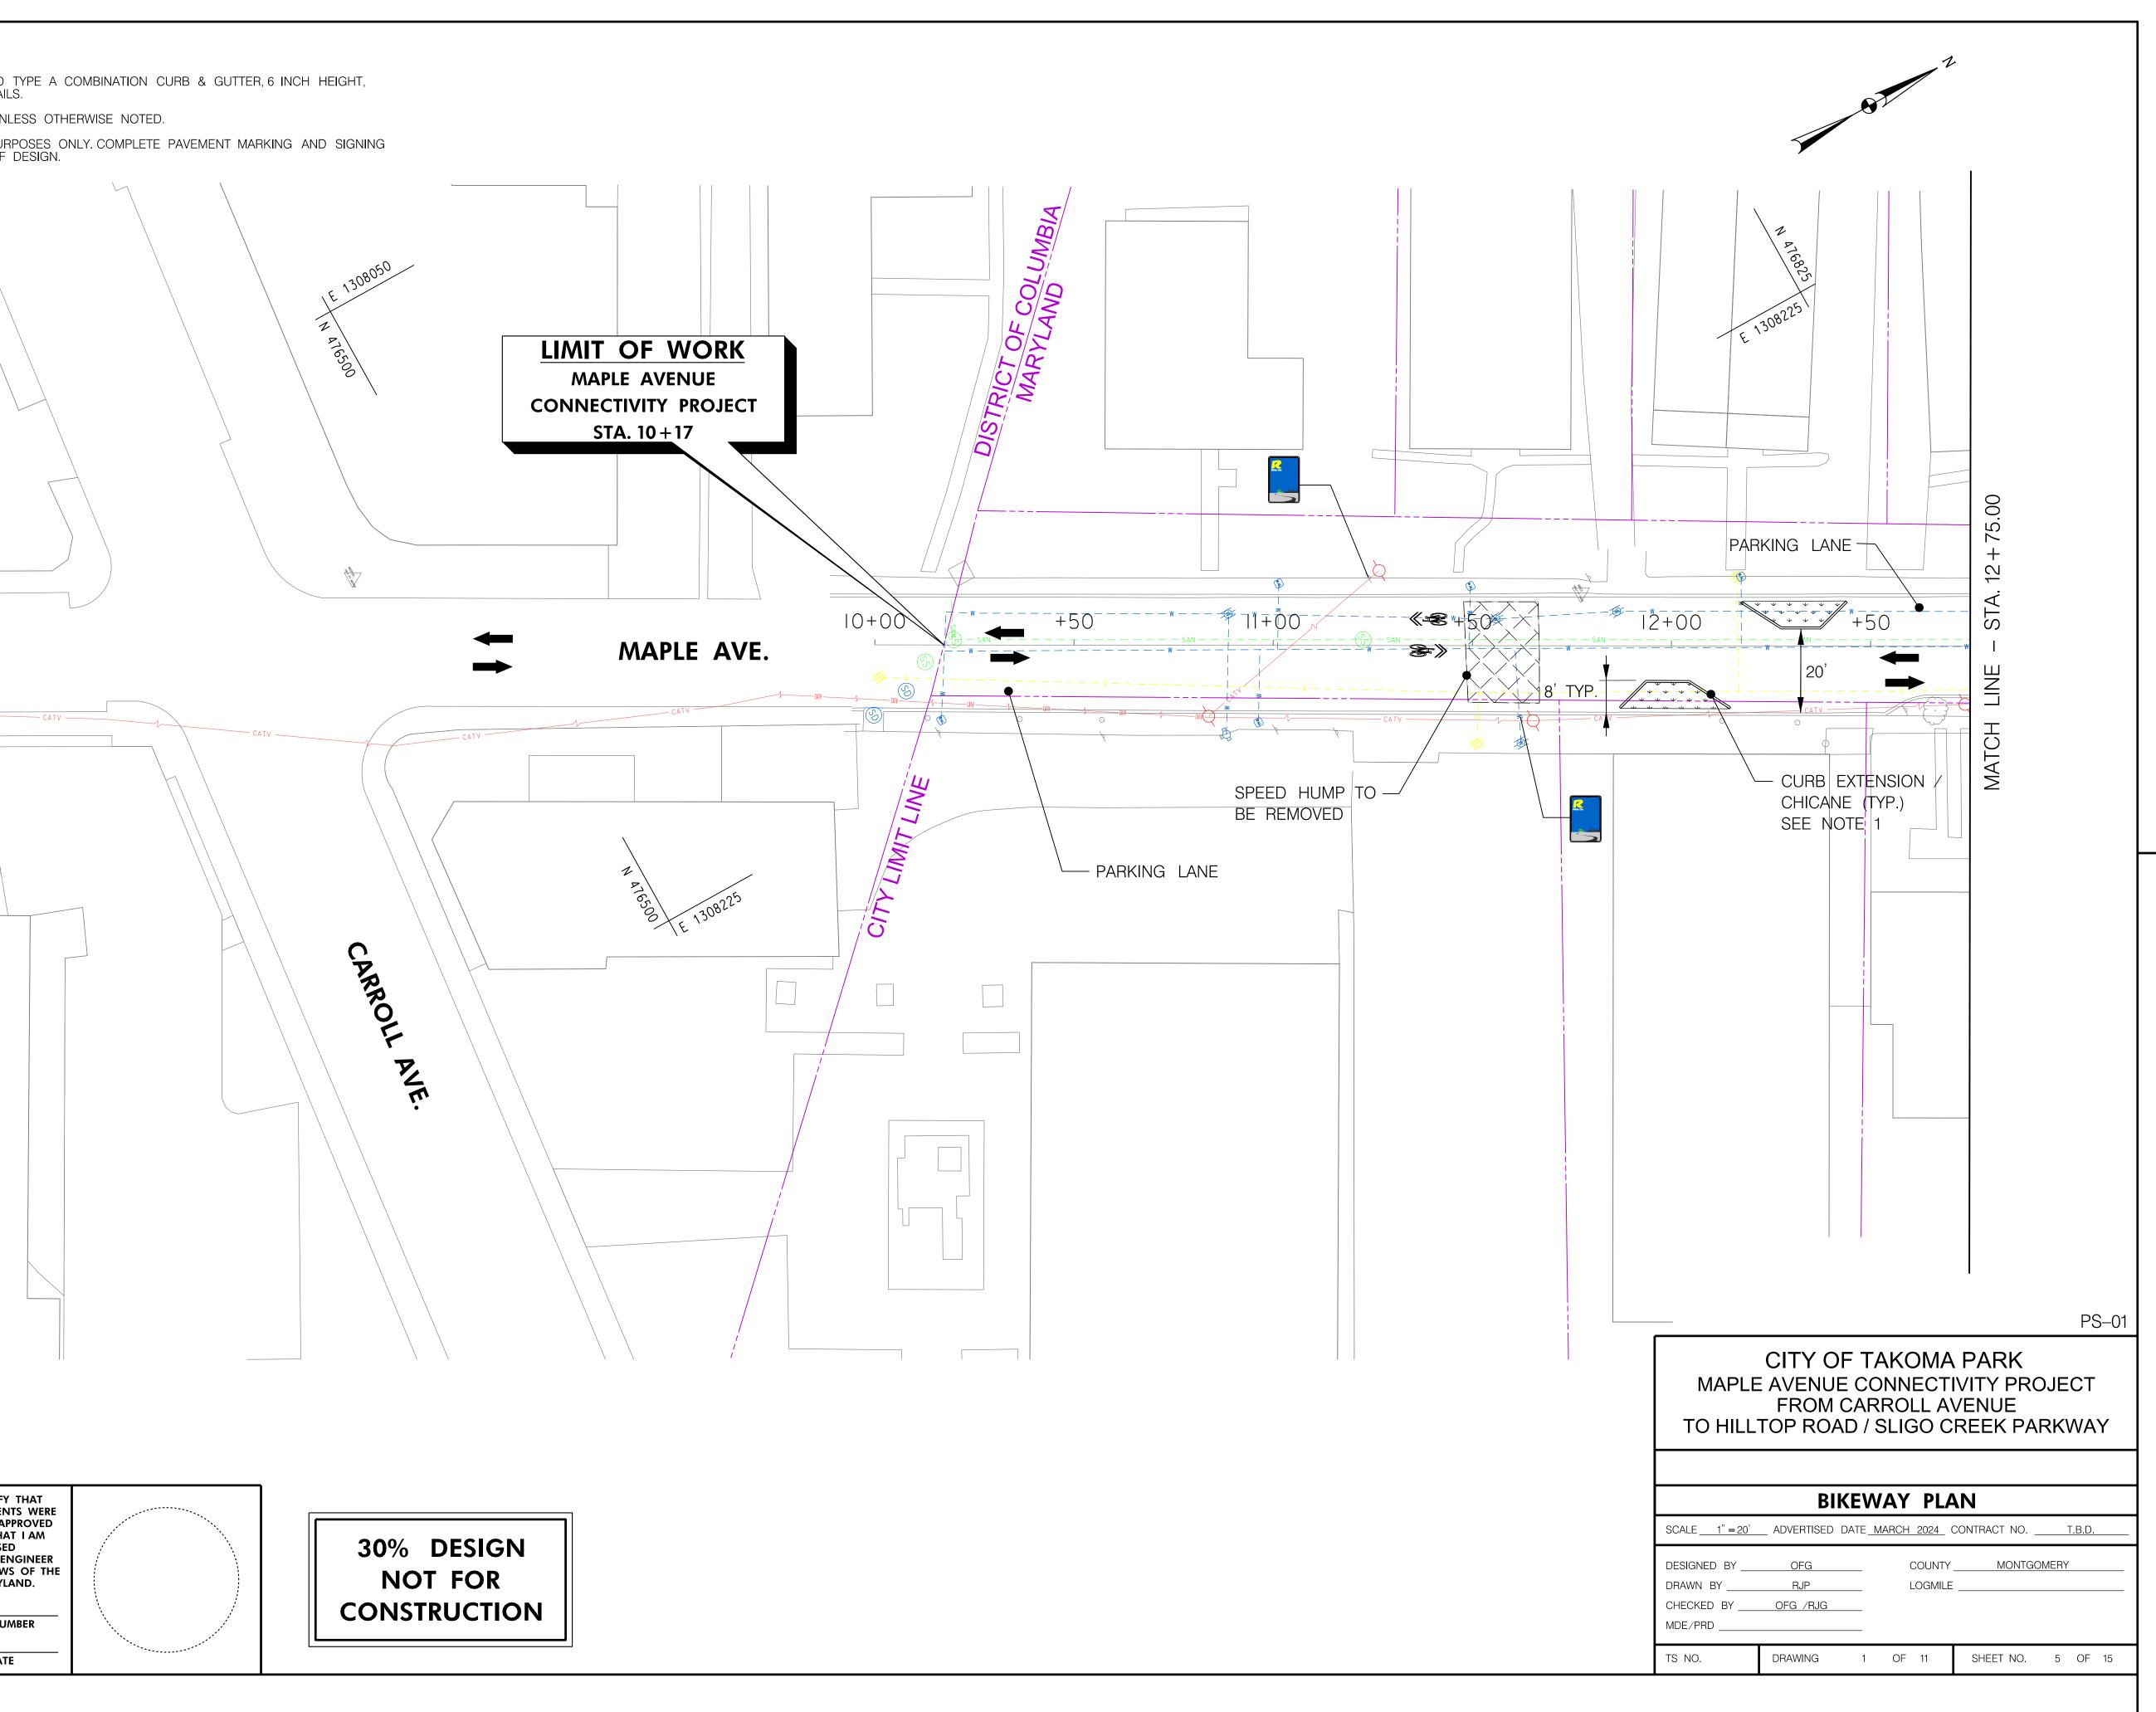
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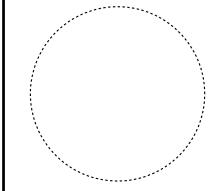
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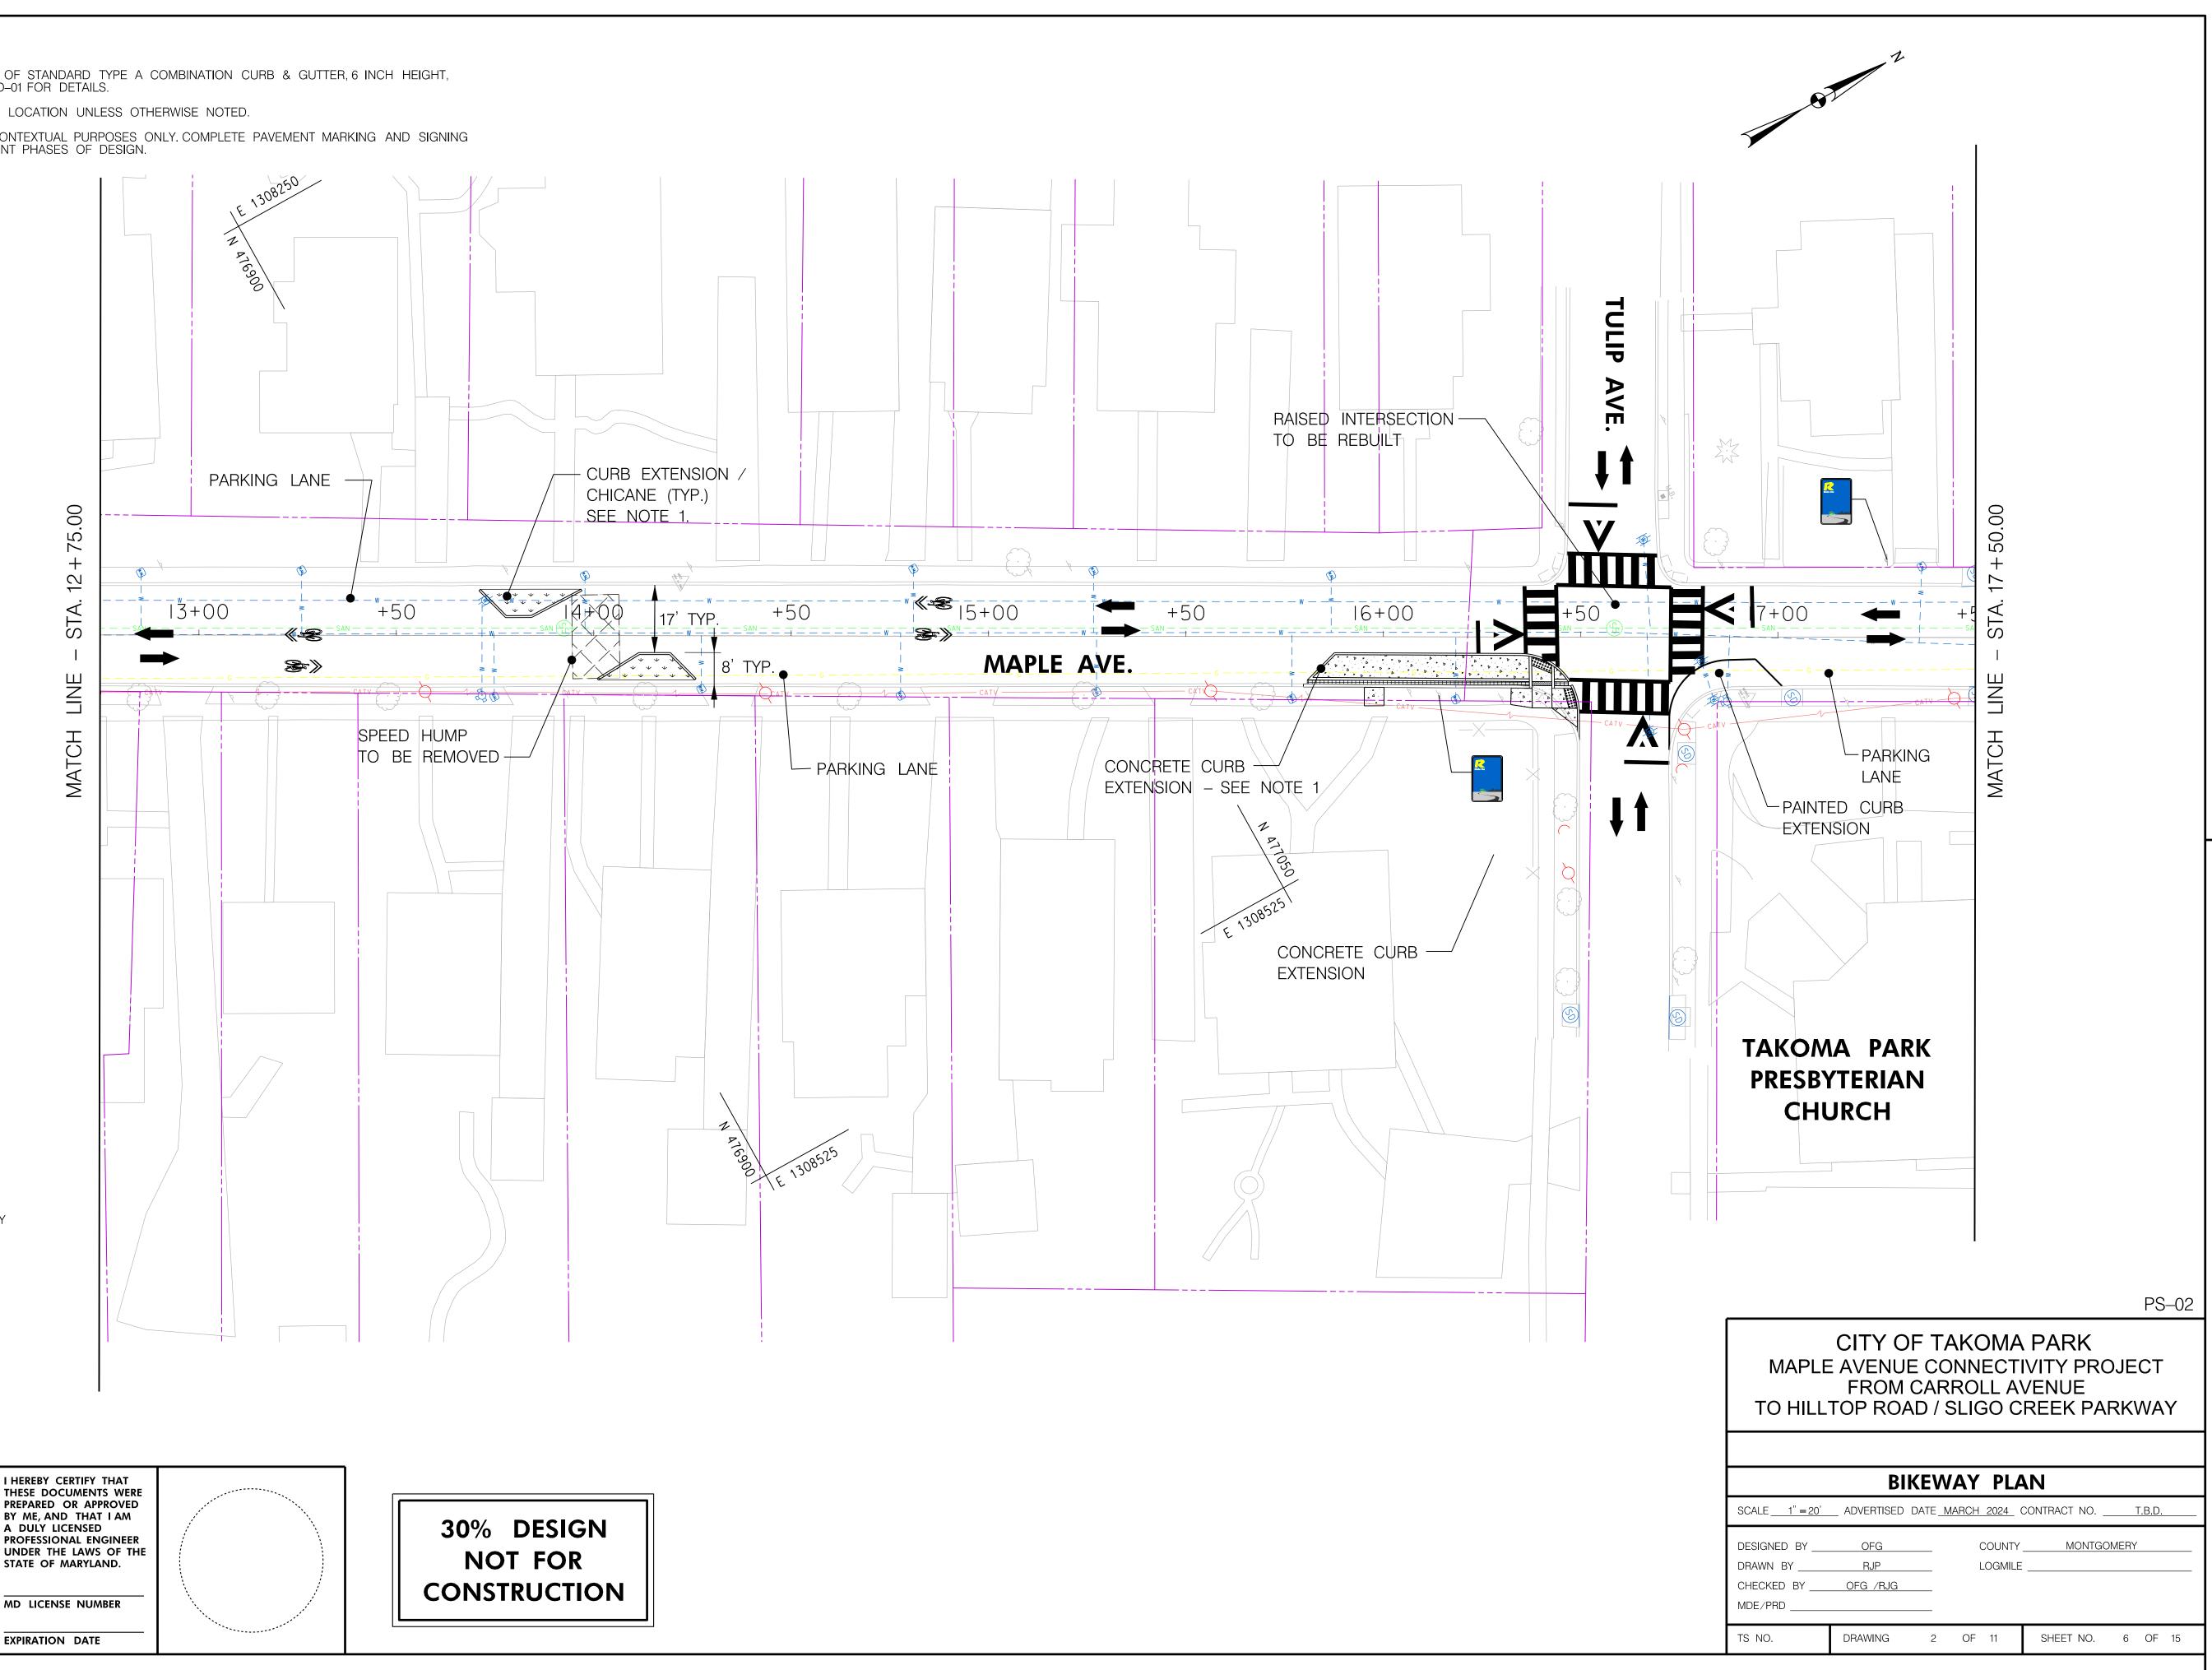


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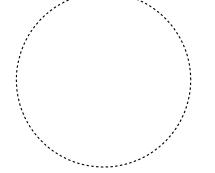
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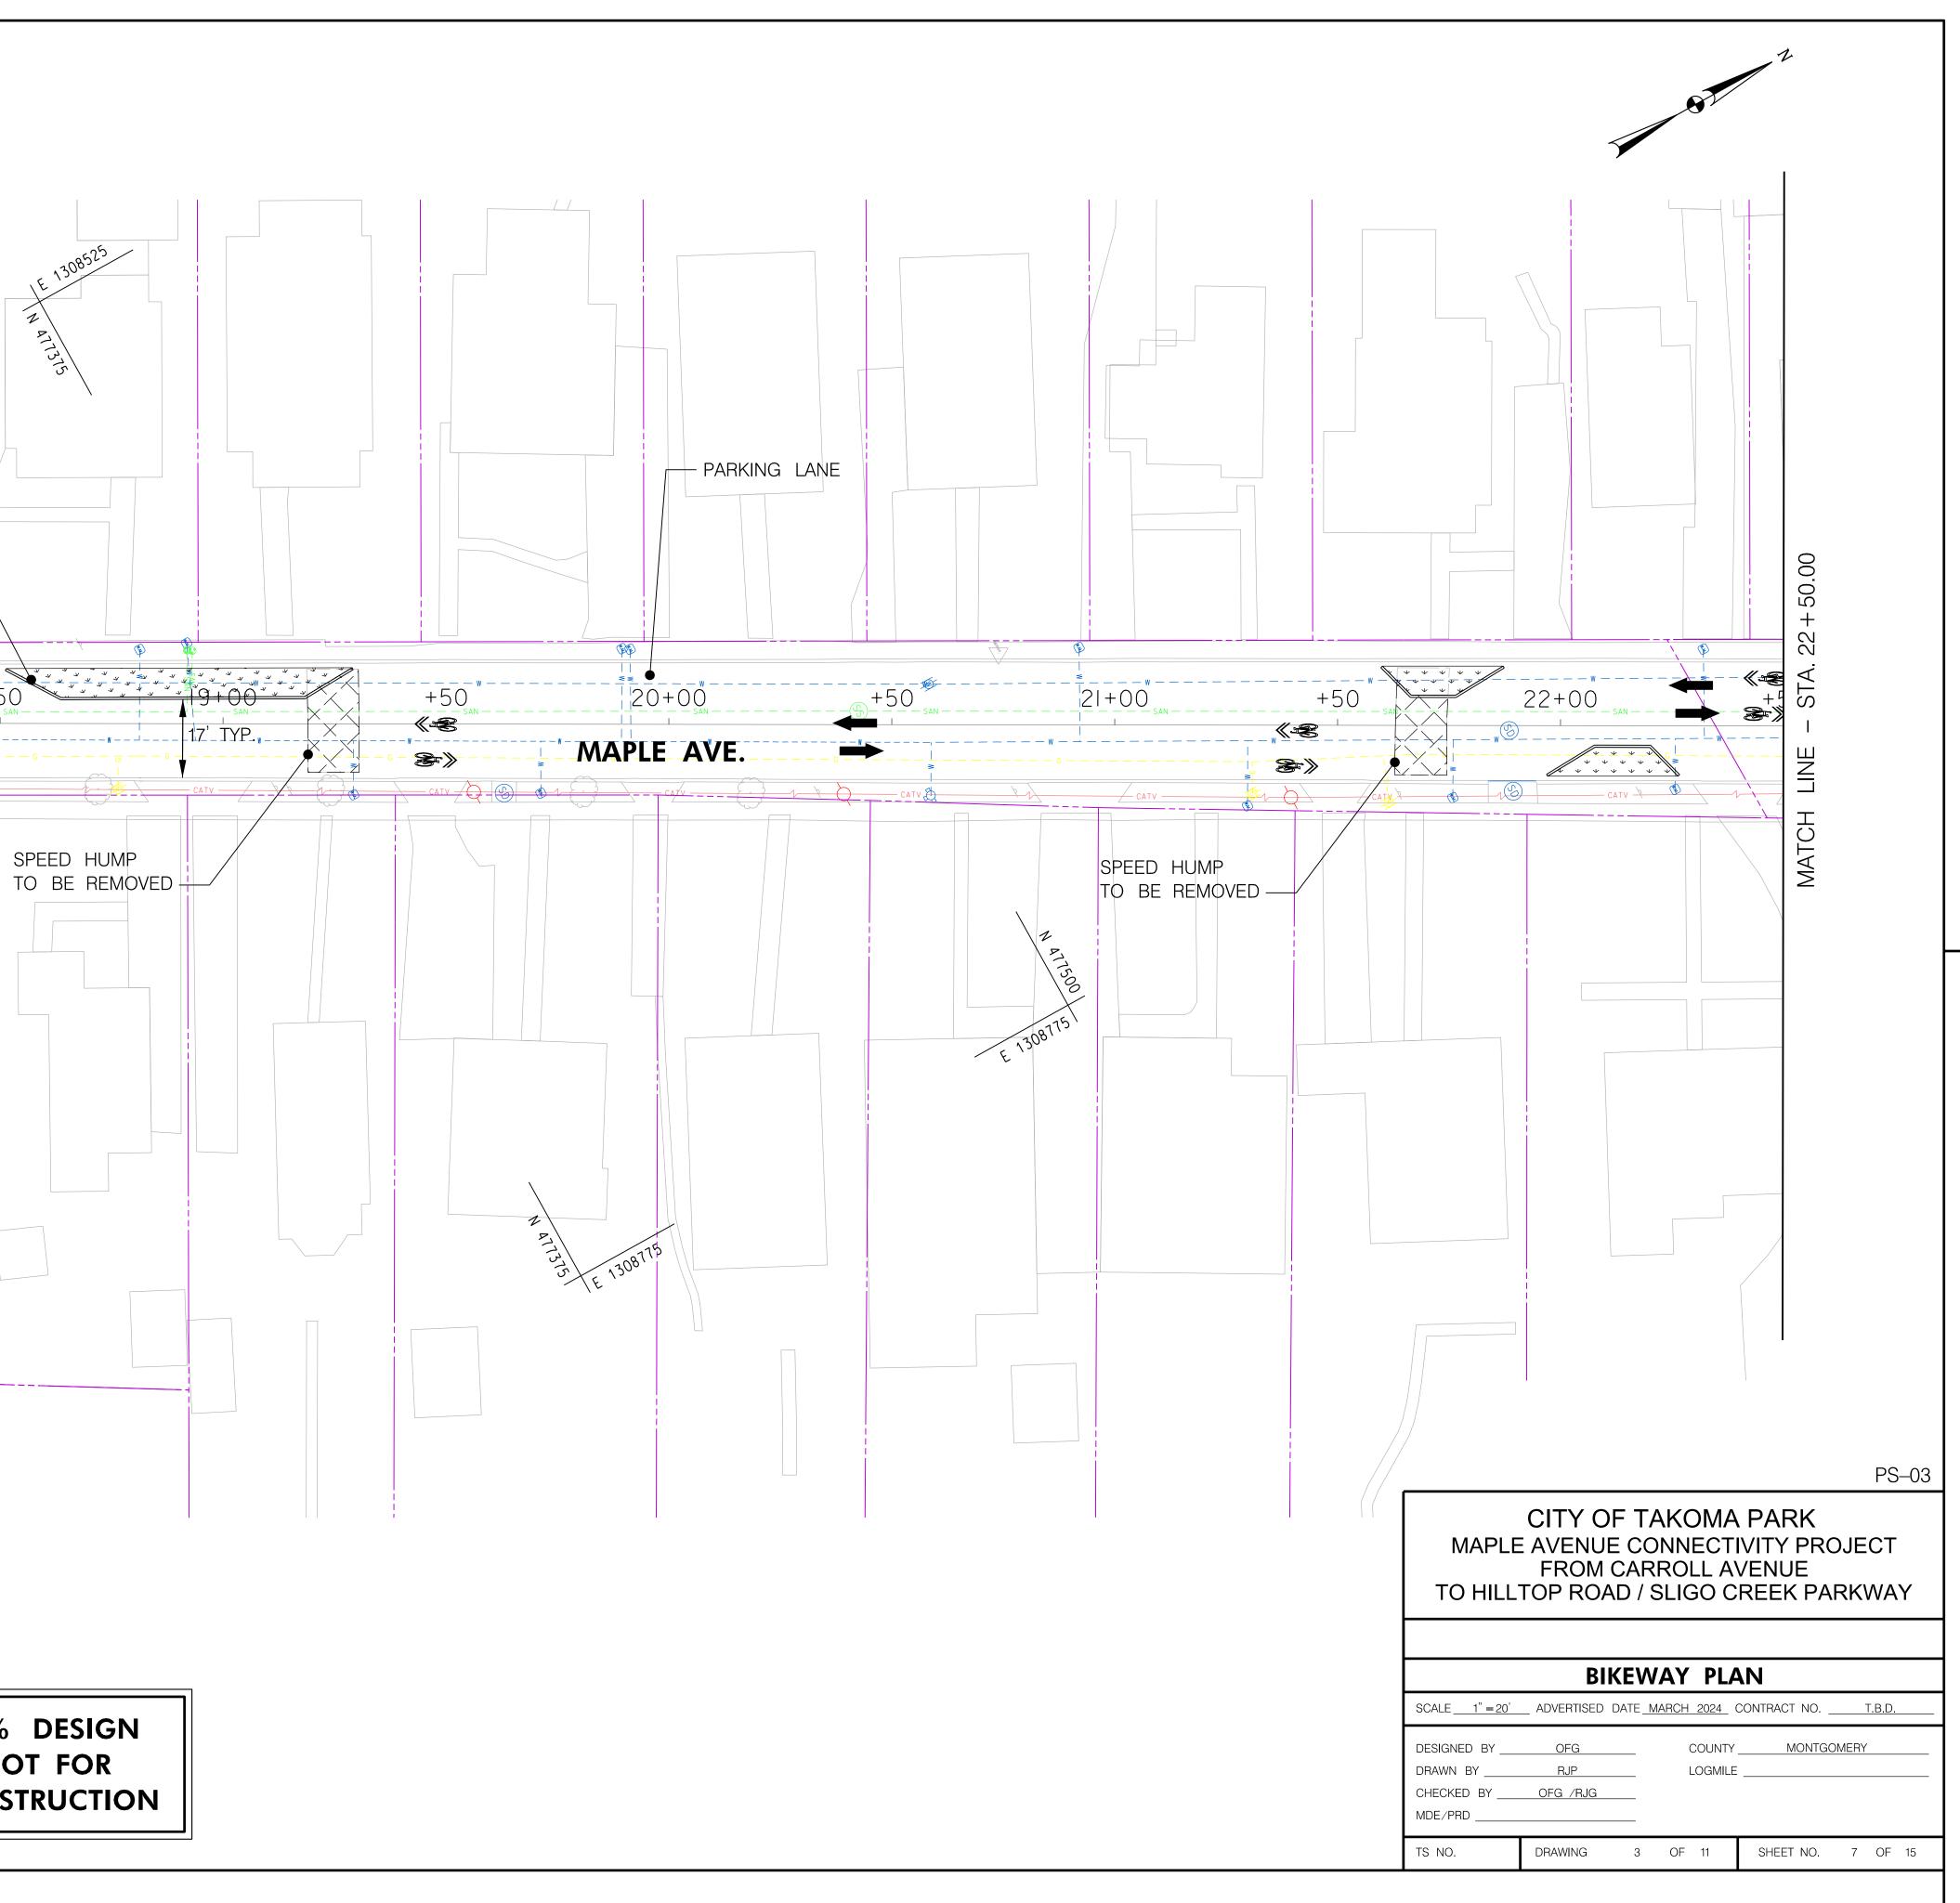
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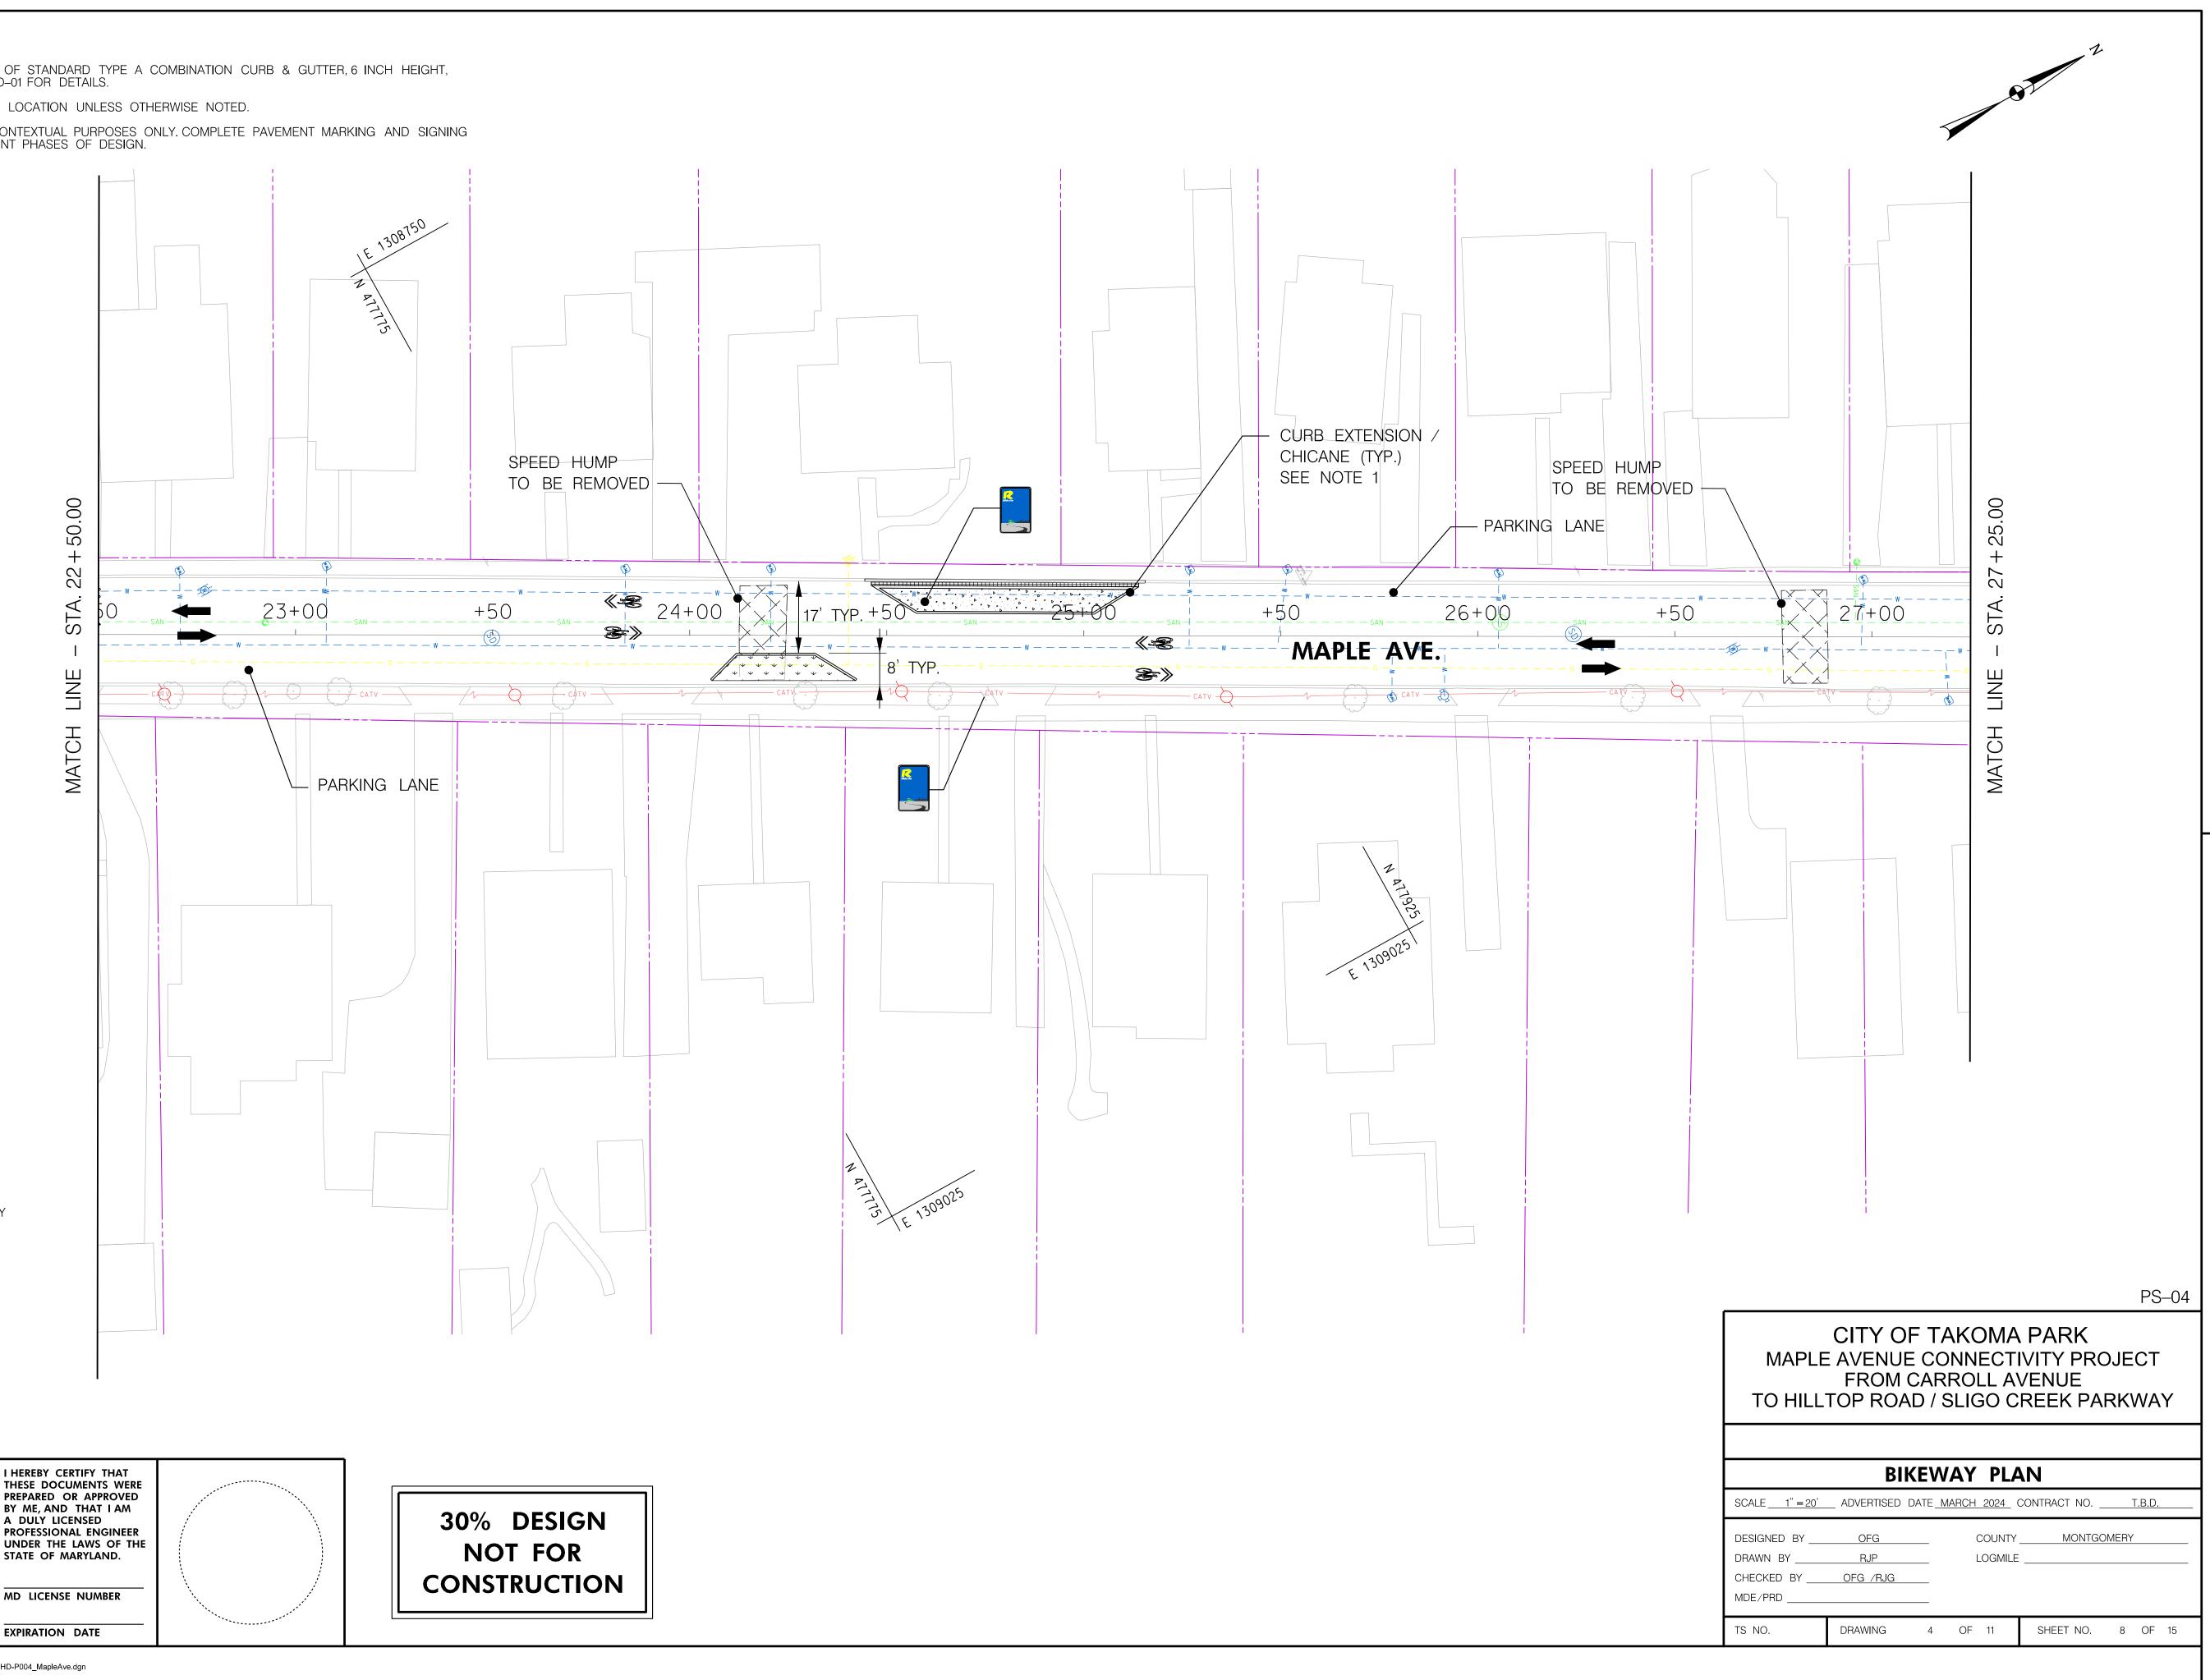


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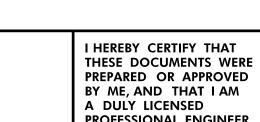
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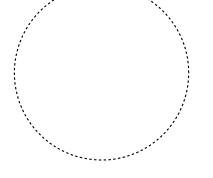
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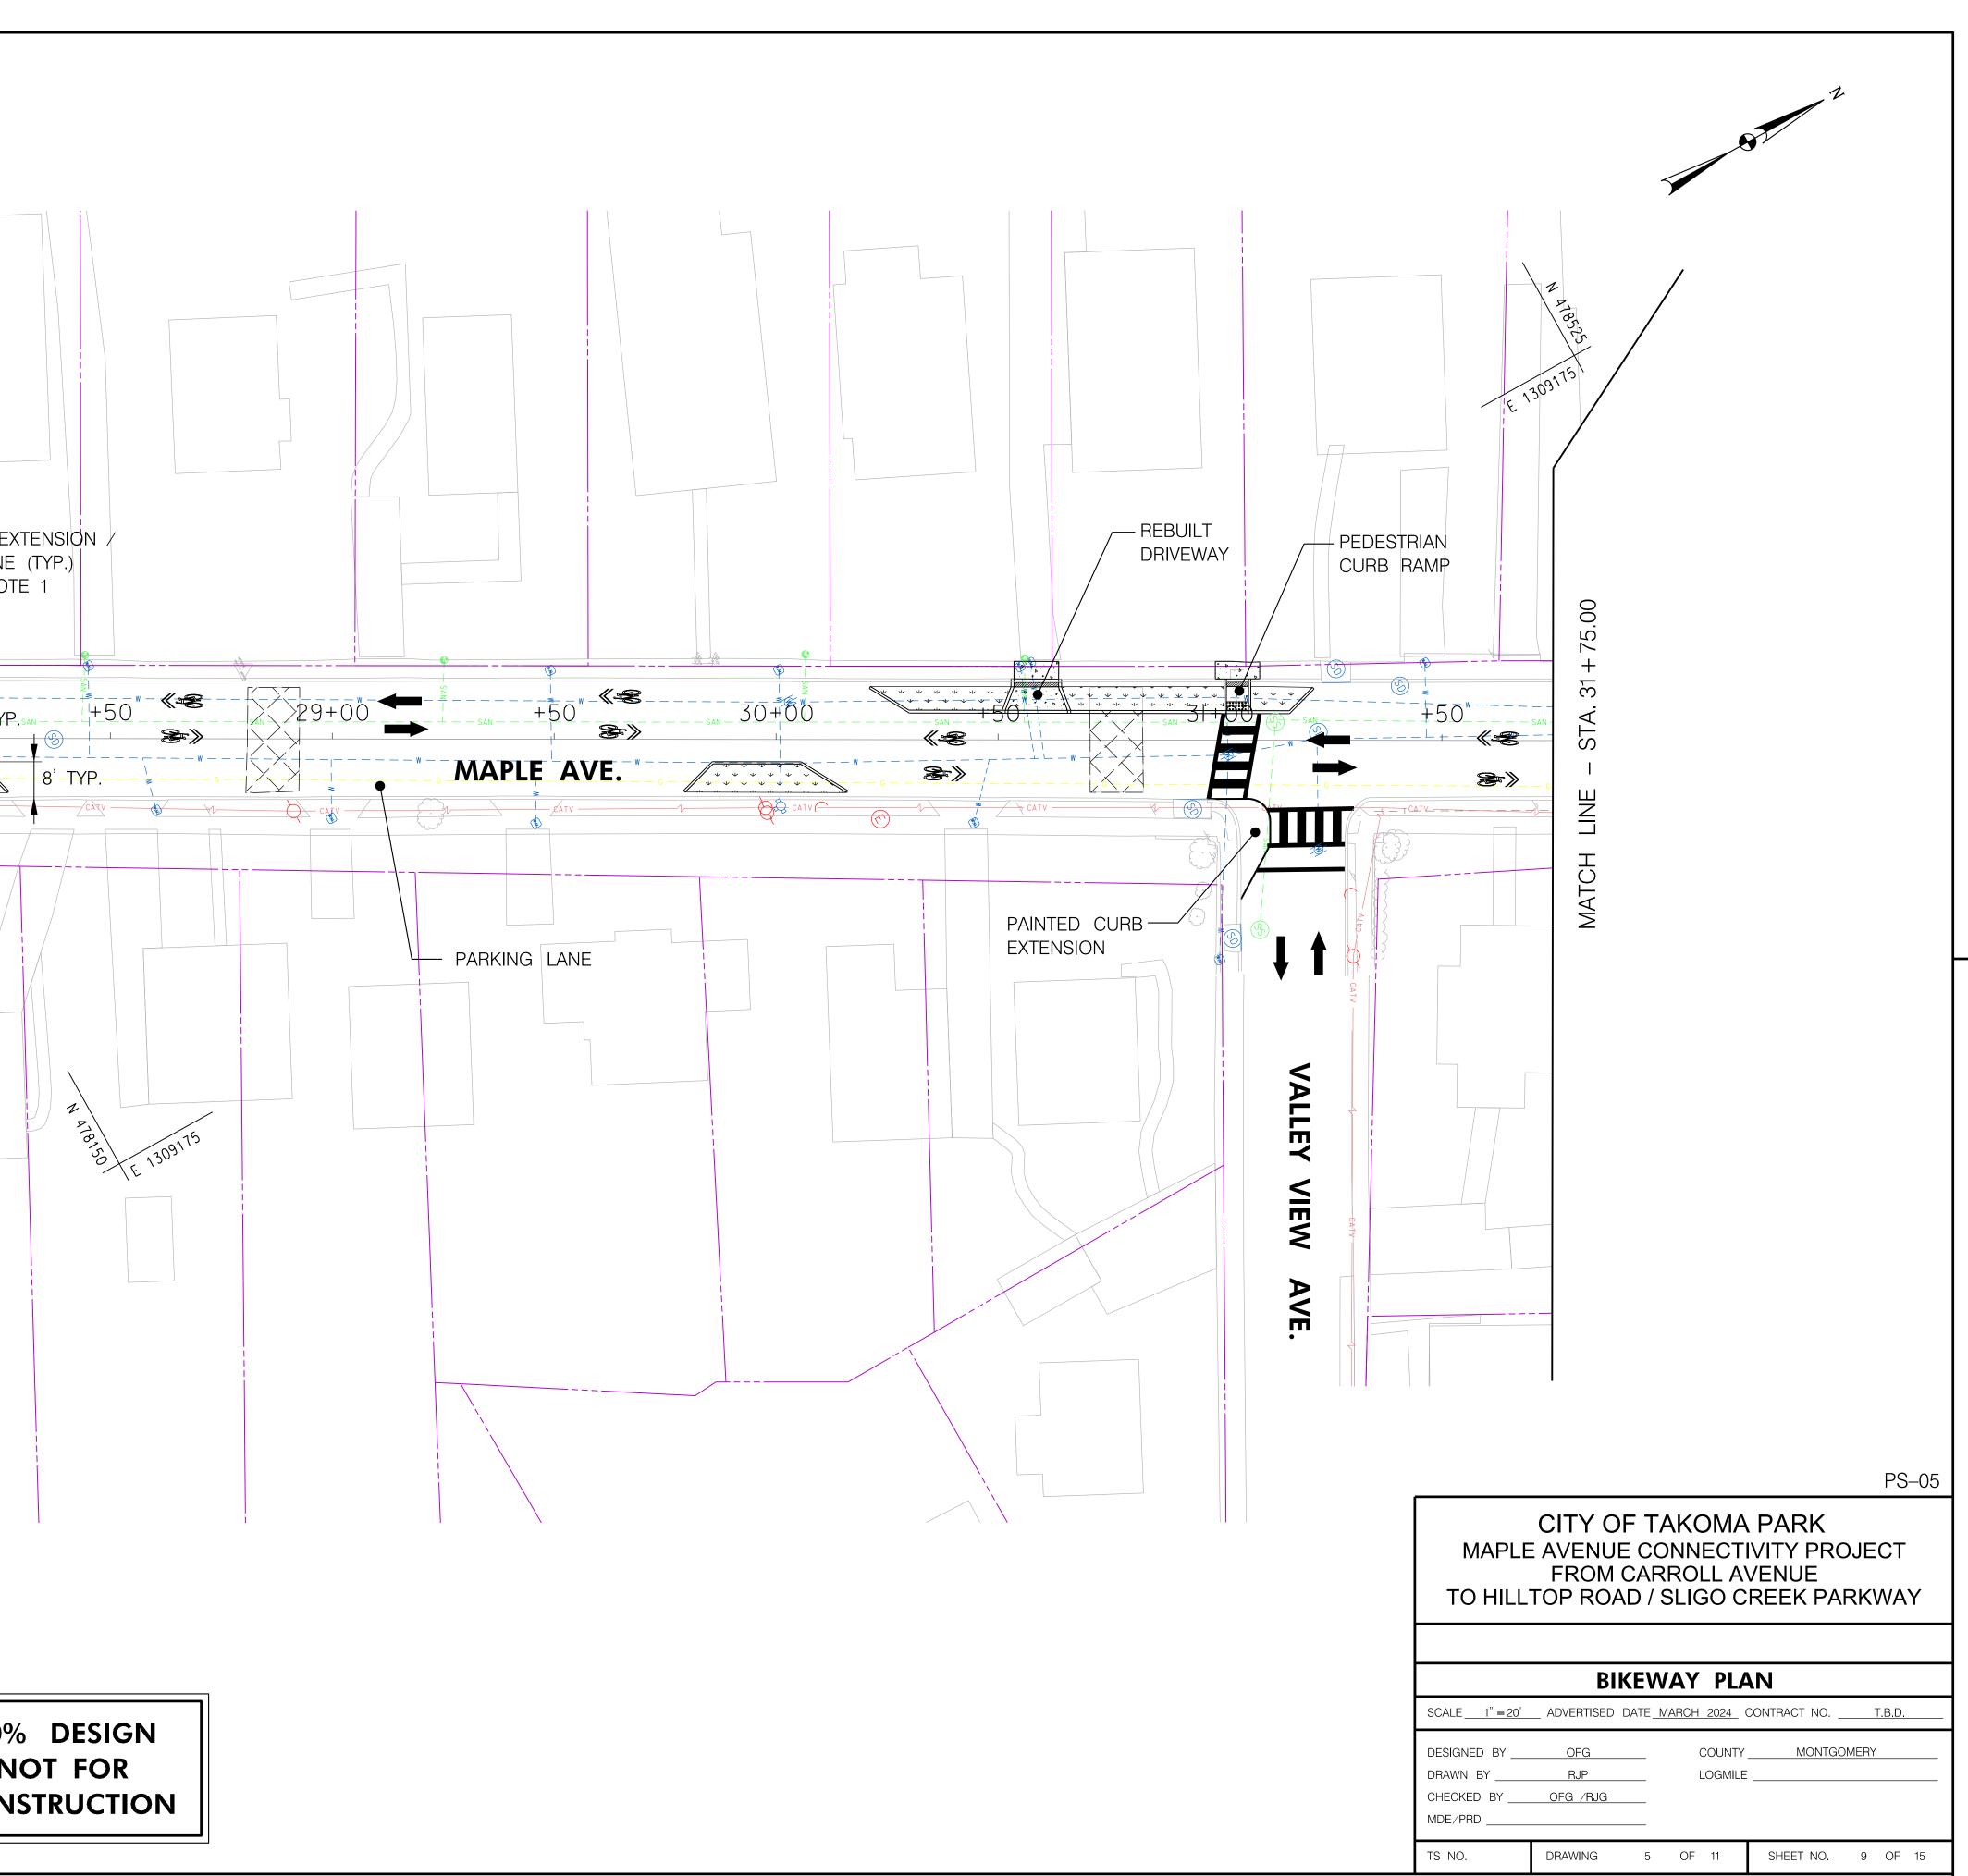
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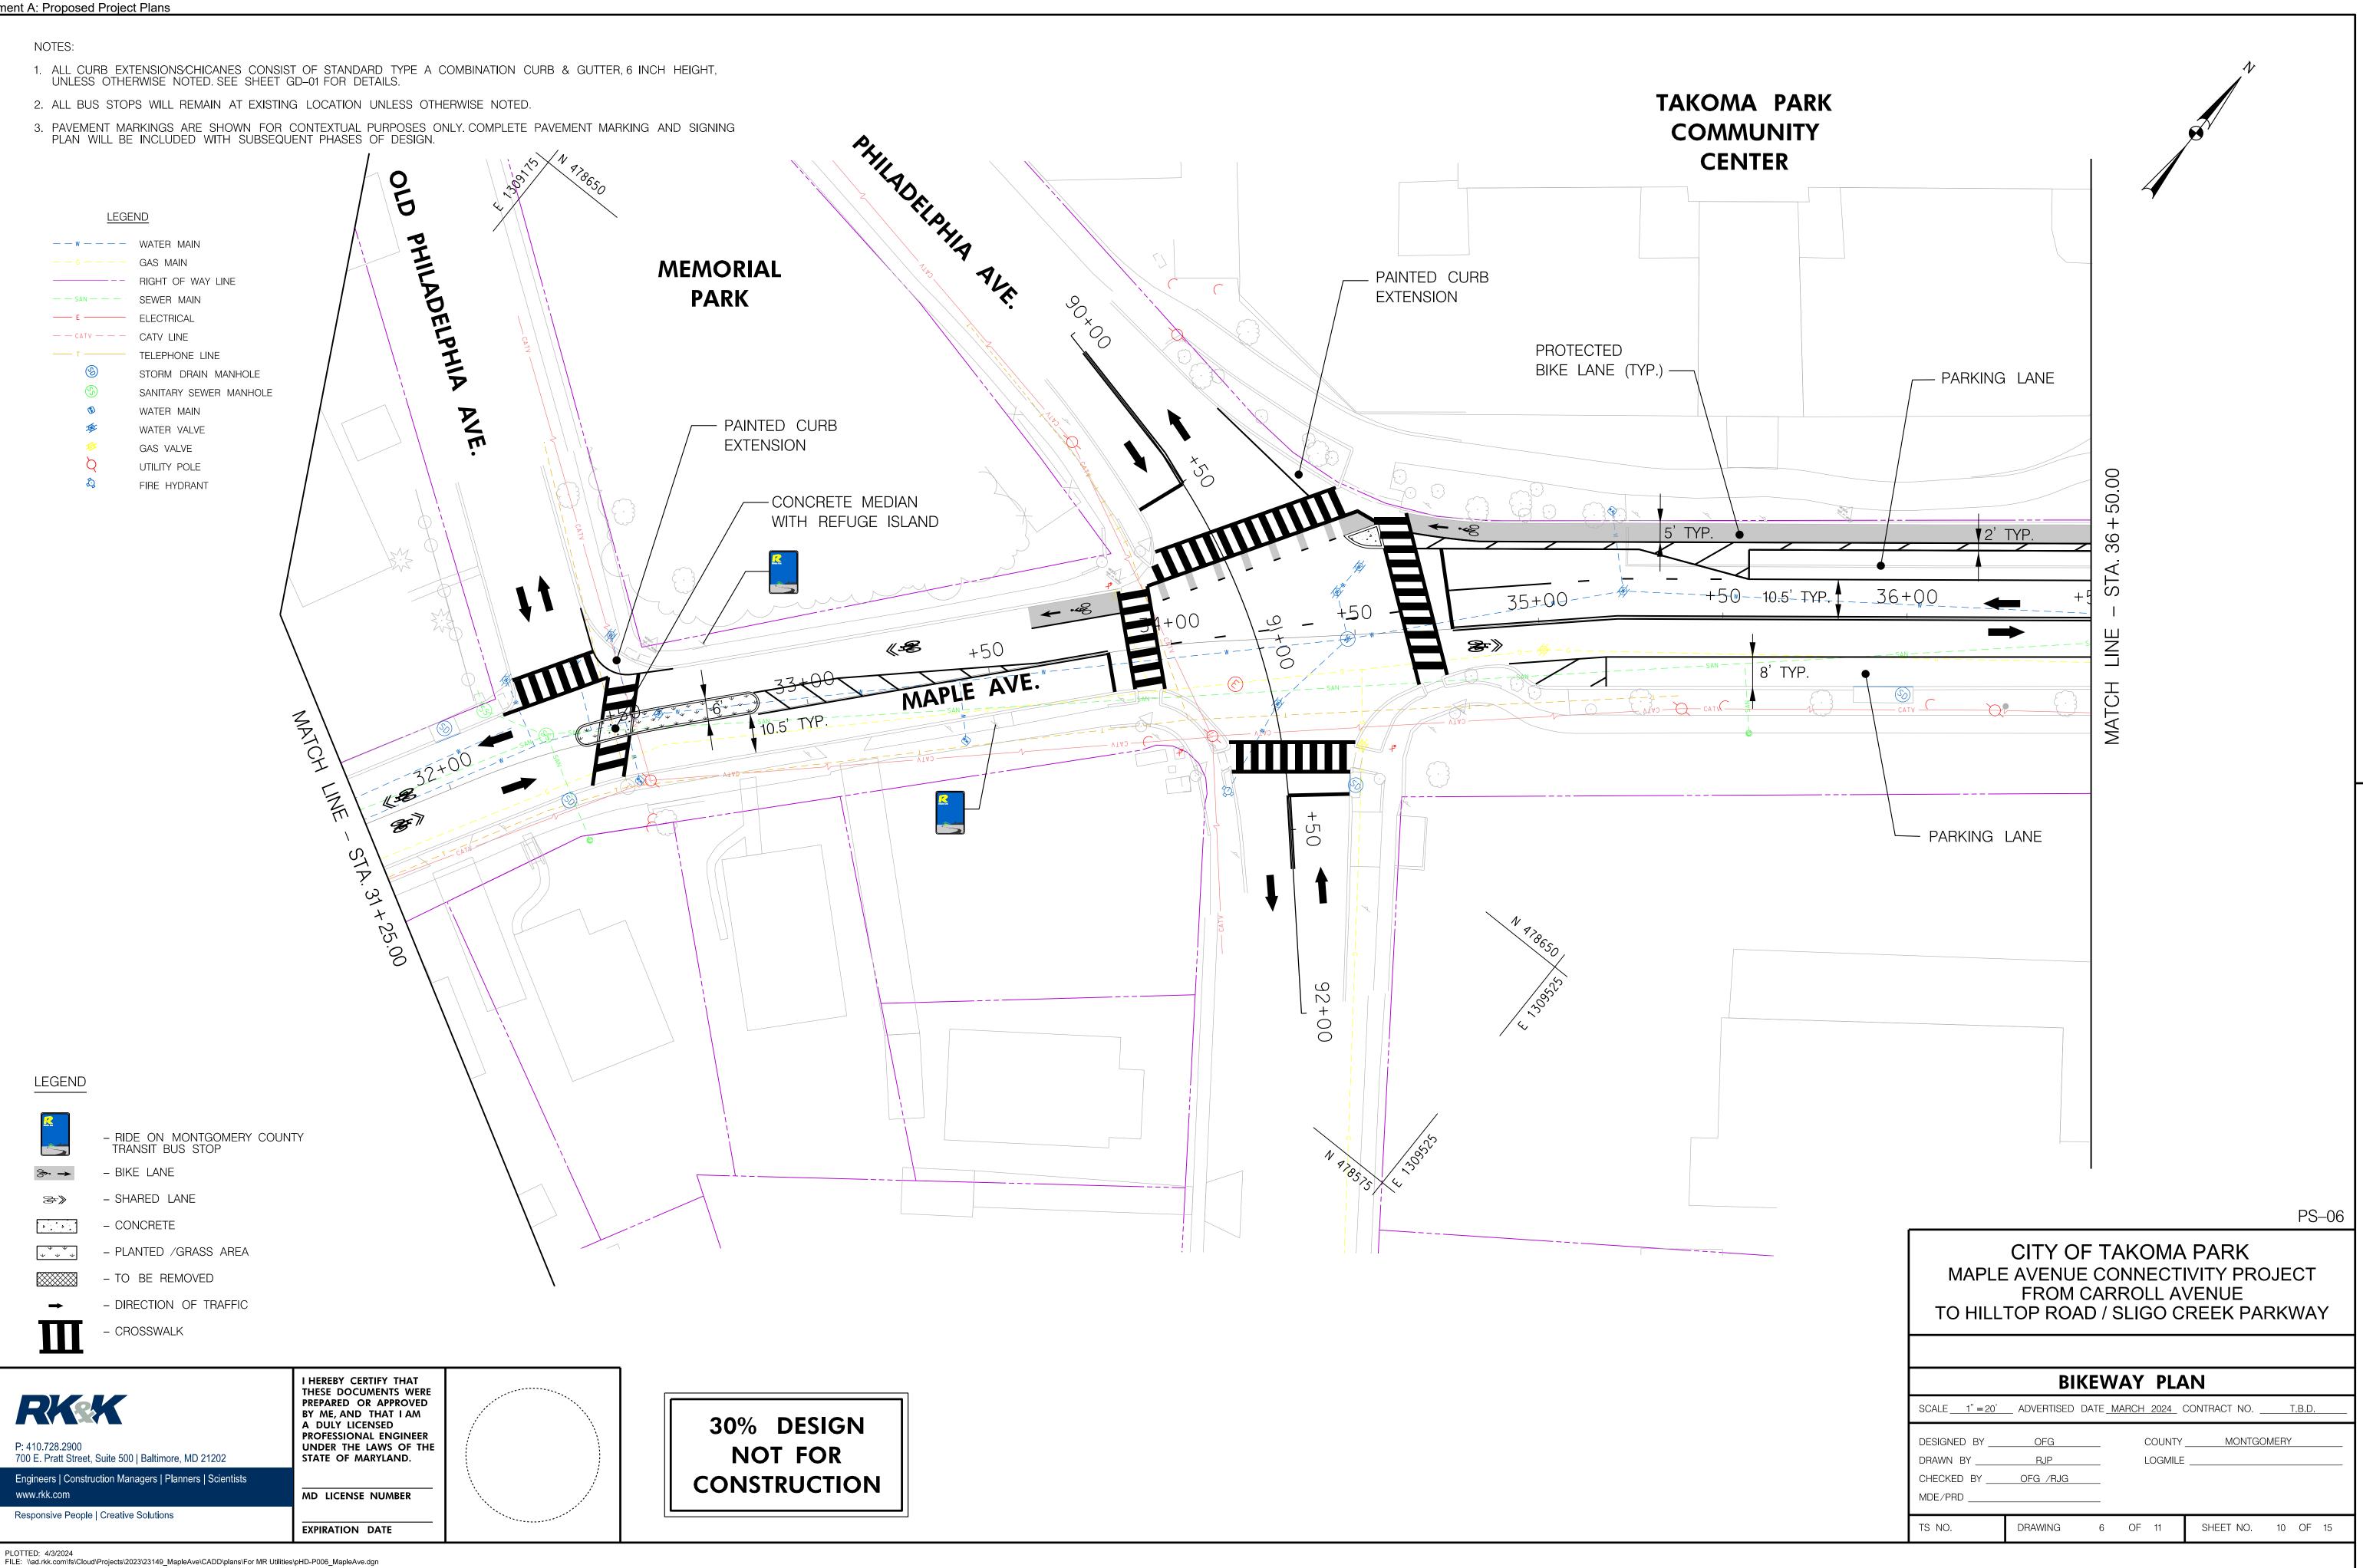
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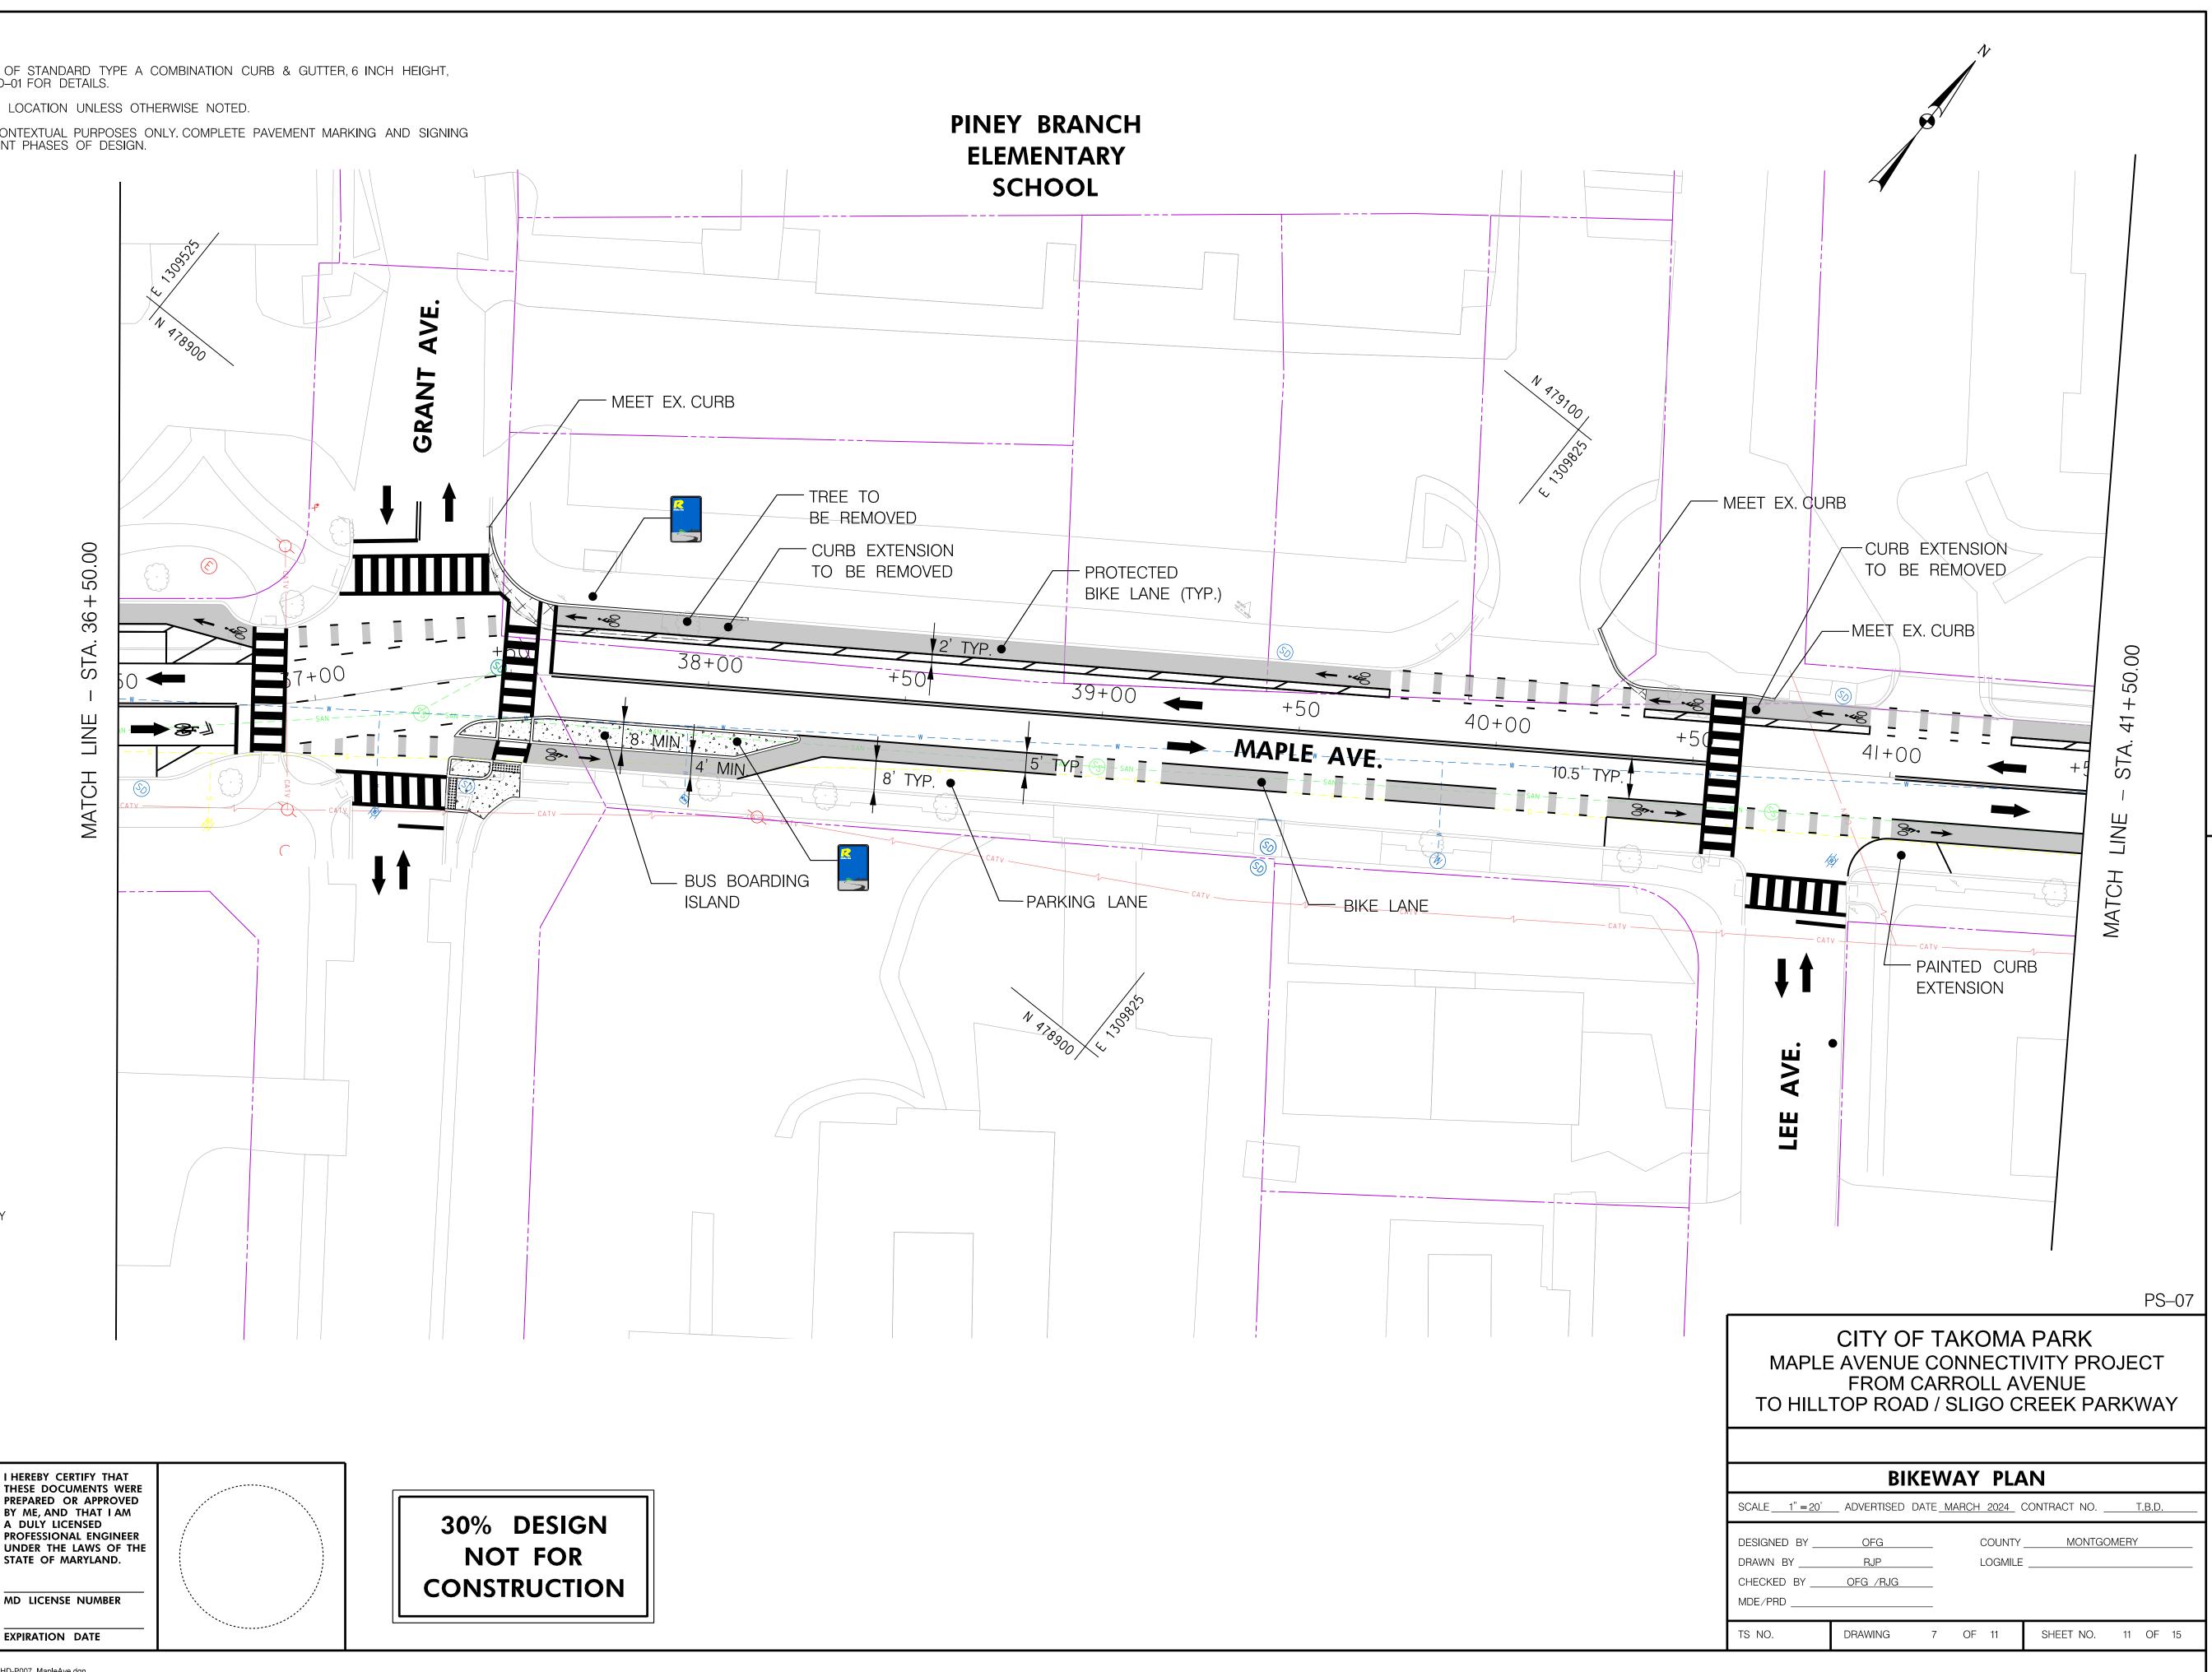


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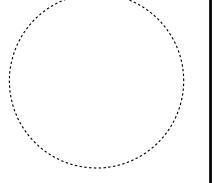
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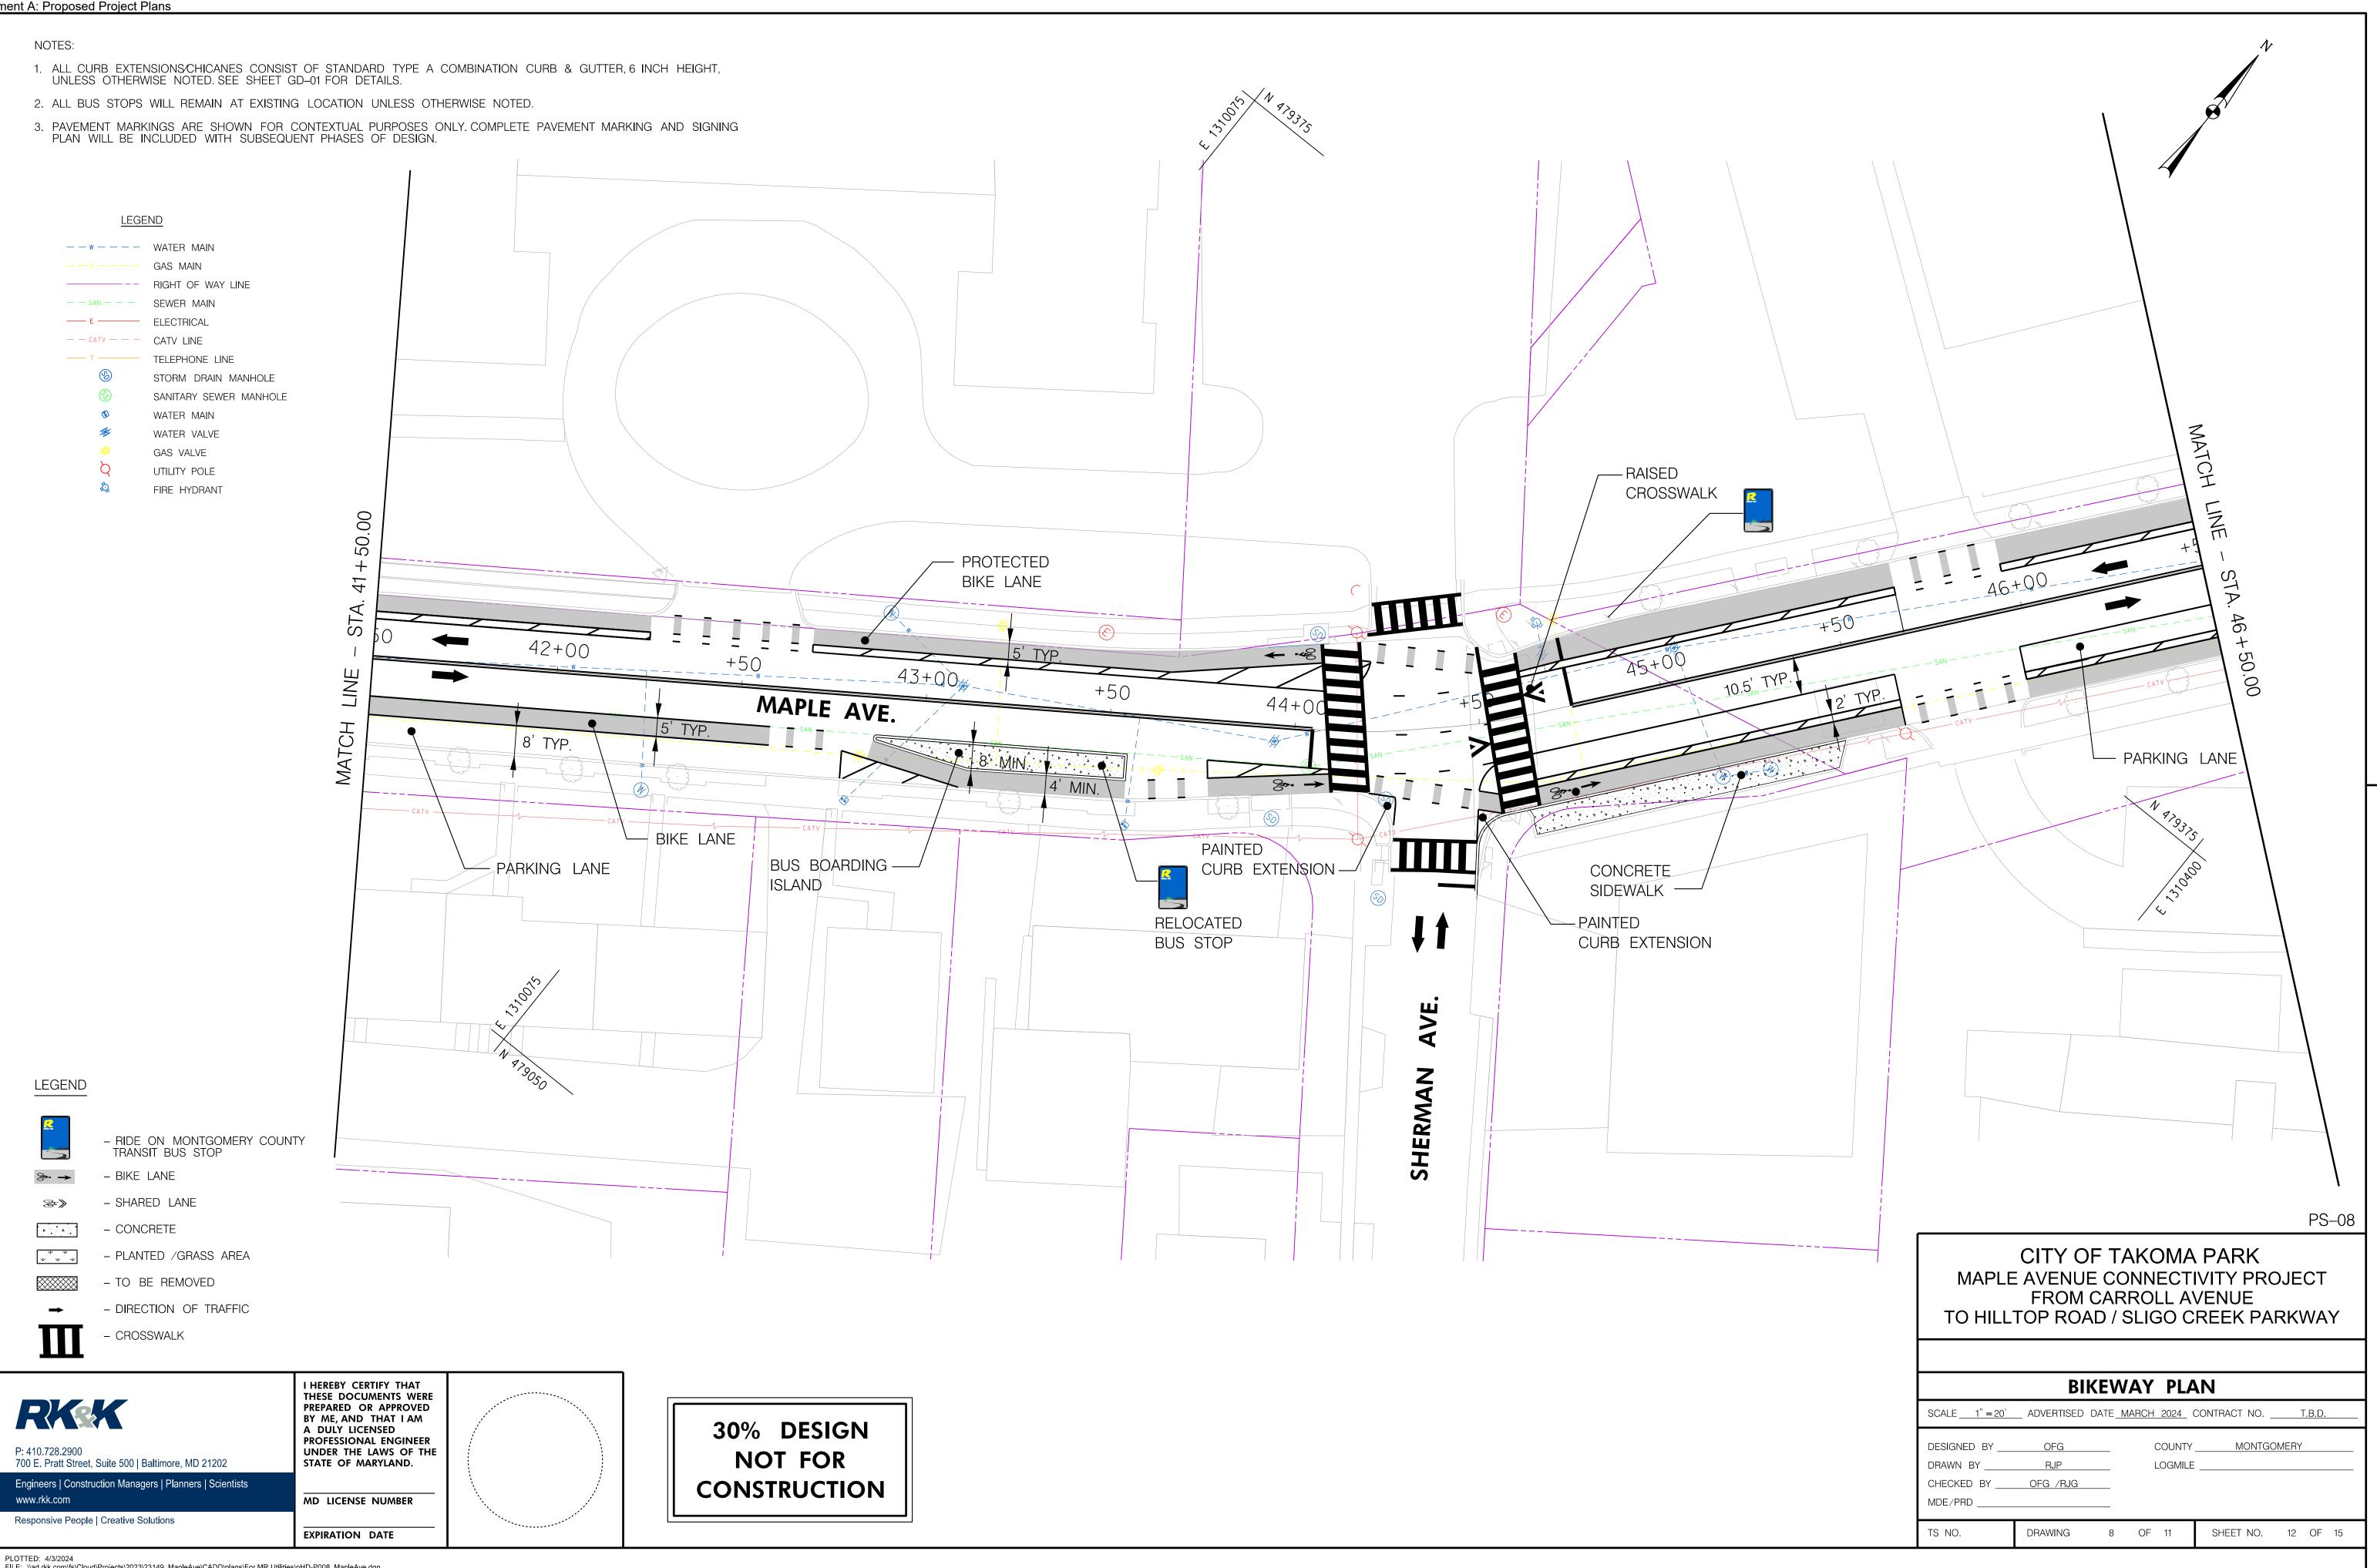


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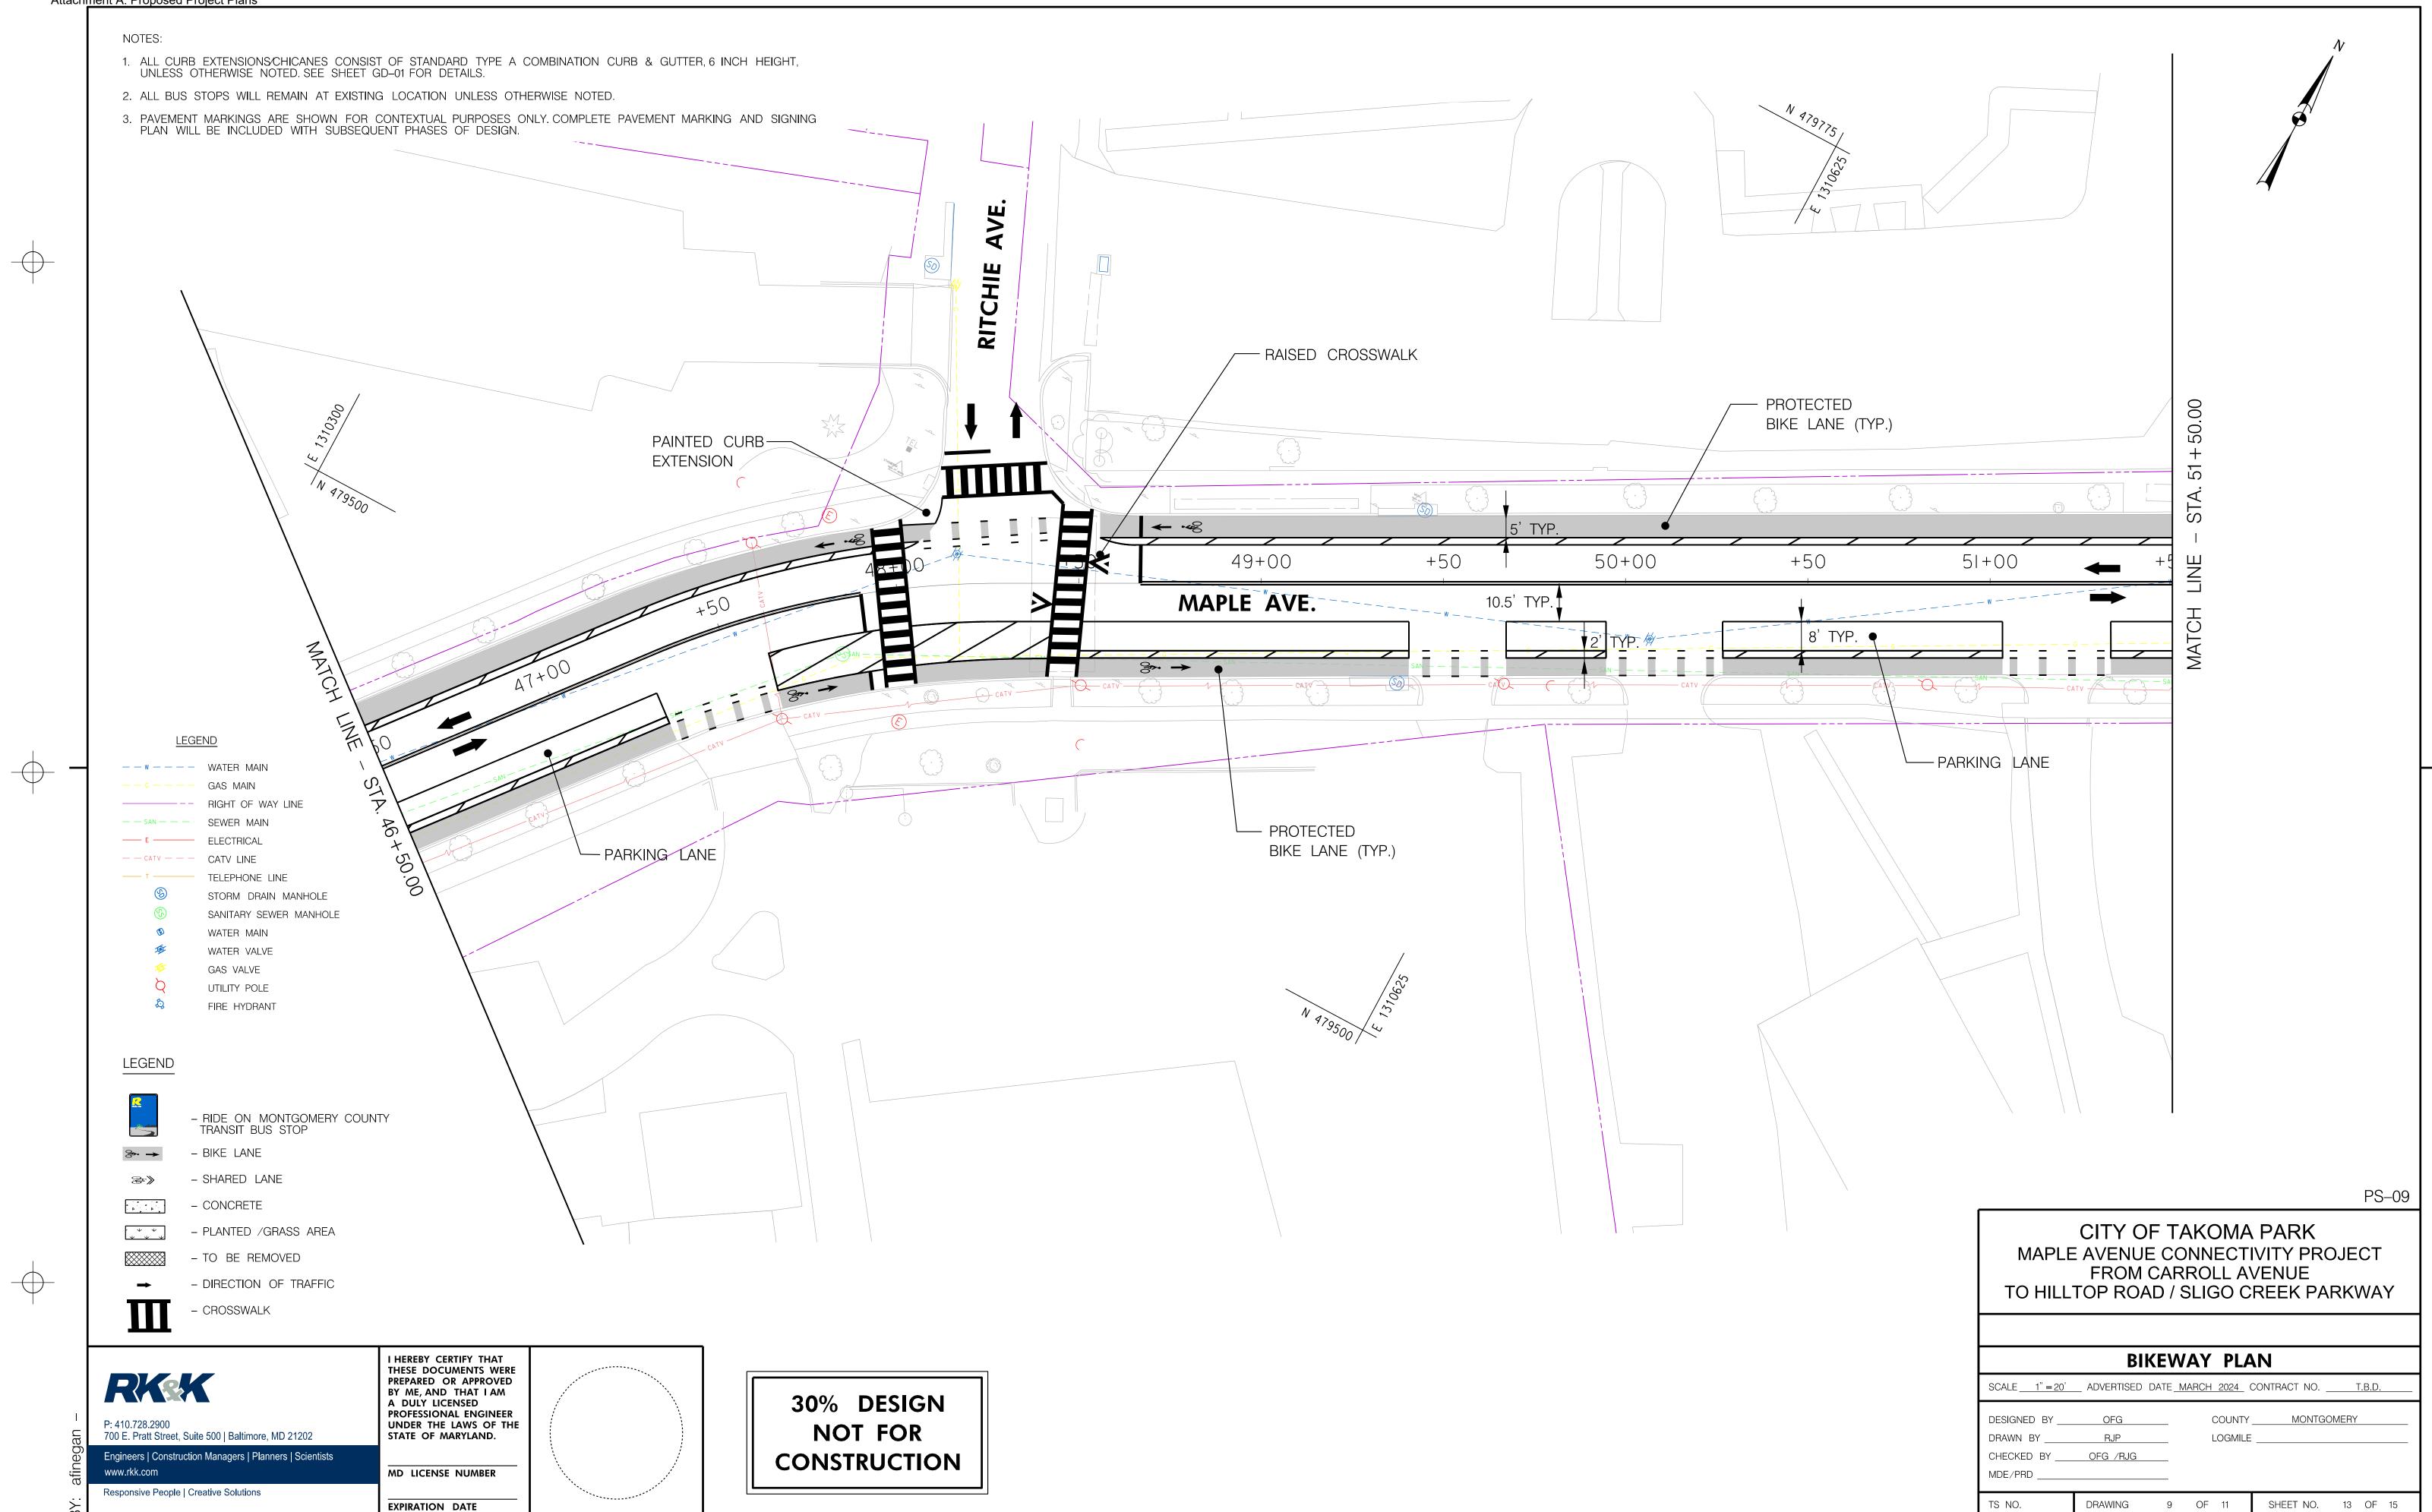
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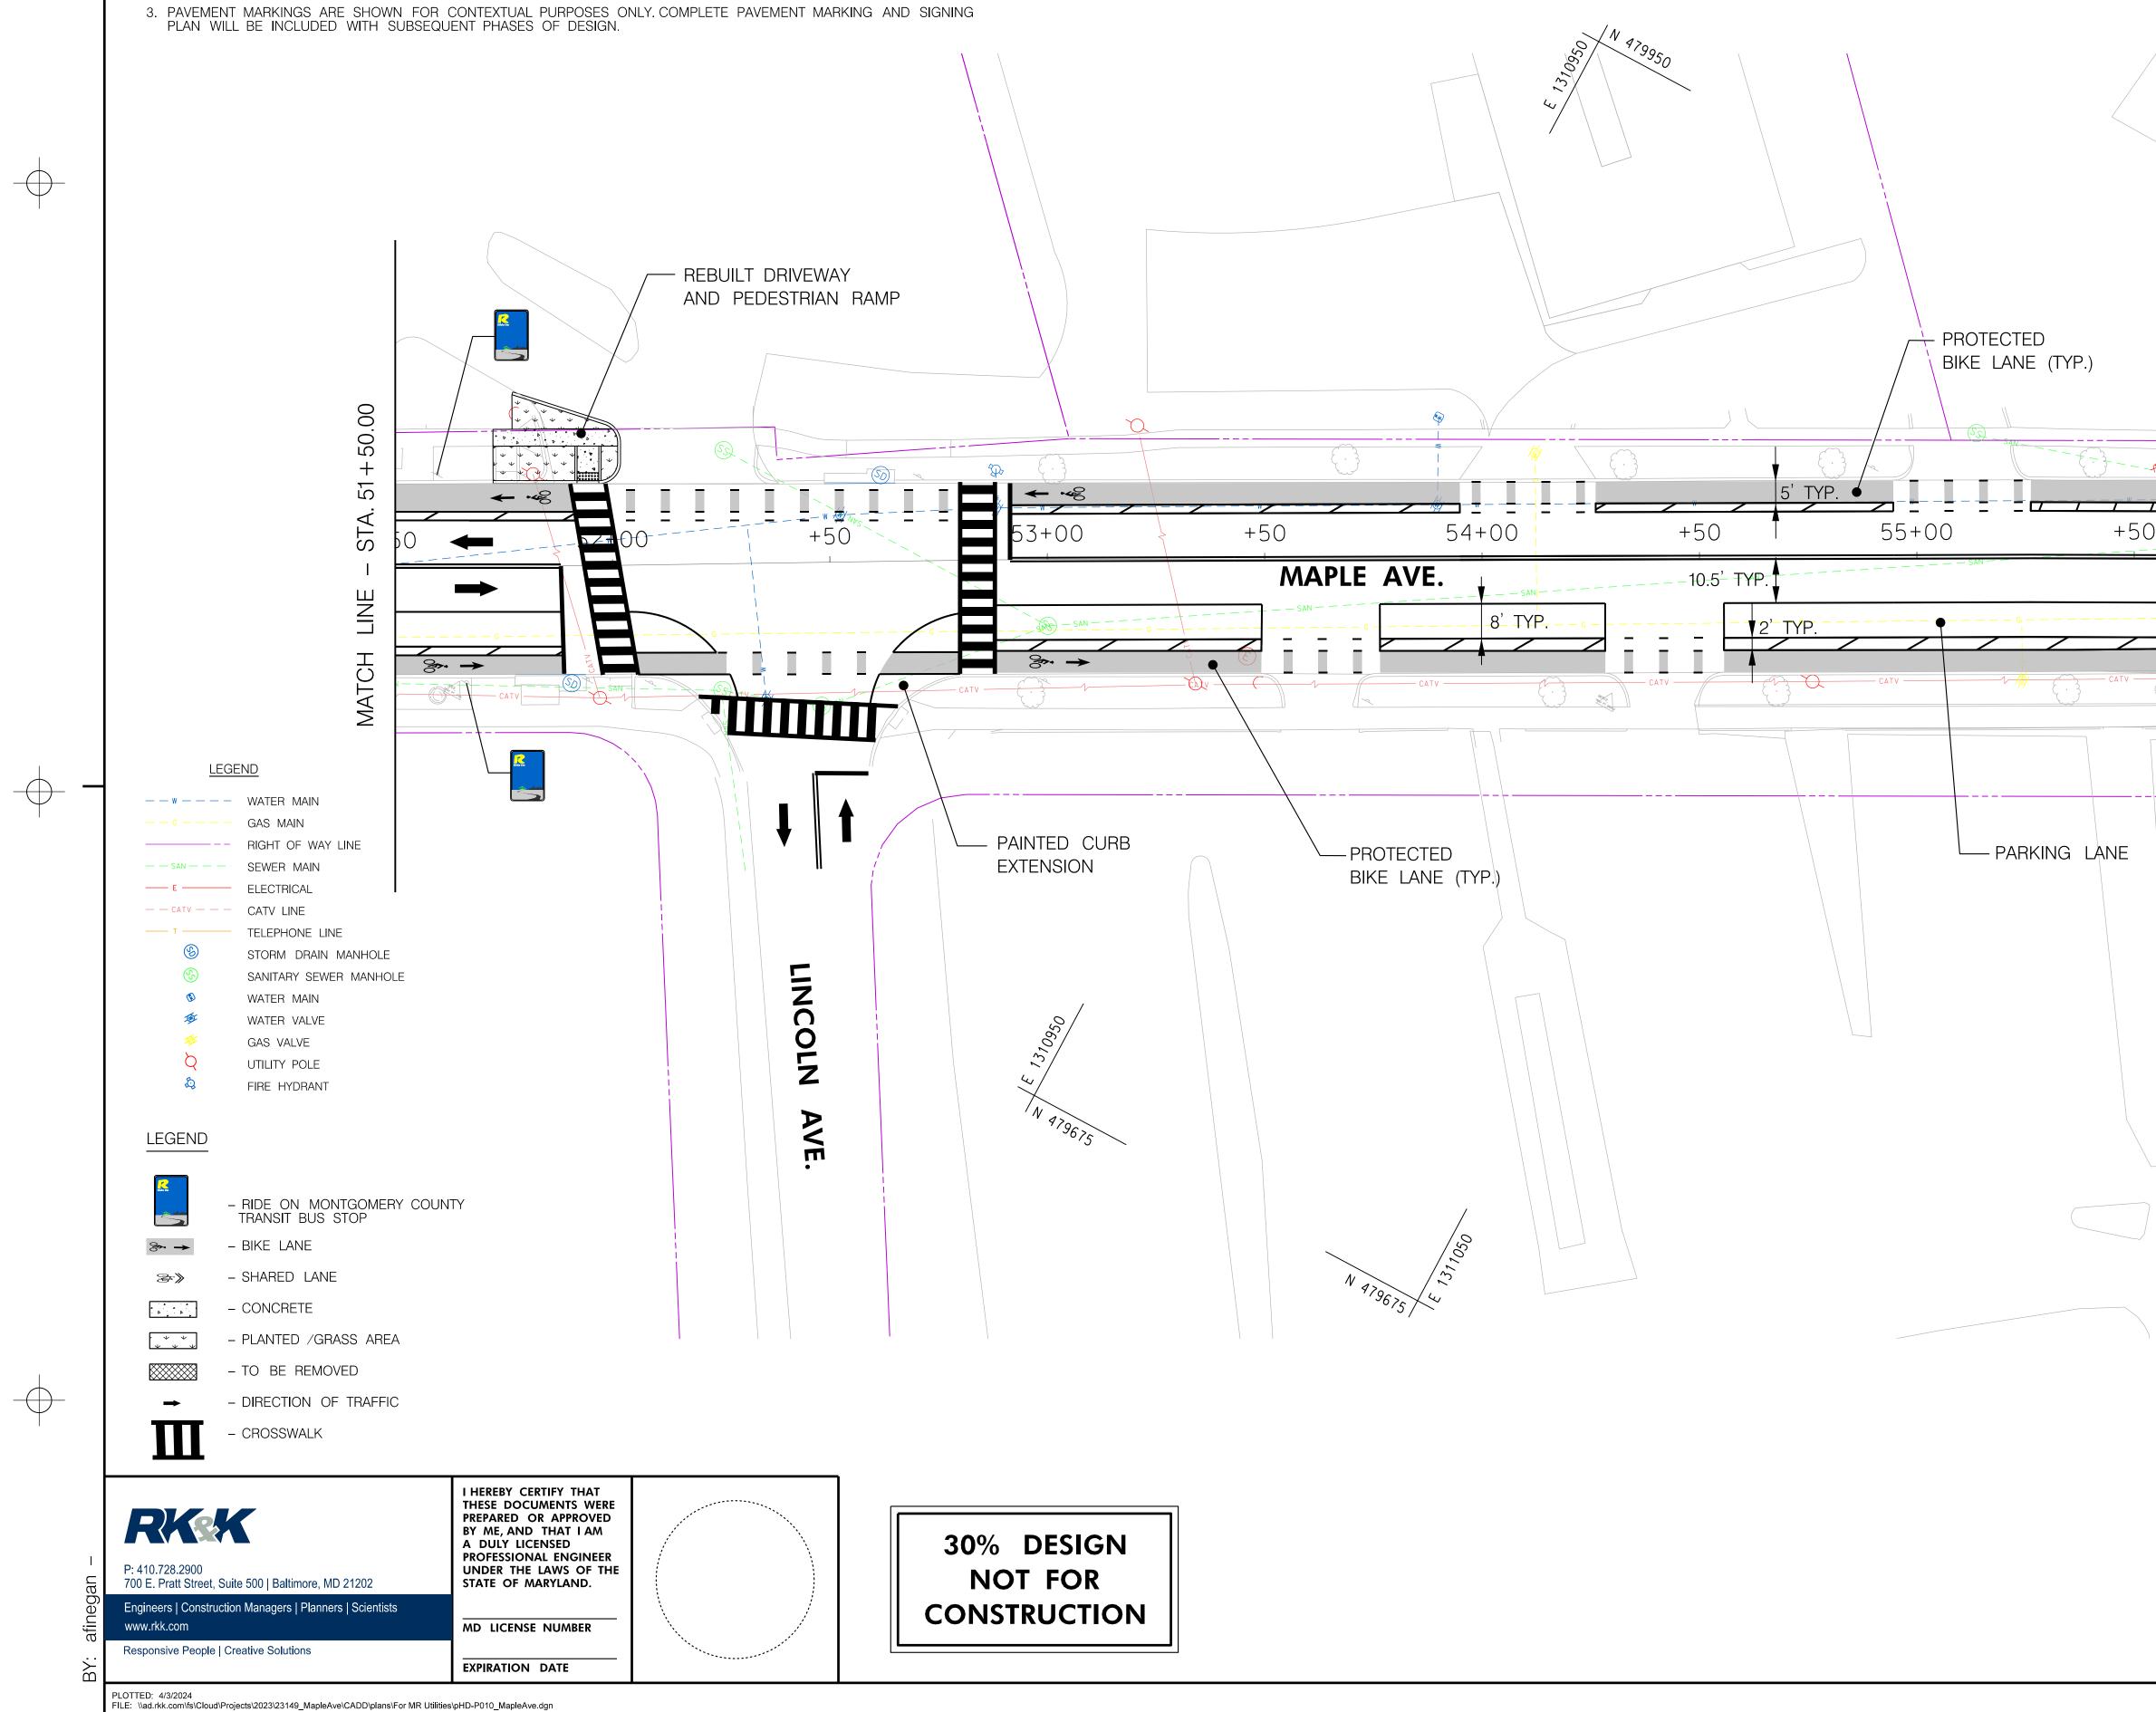
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BIKEWAY PLAN						
SCALE <u>1" = 20'</u>	ADVERTISED DA	TE <u>N</u>	MARCH 2024	CONTRACT NO	T.B.D.	
DESIGNED BY DRAWN BY CHECKED BY MDE/PRD	RJP OFG /RJG			MONTGC		
TS NO.	DRAWING	9	OF 11	SHEET NO.	13 OF 15	

- 1. ALL CURB EXTENSIONS/CHICANES CONSIST OF STANDARD TYPE A COMBINATION CURB & GUTTER, 6 INCH HEIGHT, UNLESS OTHERWISE NOTED. SEE SHEET GD-01 FOR DETAILS.
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PS-10

CITY OF TAKOMA PARK MAPLE AVENUE CONNECTIVITY PROJECT FROM CARROLL AVENUE TO HILLTOP ROAD / SLIGO CREEK PARKWAY

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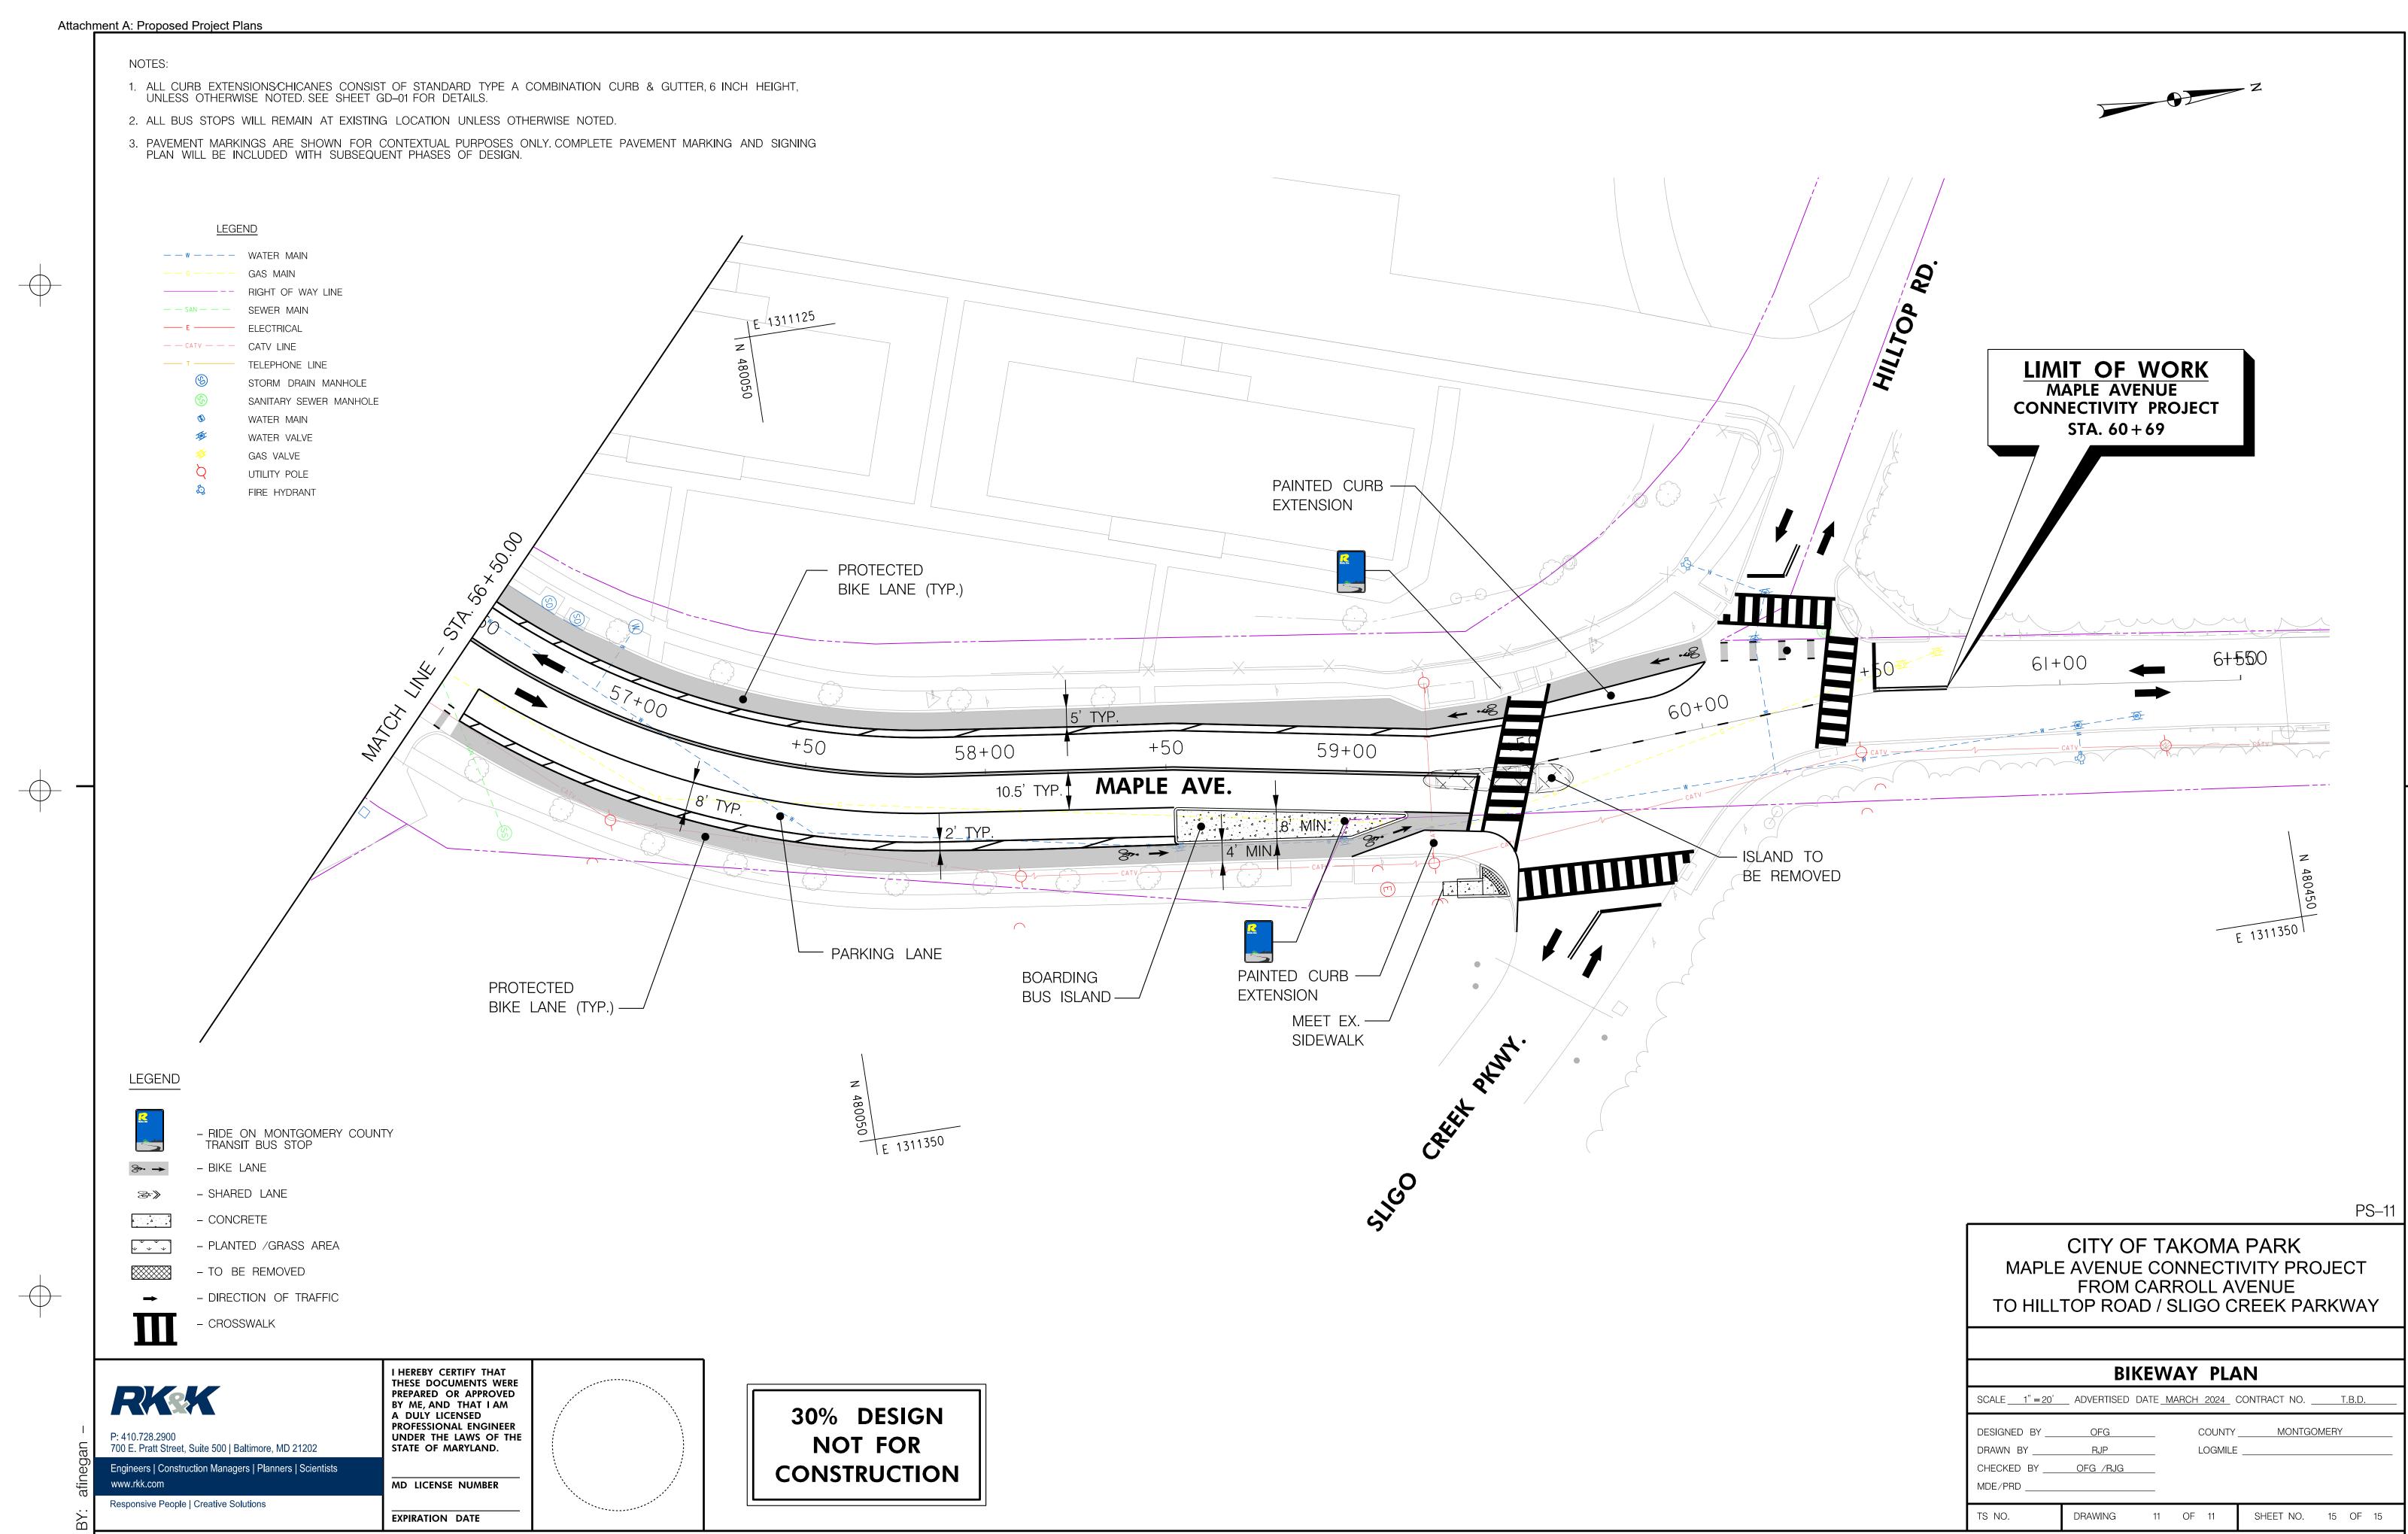
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BIKEWAY PLAN						
SCALE <u>1" = 20</u>	ADVERTISED	DATE_ <u>N</u>	MARCH 2024	CONTRACT NO	T.B.D.	
DESIGNED BY DRAWN BY CHECKED BY MDE/PRD	RJP OFG /RJG			/MONTGC		
TS NO.	DRAWING	10	OF 11	SHEET NO.	14 OF 15	

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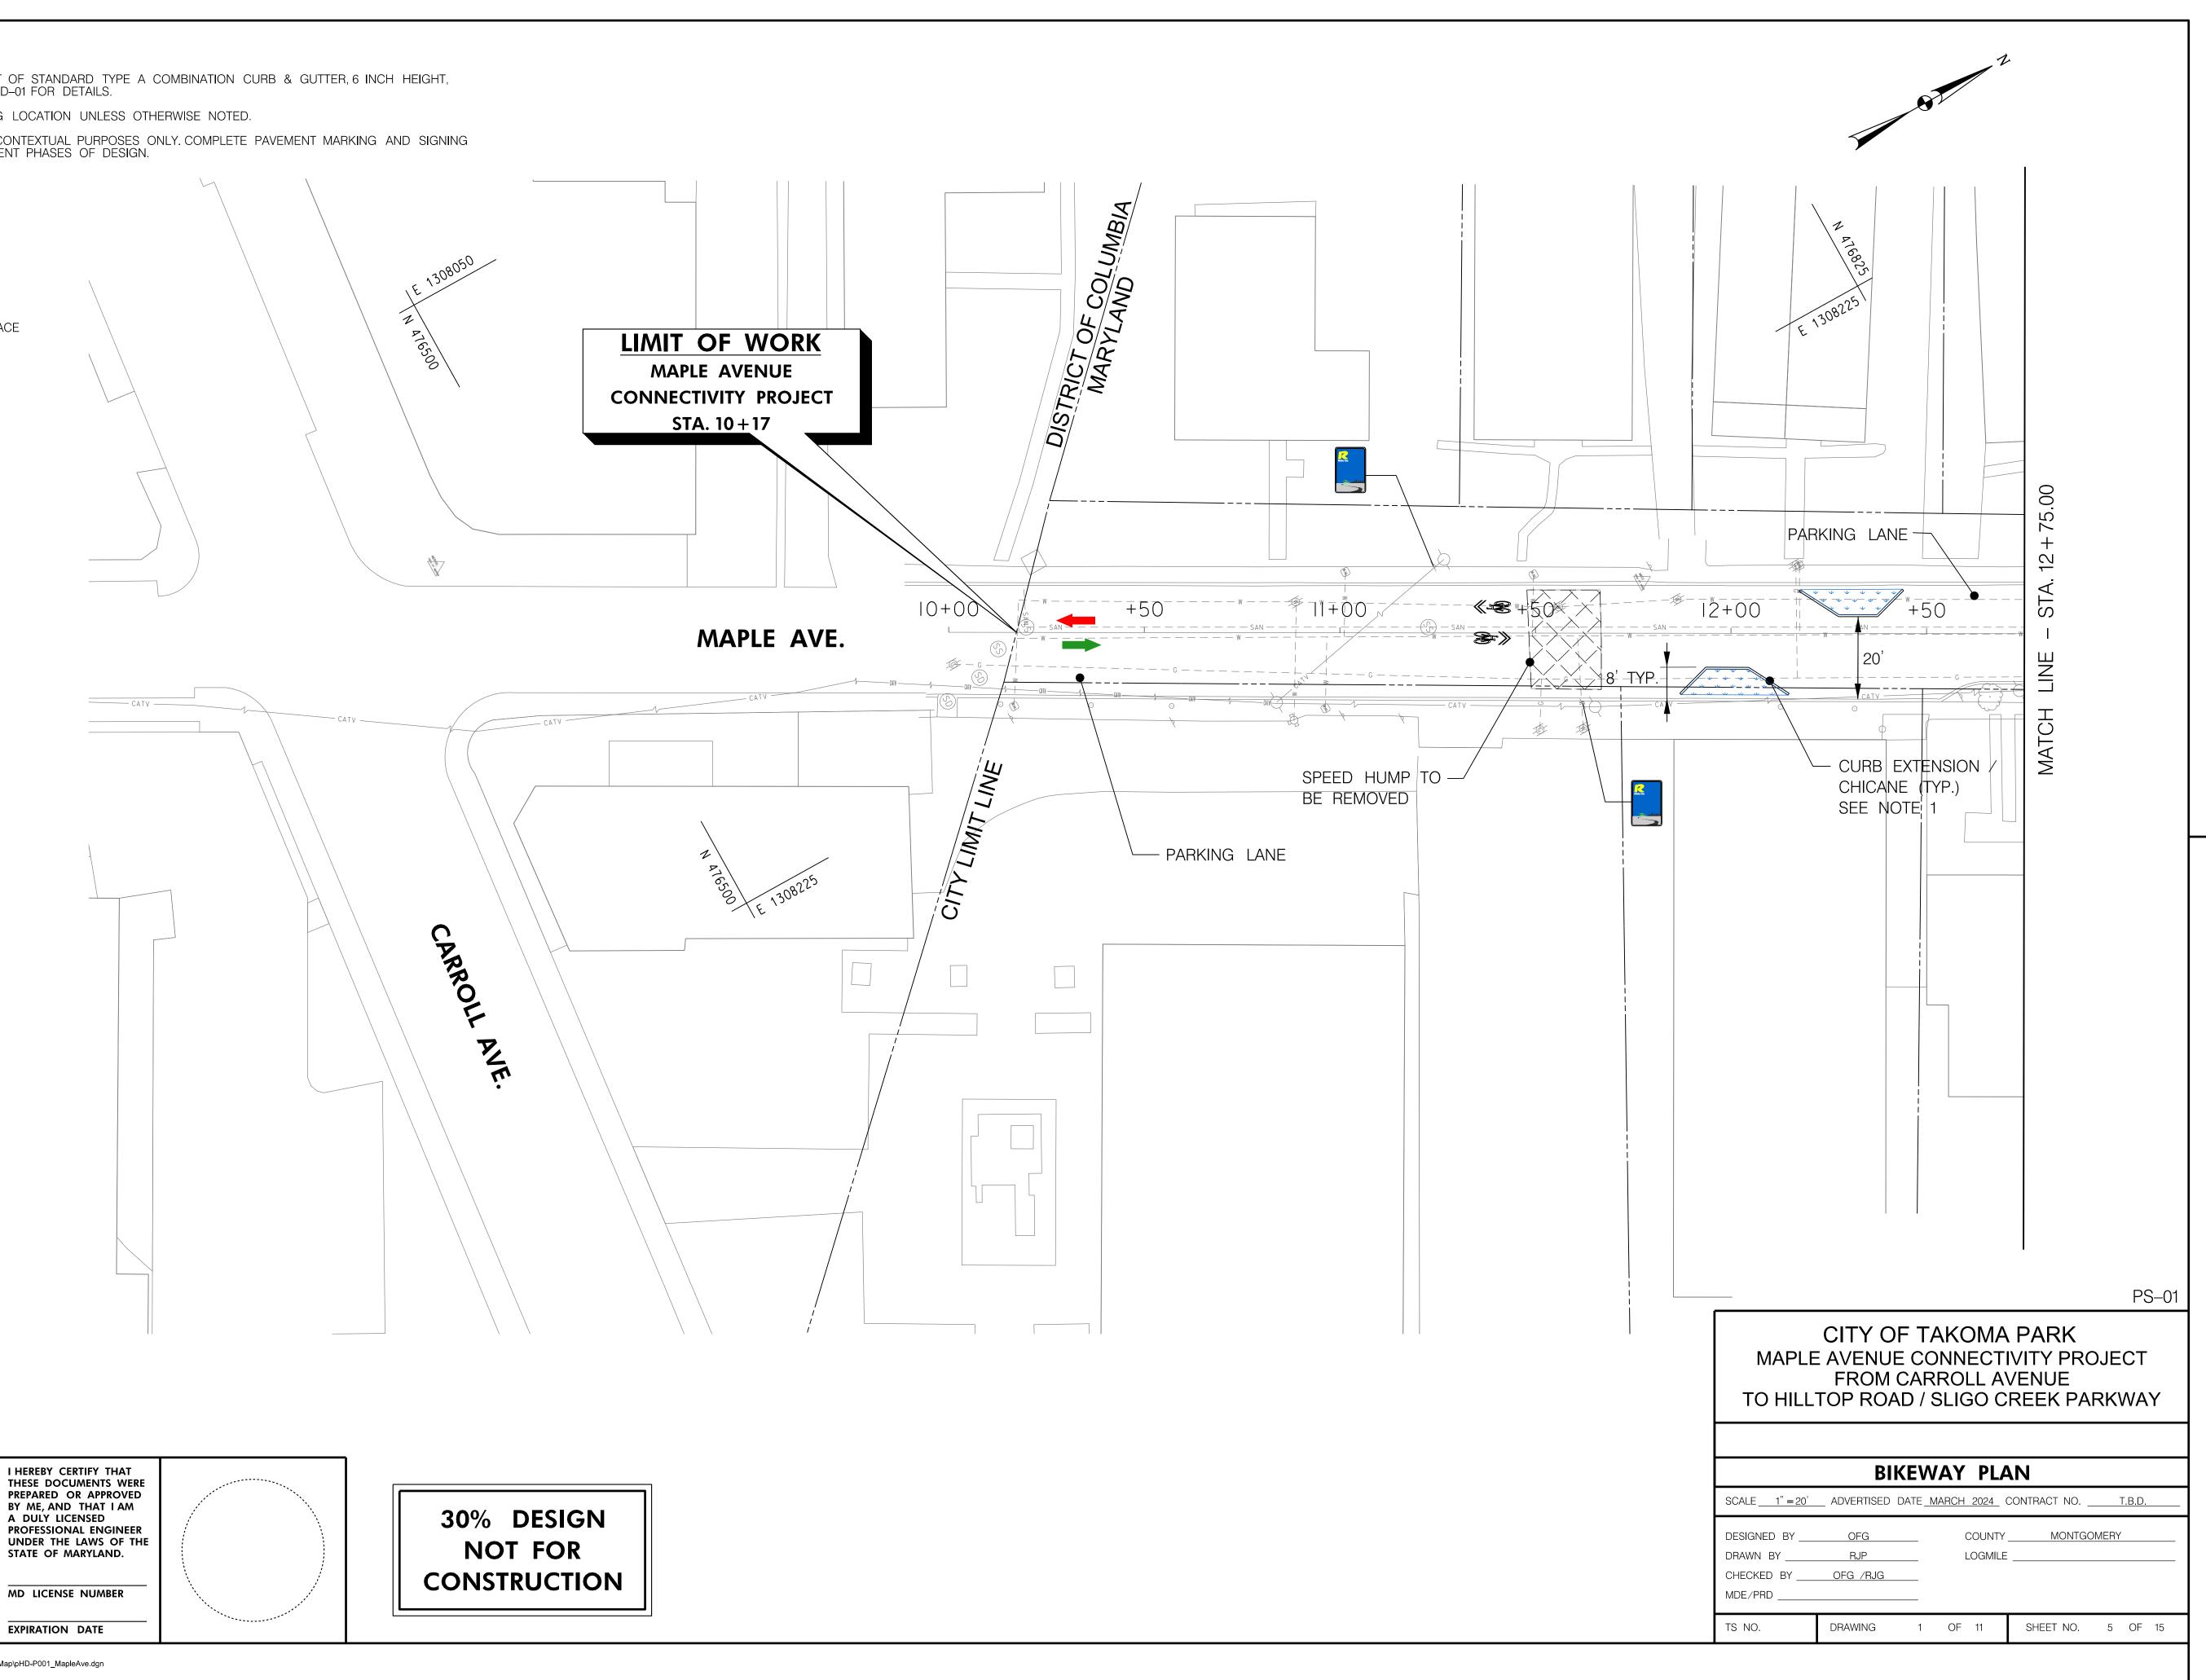


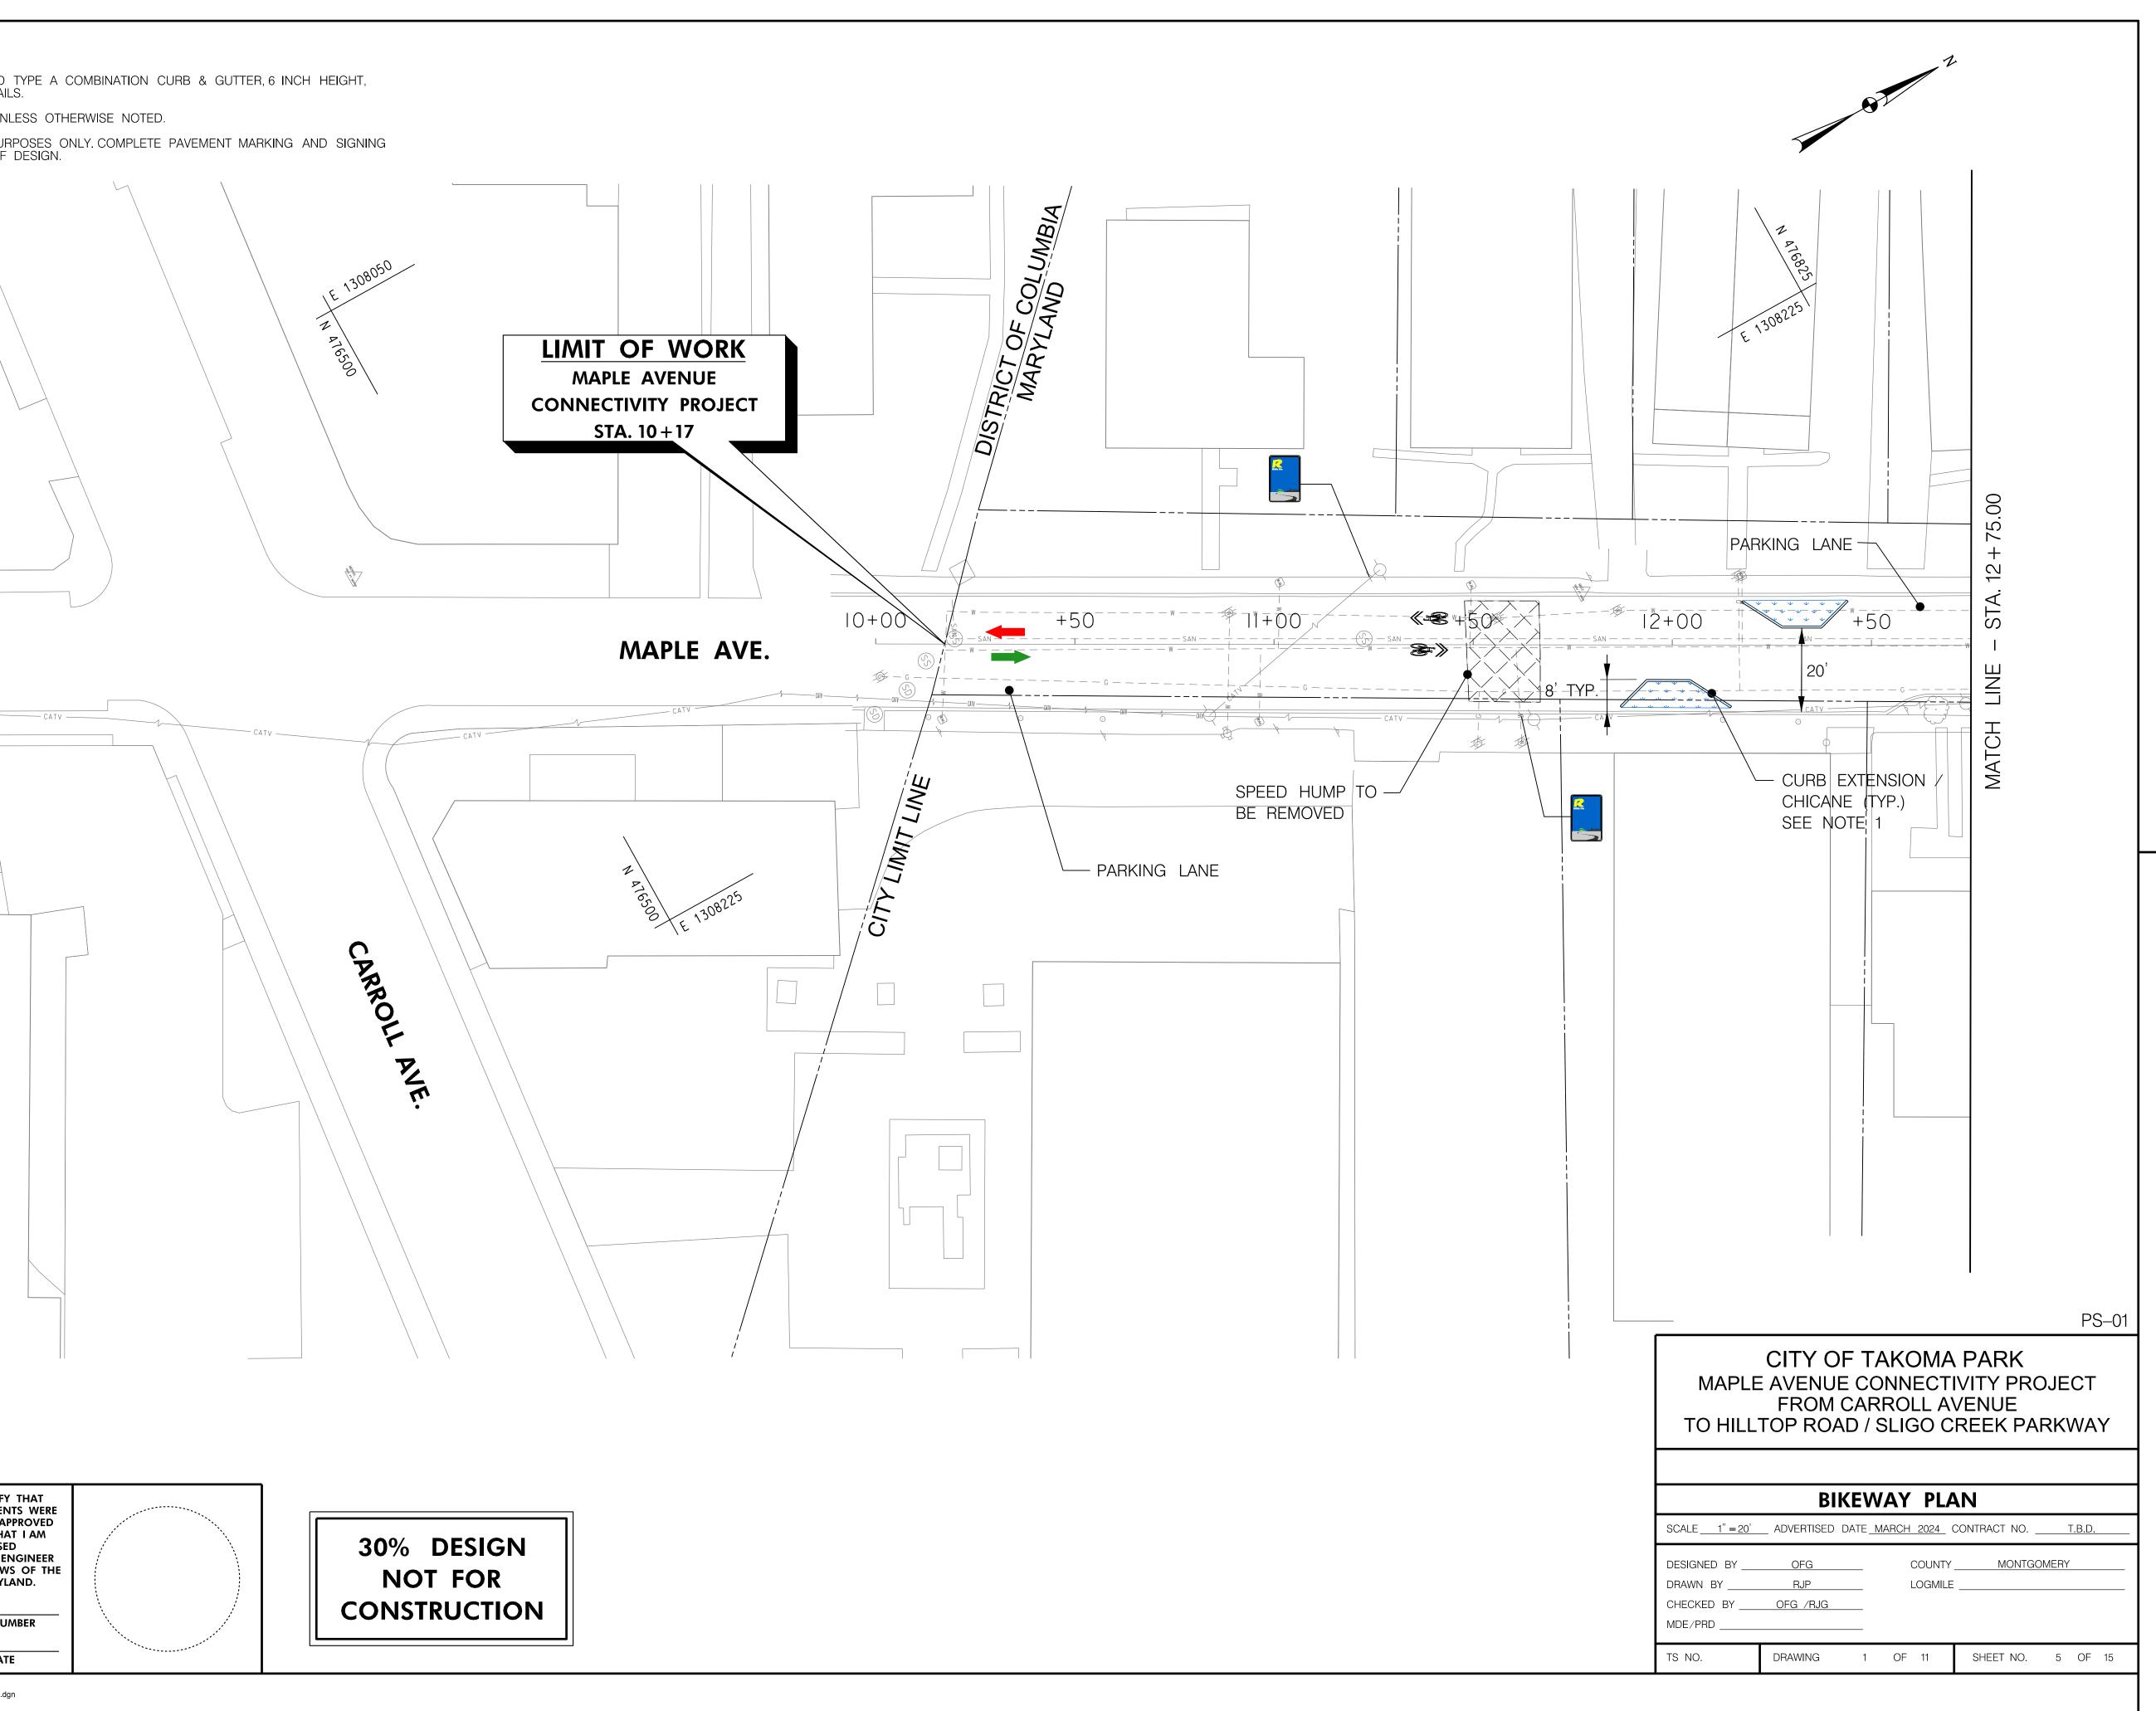
- CONCRETE SIDEWALK
- DETECTABLE WARNING SURFACE

BIKEWAY

EGRESS TO PROJECT AREA

INGRESS TO PROJECT AREA



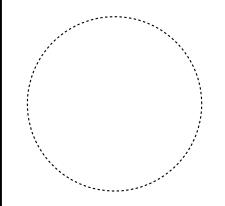




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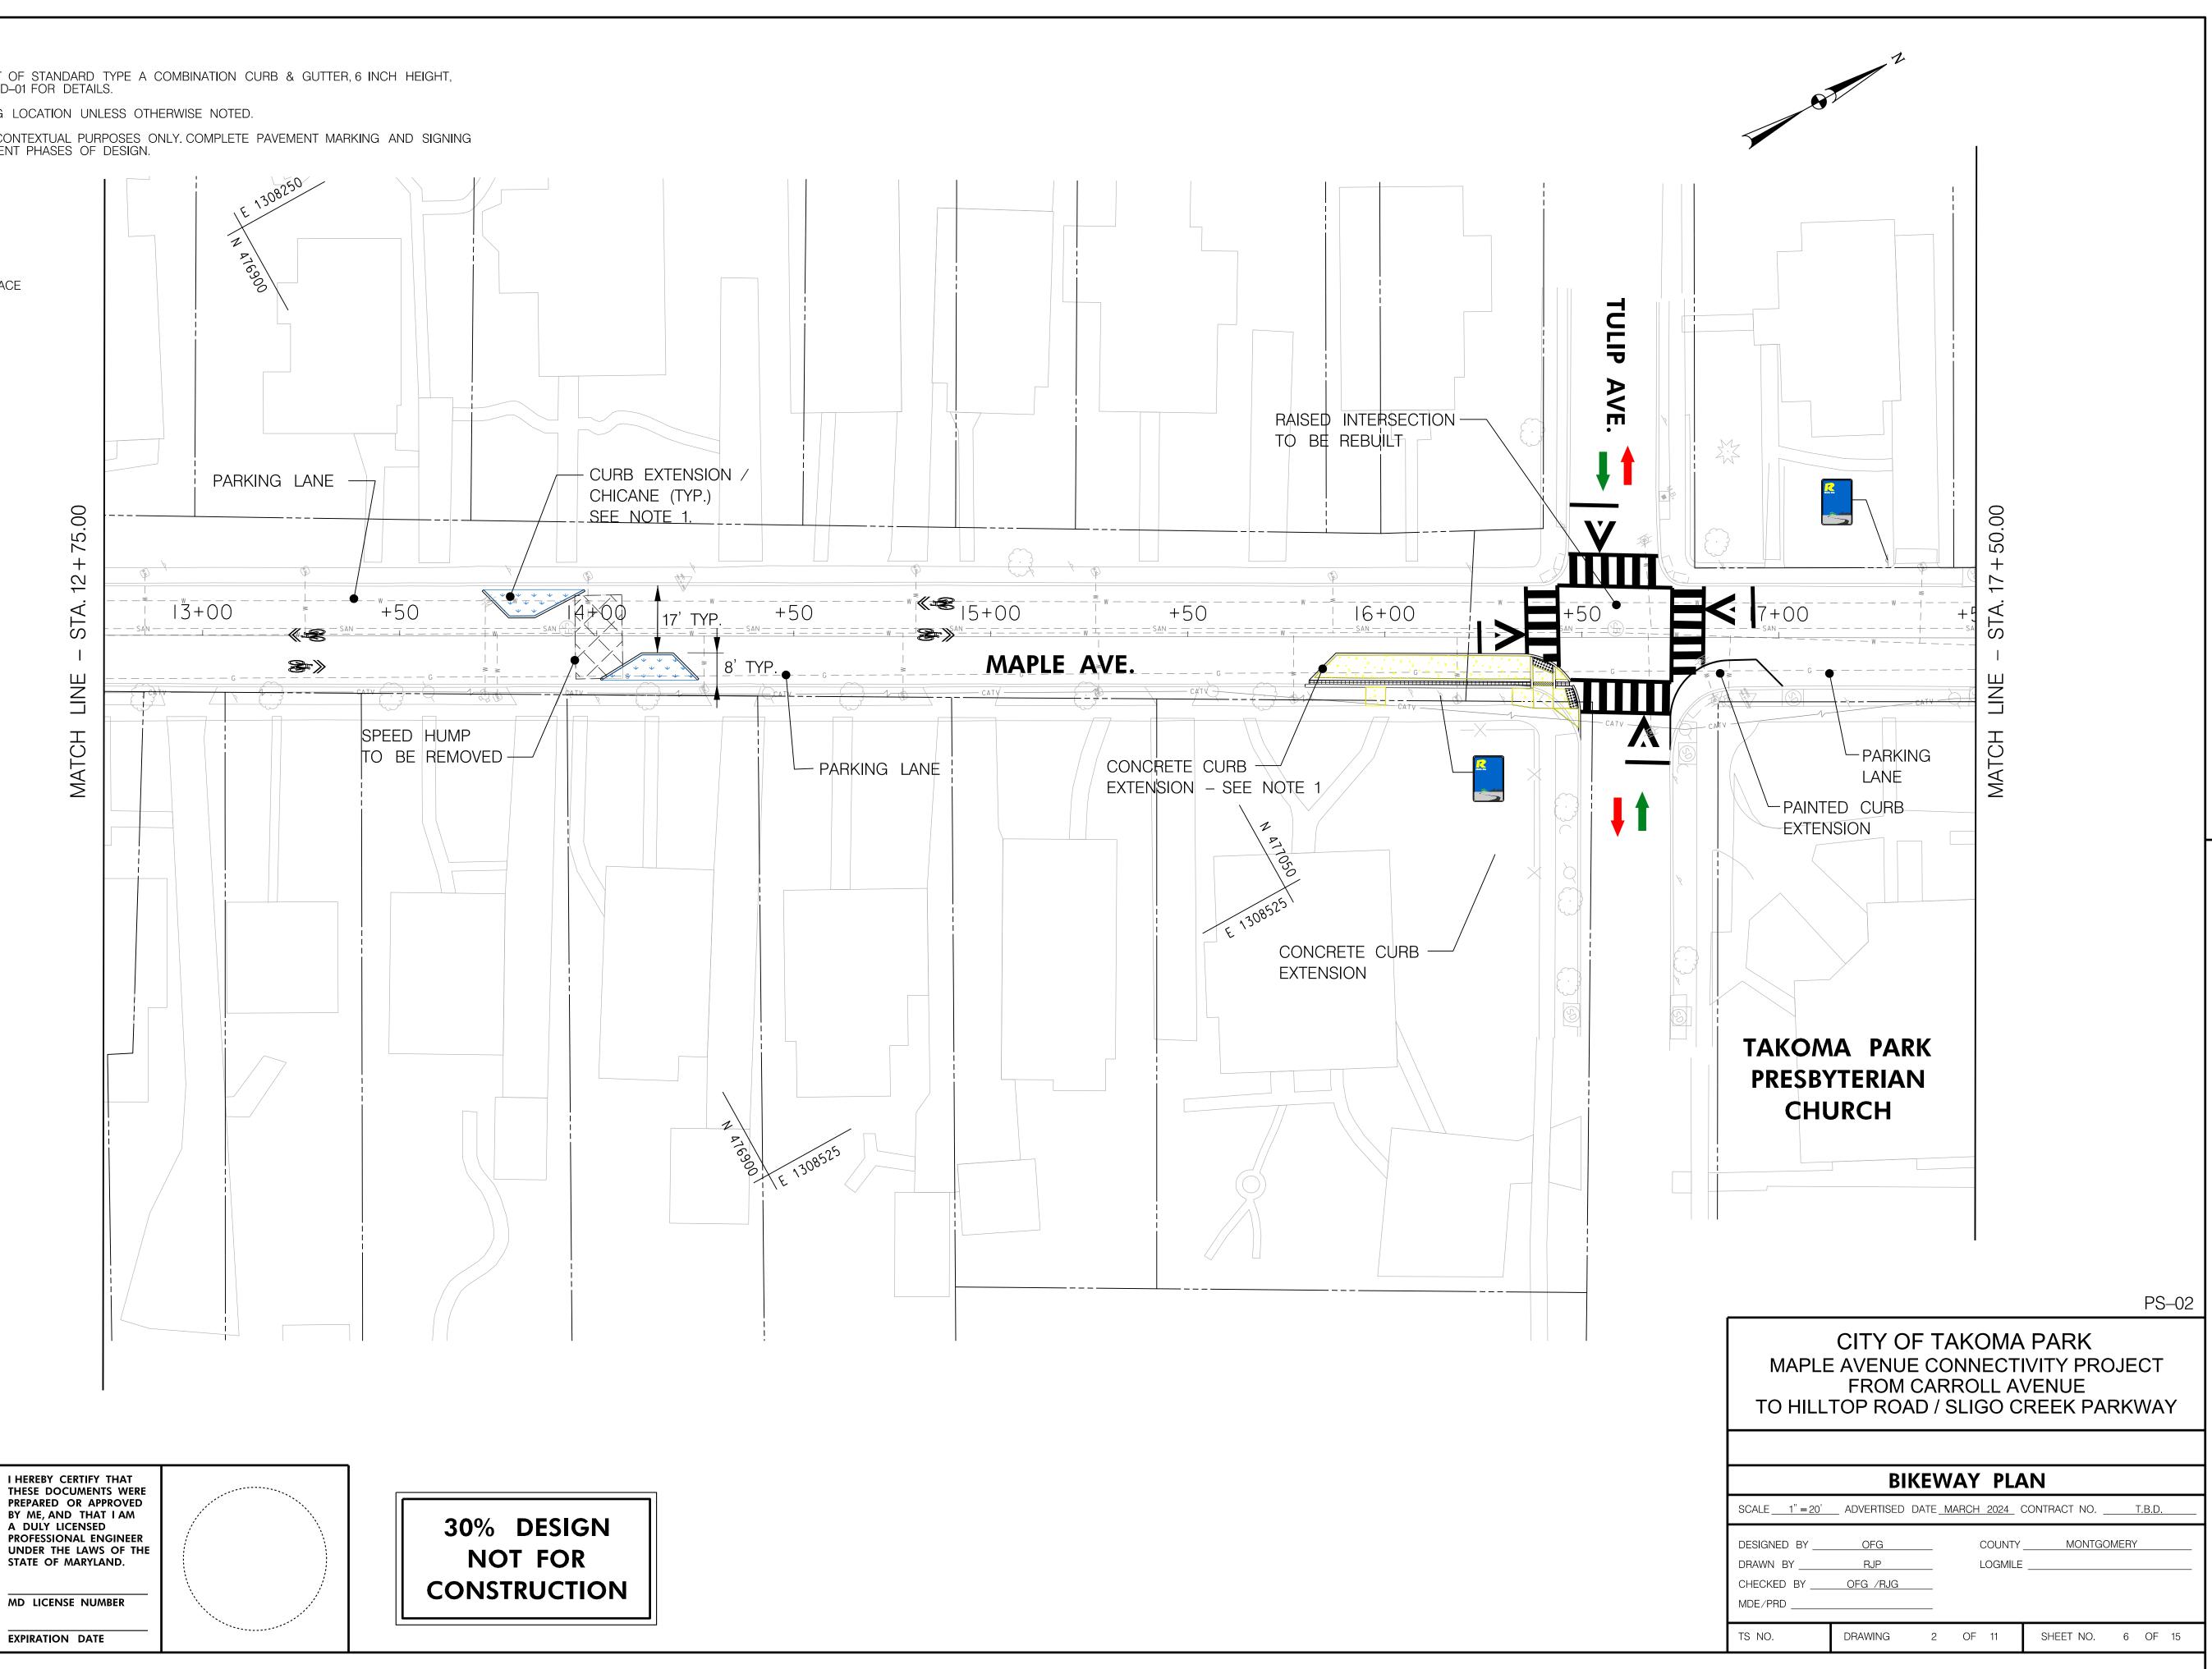
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EGRESS TO PROJECT AREA

INGRESS TO PROJECT AREA



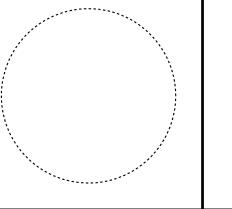


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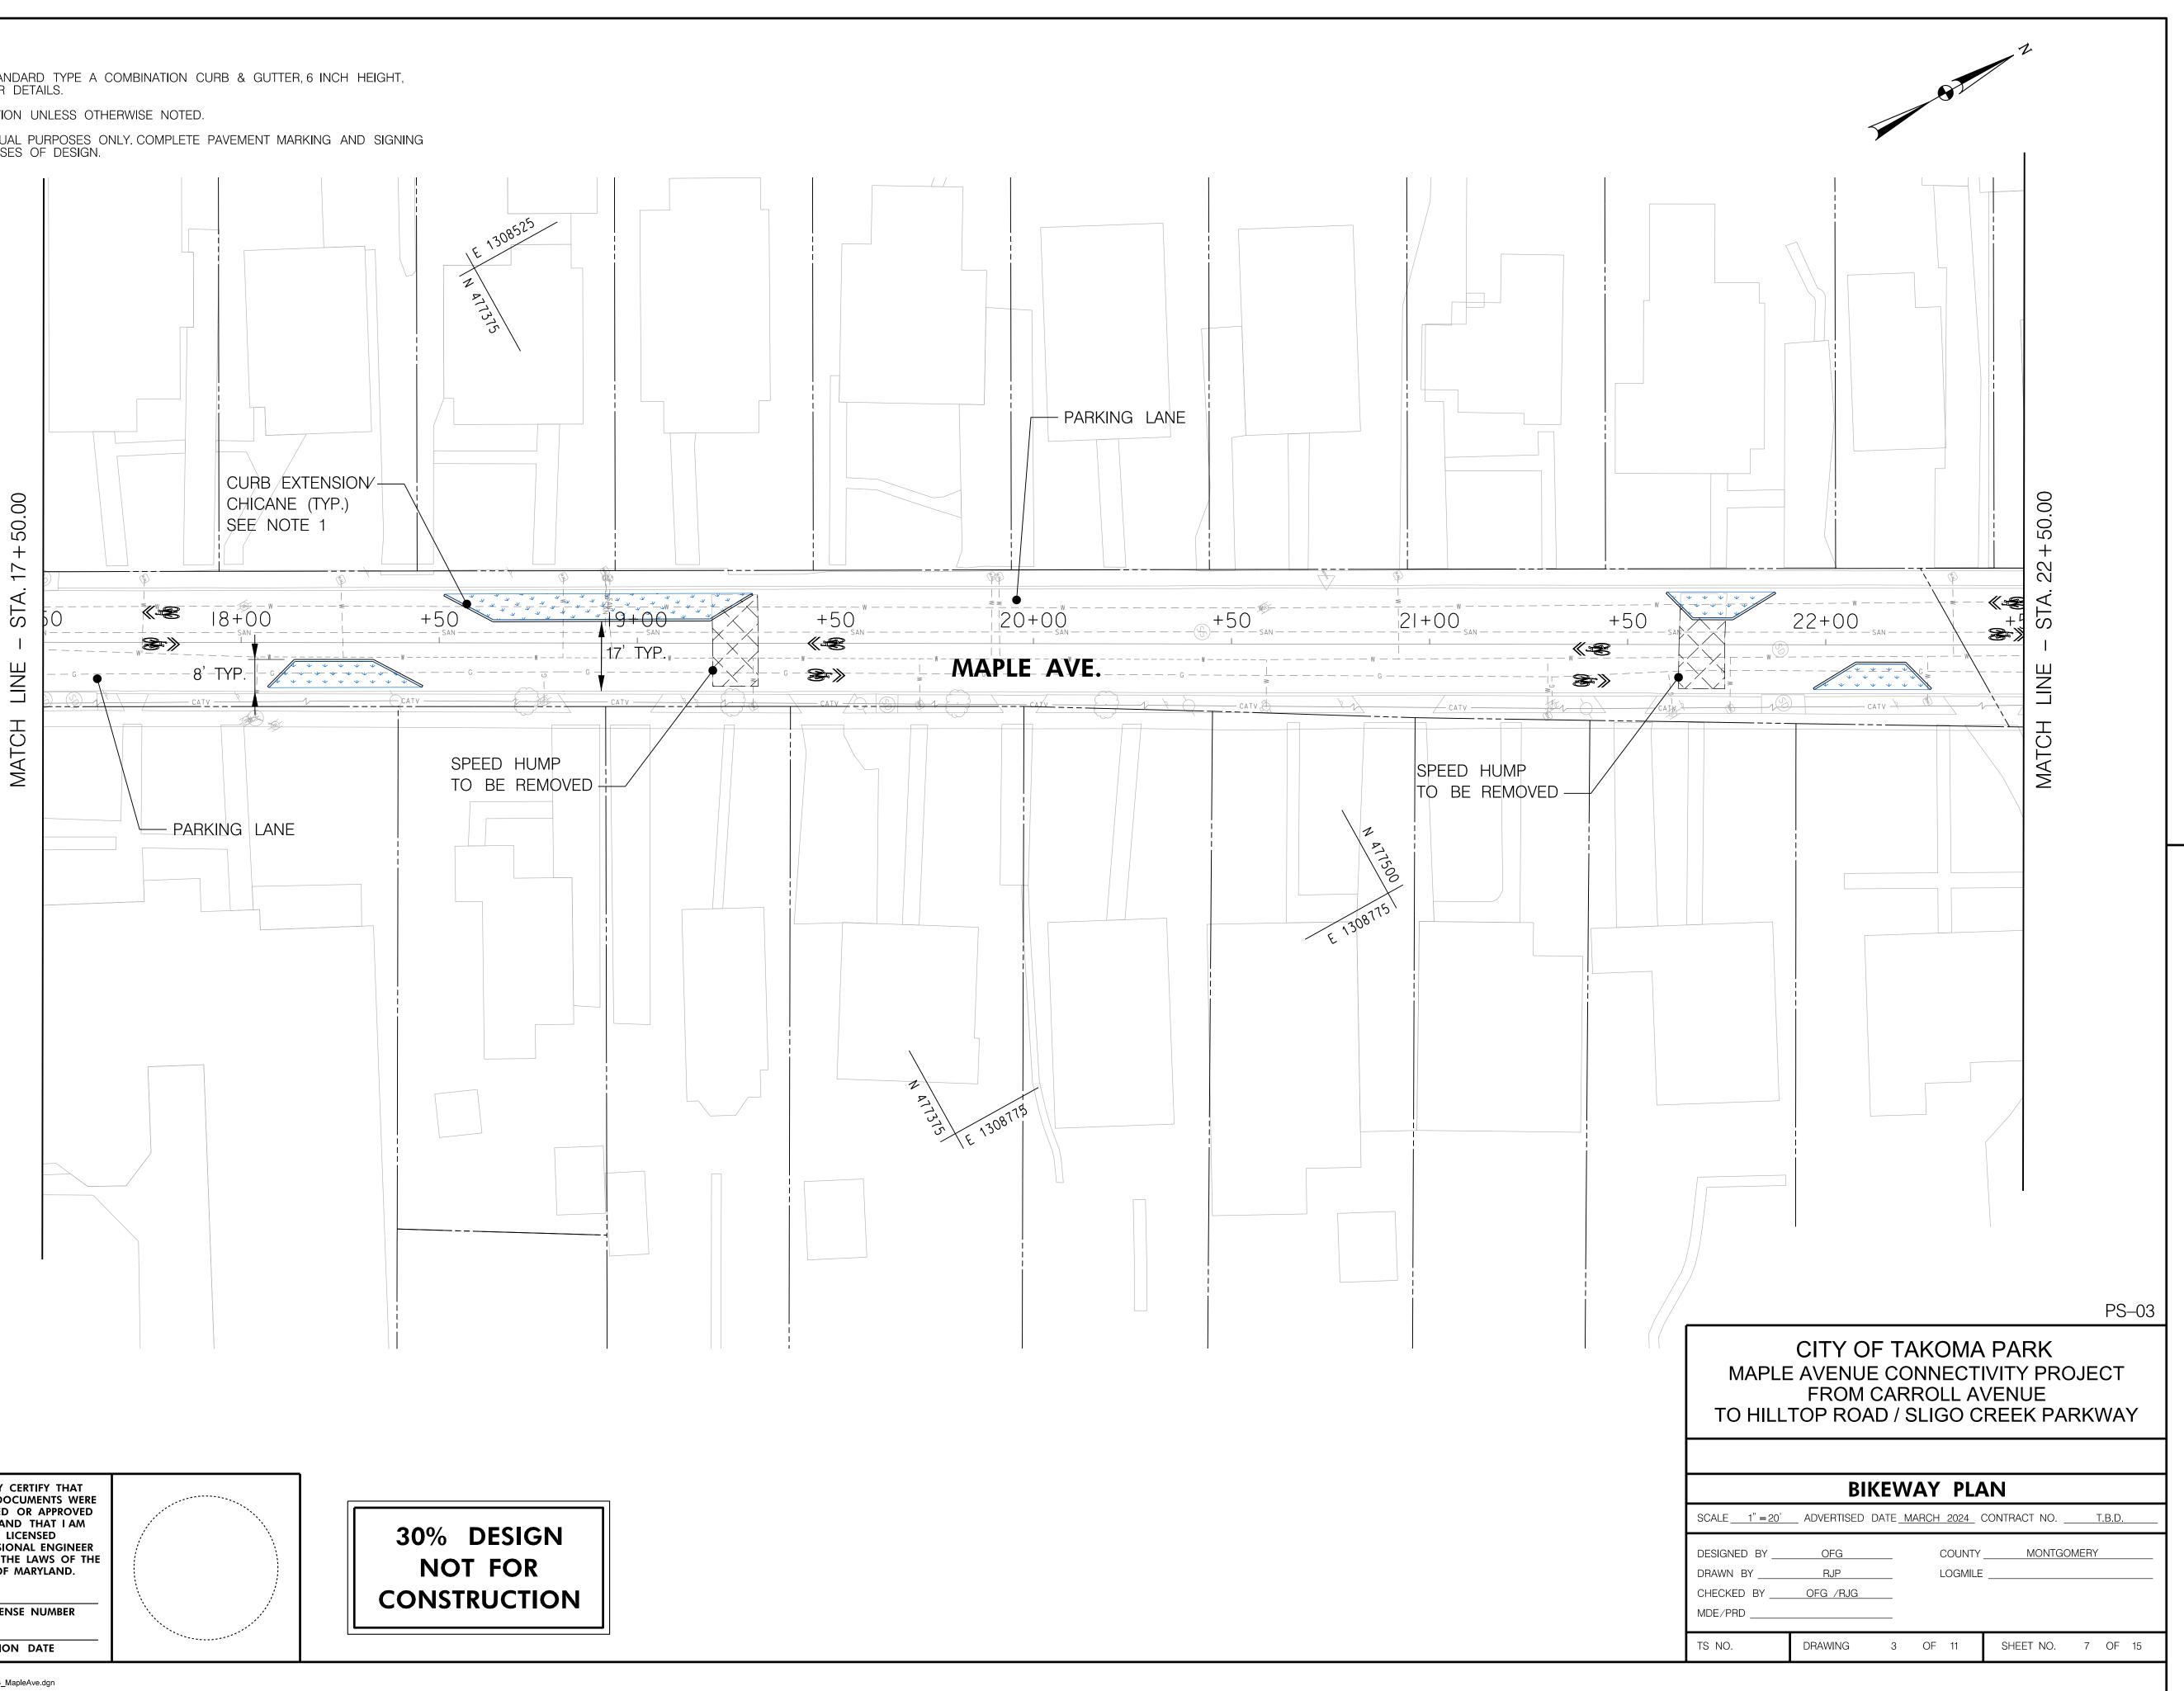
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INGRESS TO PROJECT AREA





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- RIDE ON MONTGOMERY COUNTY TRANSIT BUS STOP
- BIKE LANE
- SHARED LANE
- CONCRETE Δ
 - PLANTED /GRASS AREA
 - TO BE REMOVED
 - DIRECTION OF TRAFFIC

 $\mathbf{\Pi}$ - CROSSWALK



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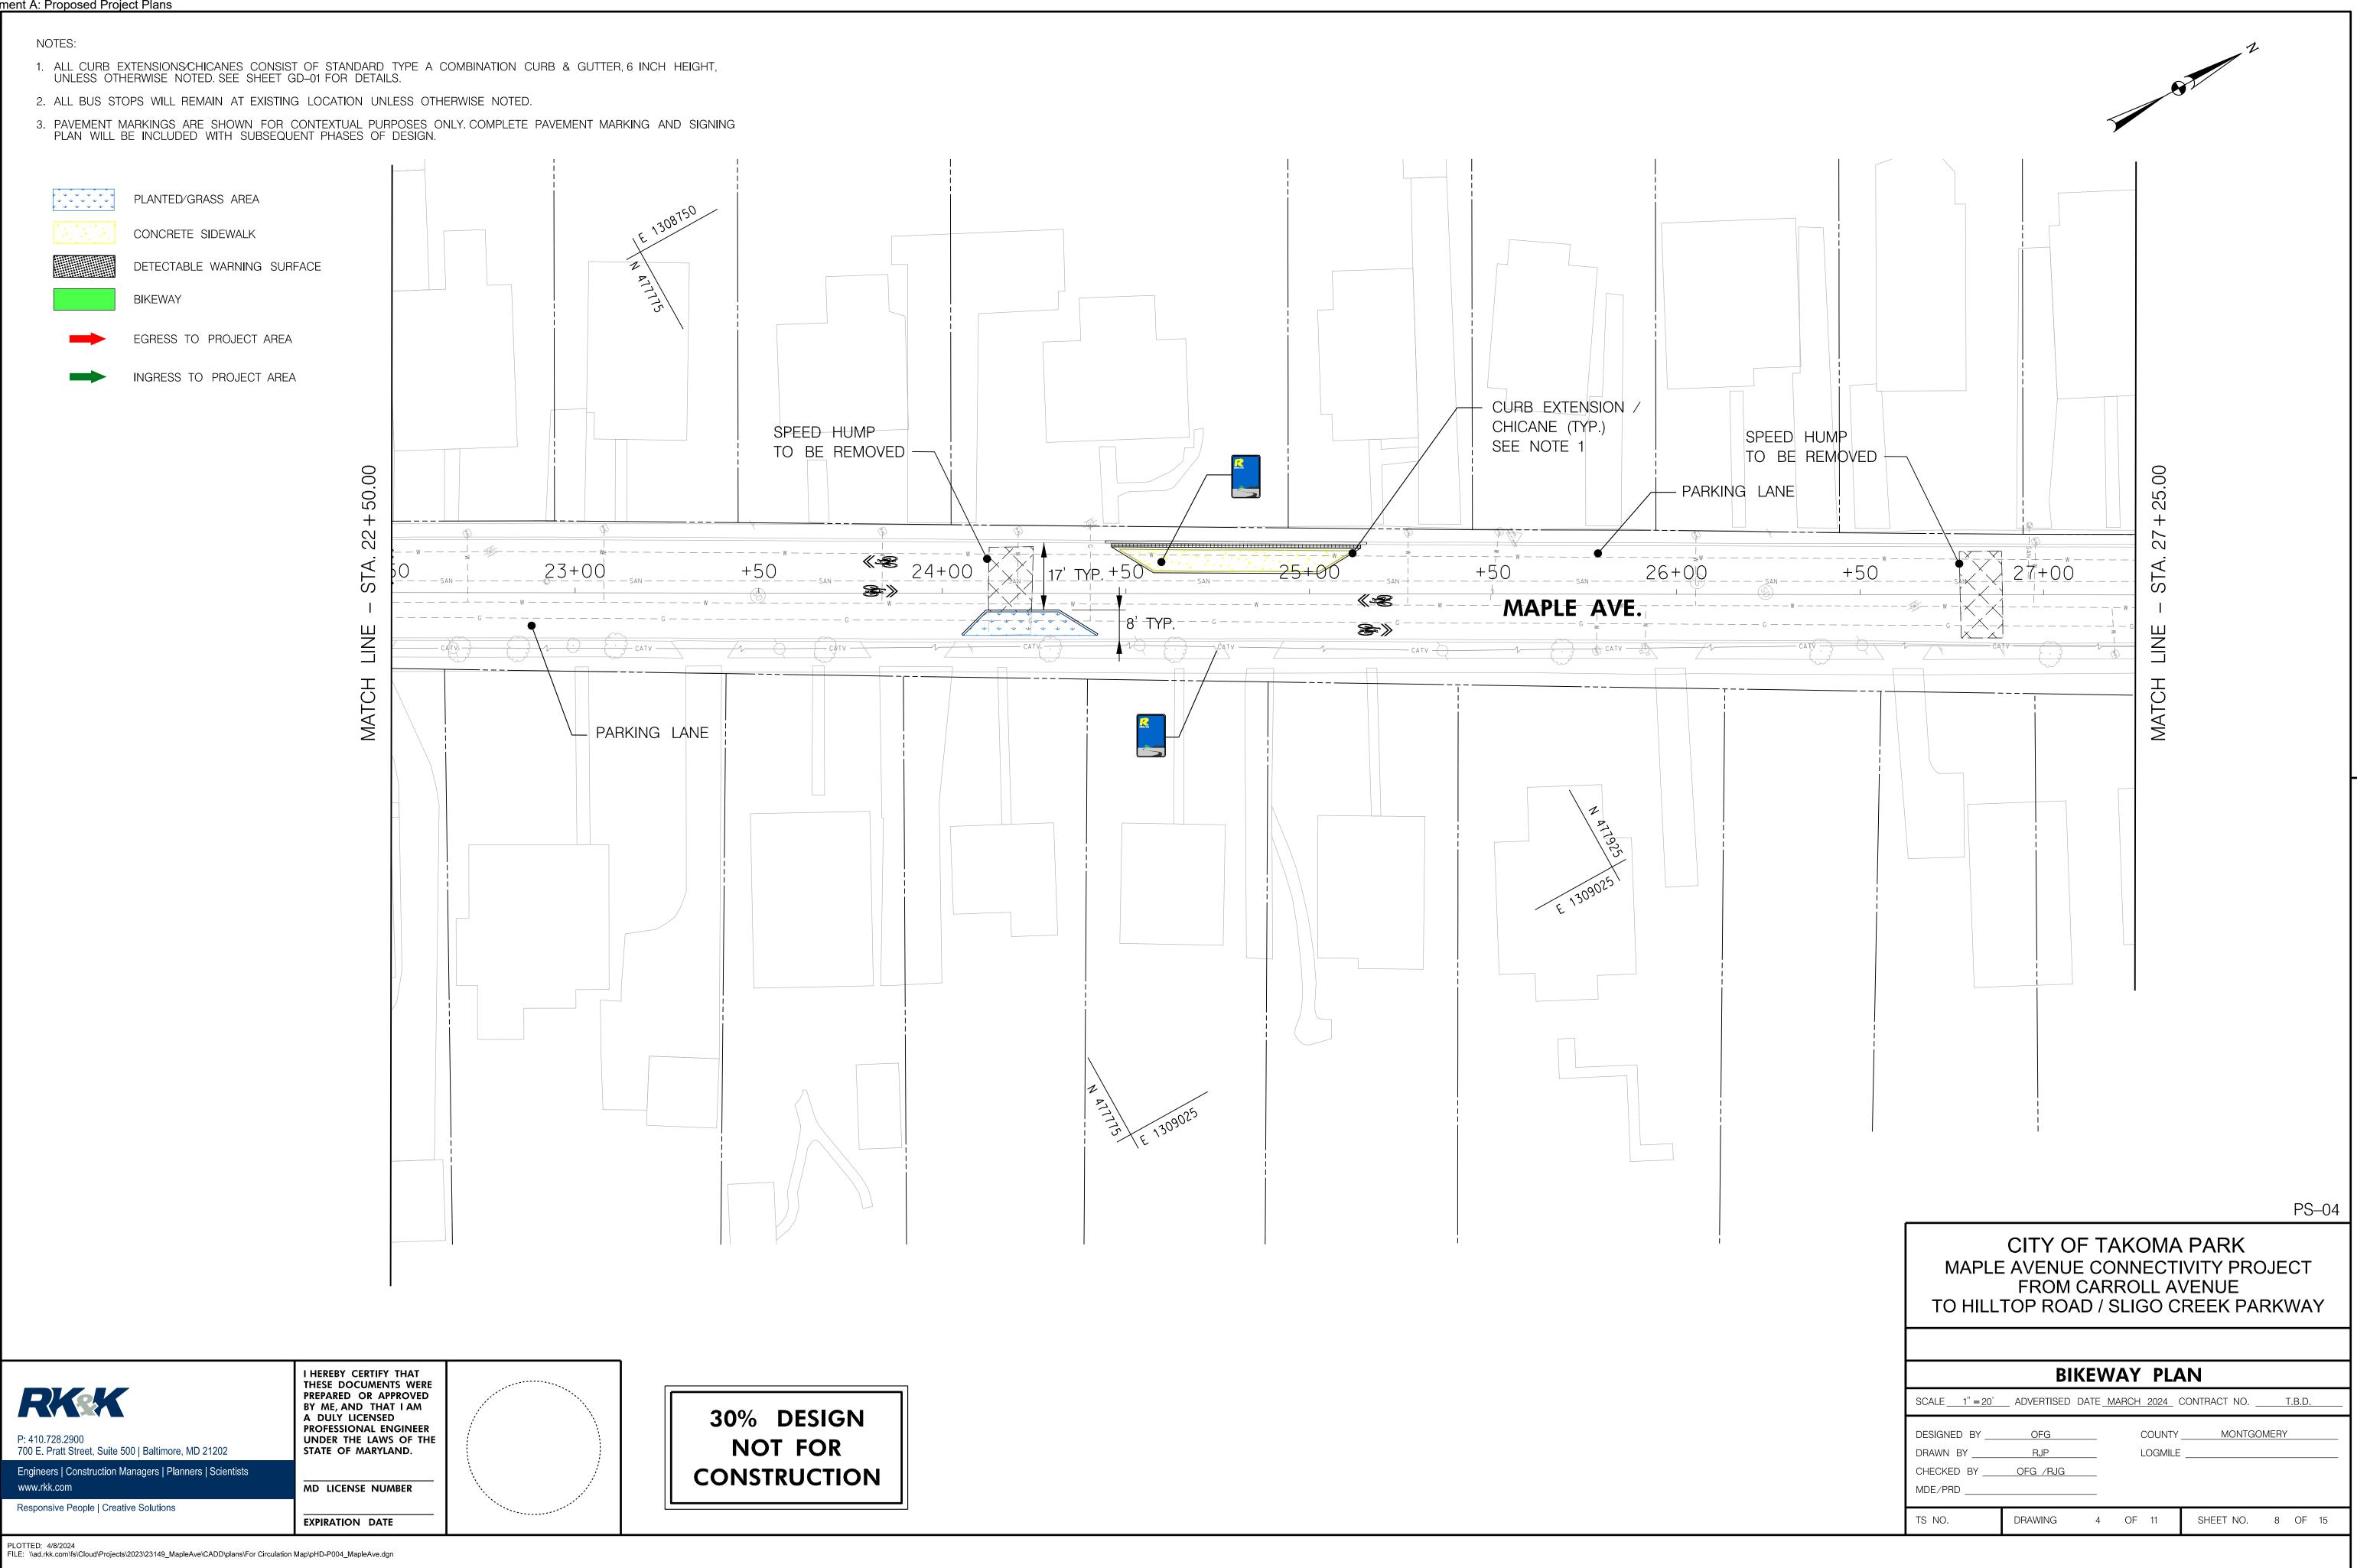
MD LICENSE NUMBER

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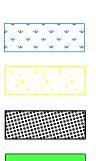




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PLANTED/GRASS AREA

CONCRETE SIDEWALK

DETECTABLE WARNING SURFACE

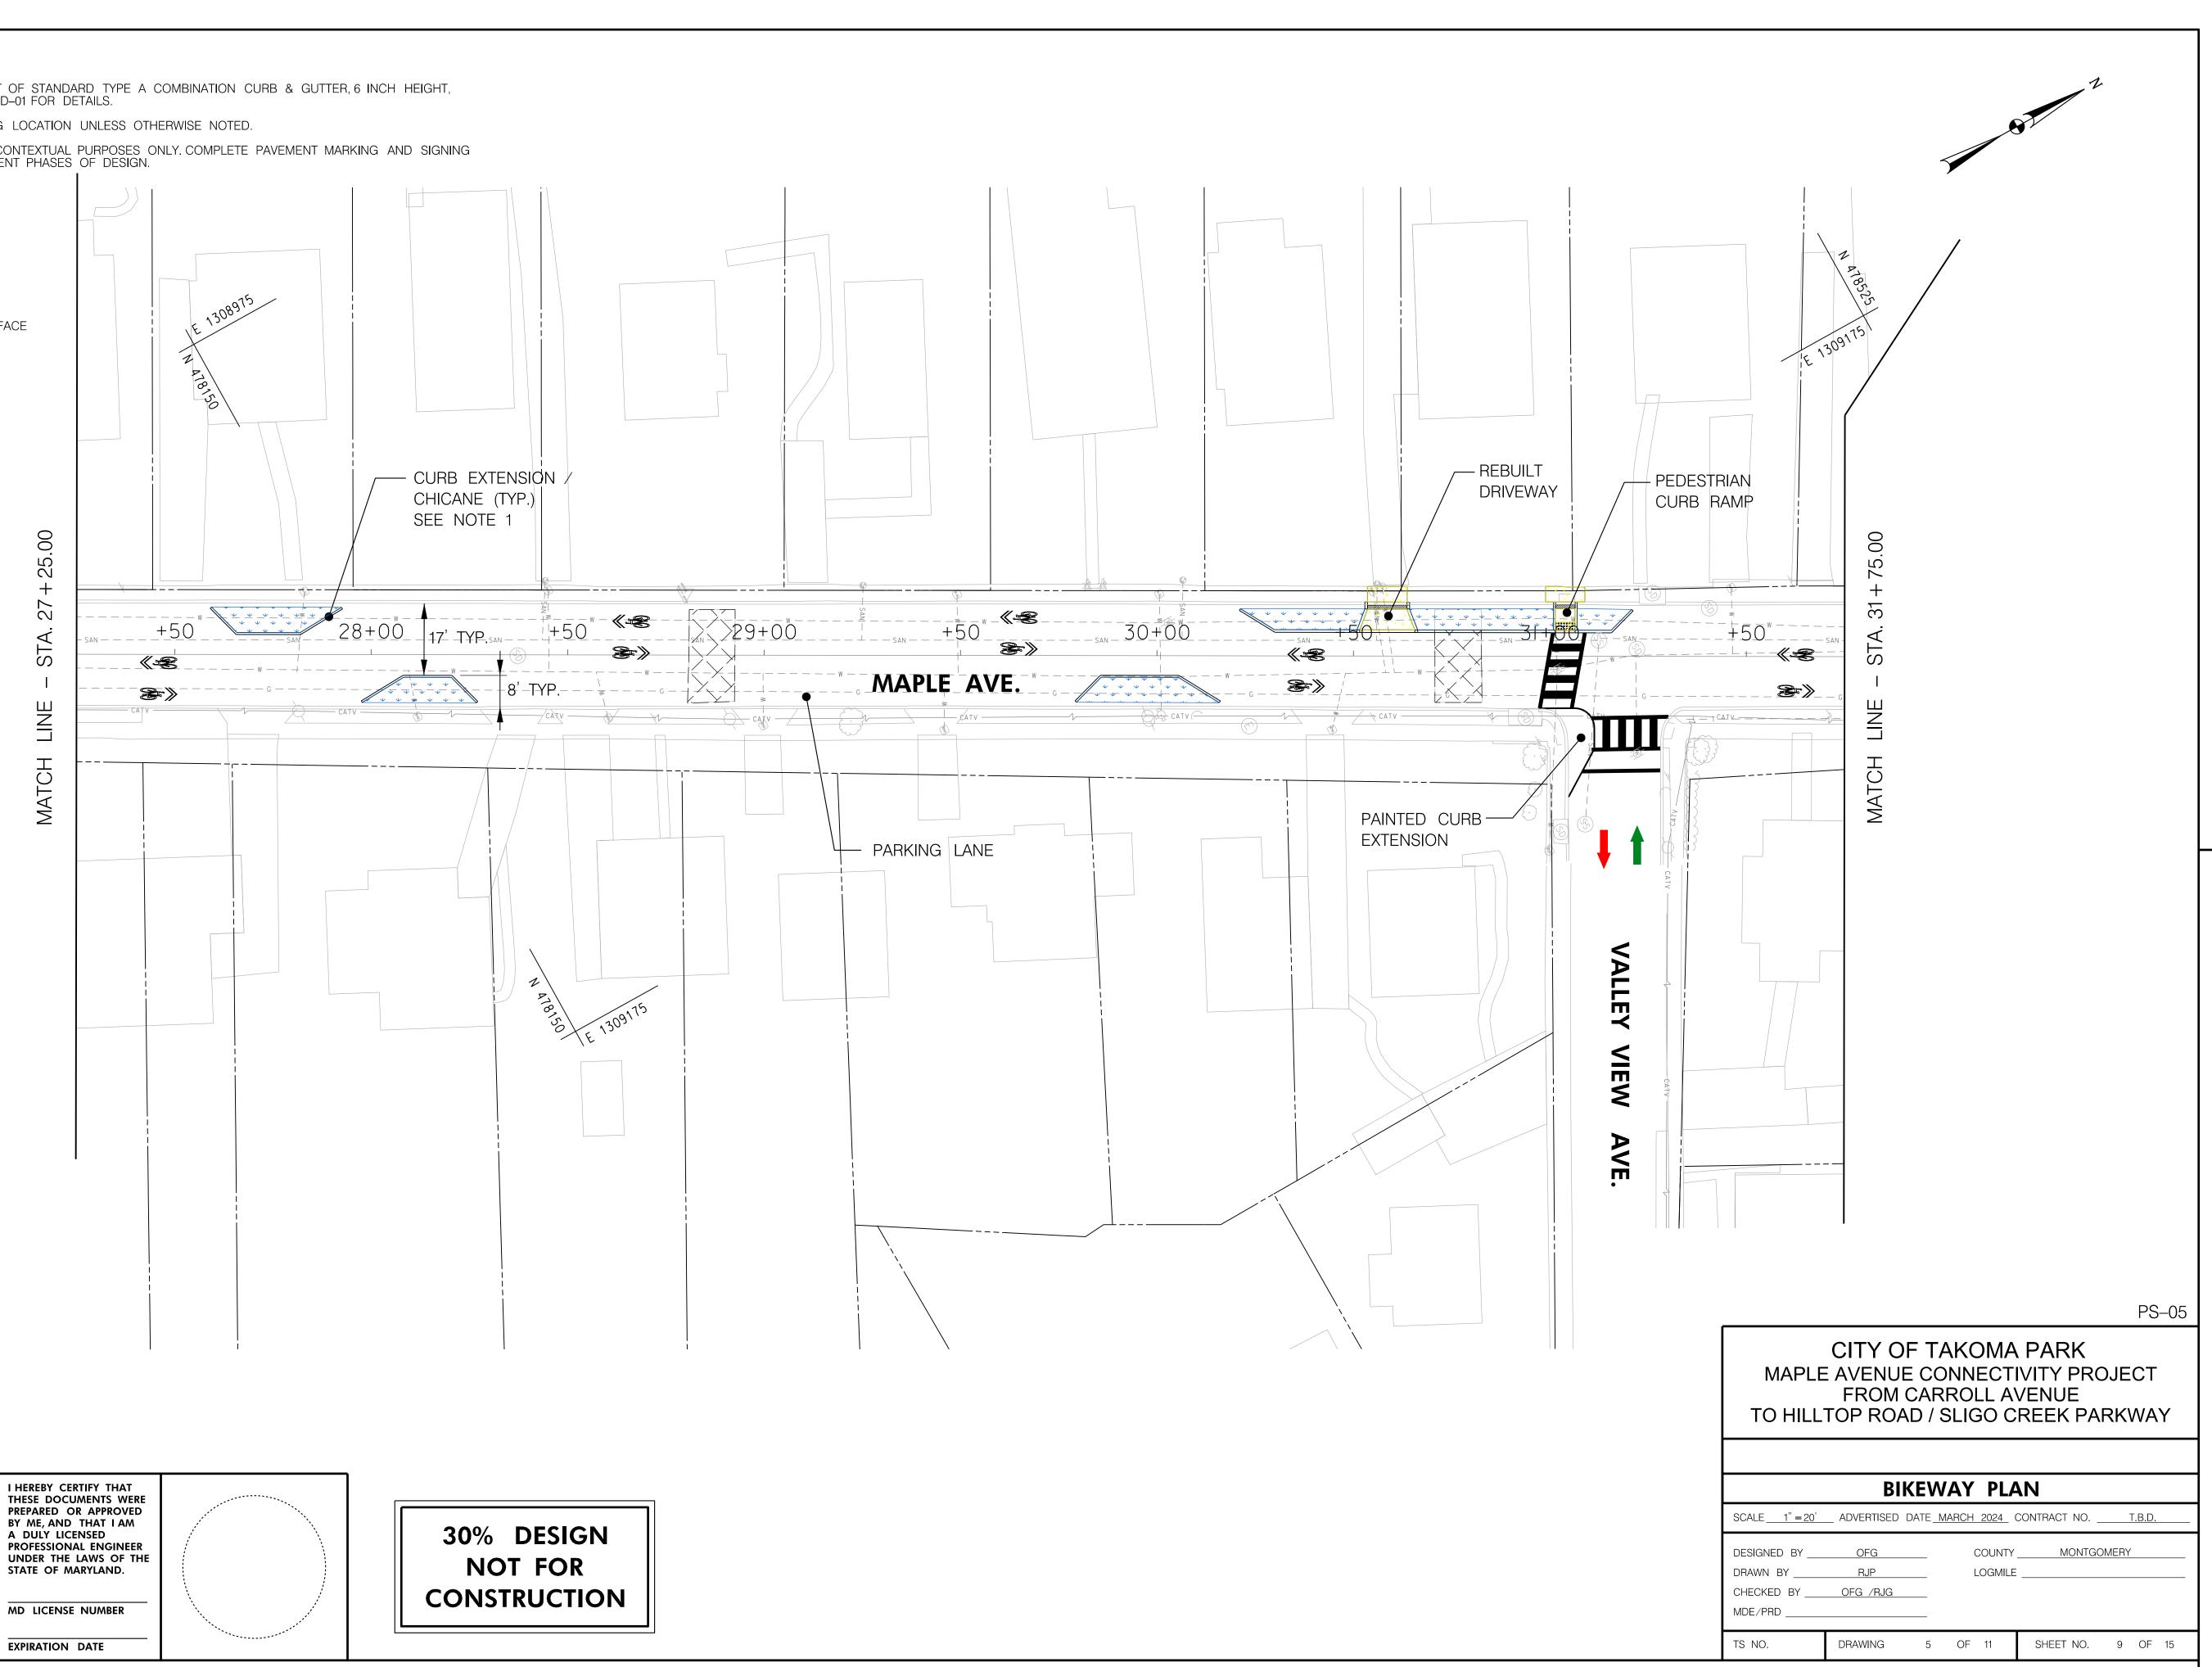
BIKEWAY

EGRESS TO PROJECT AREA

INGRESS TO PROJECT AREA

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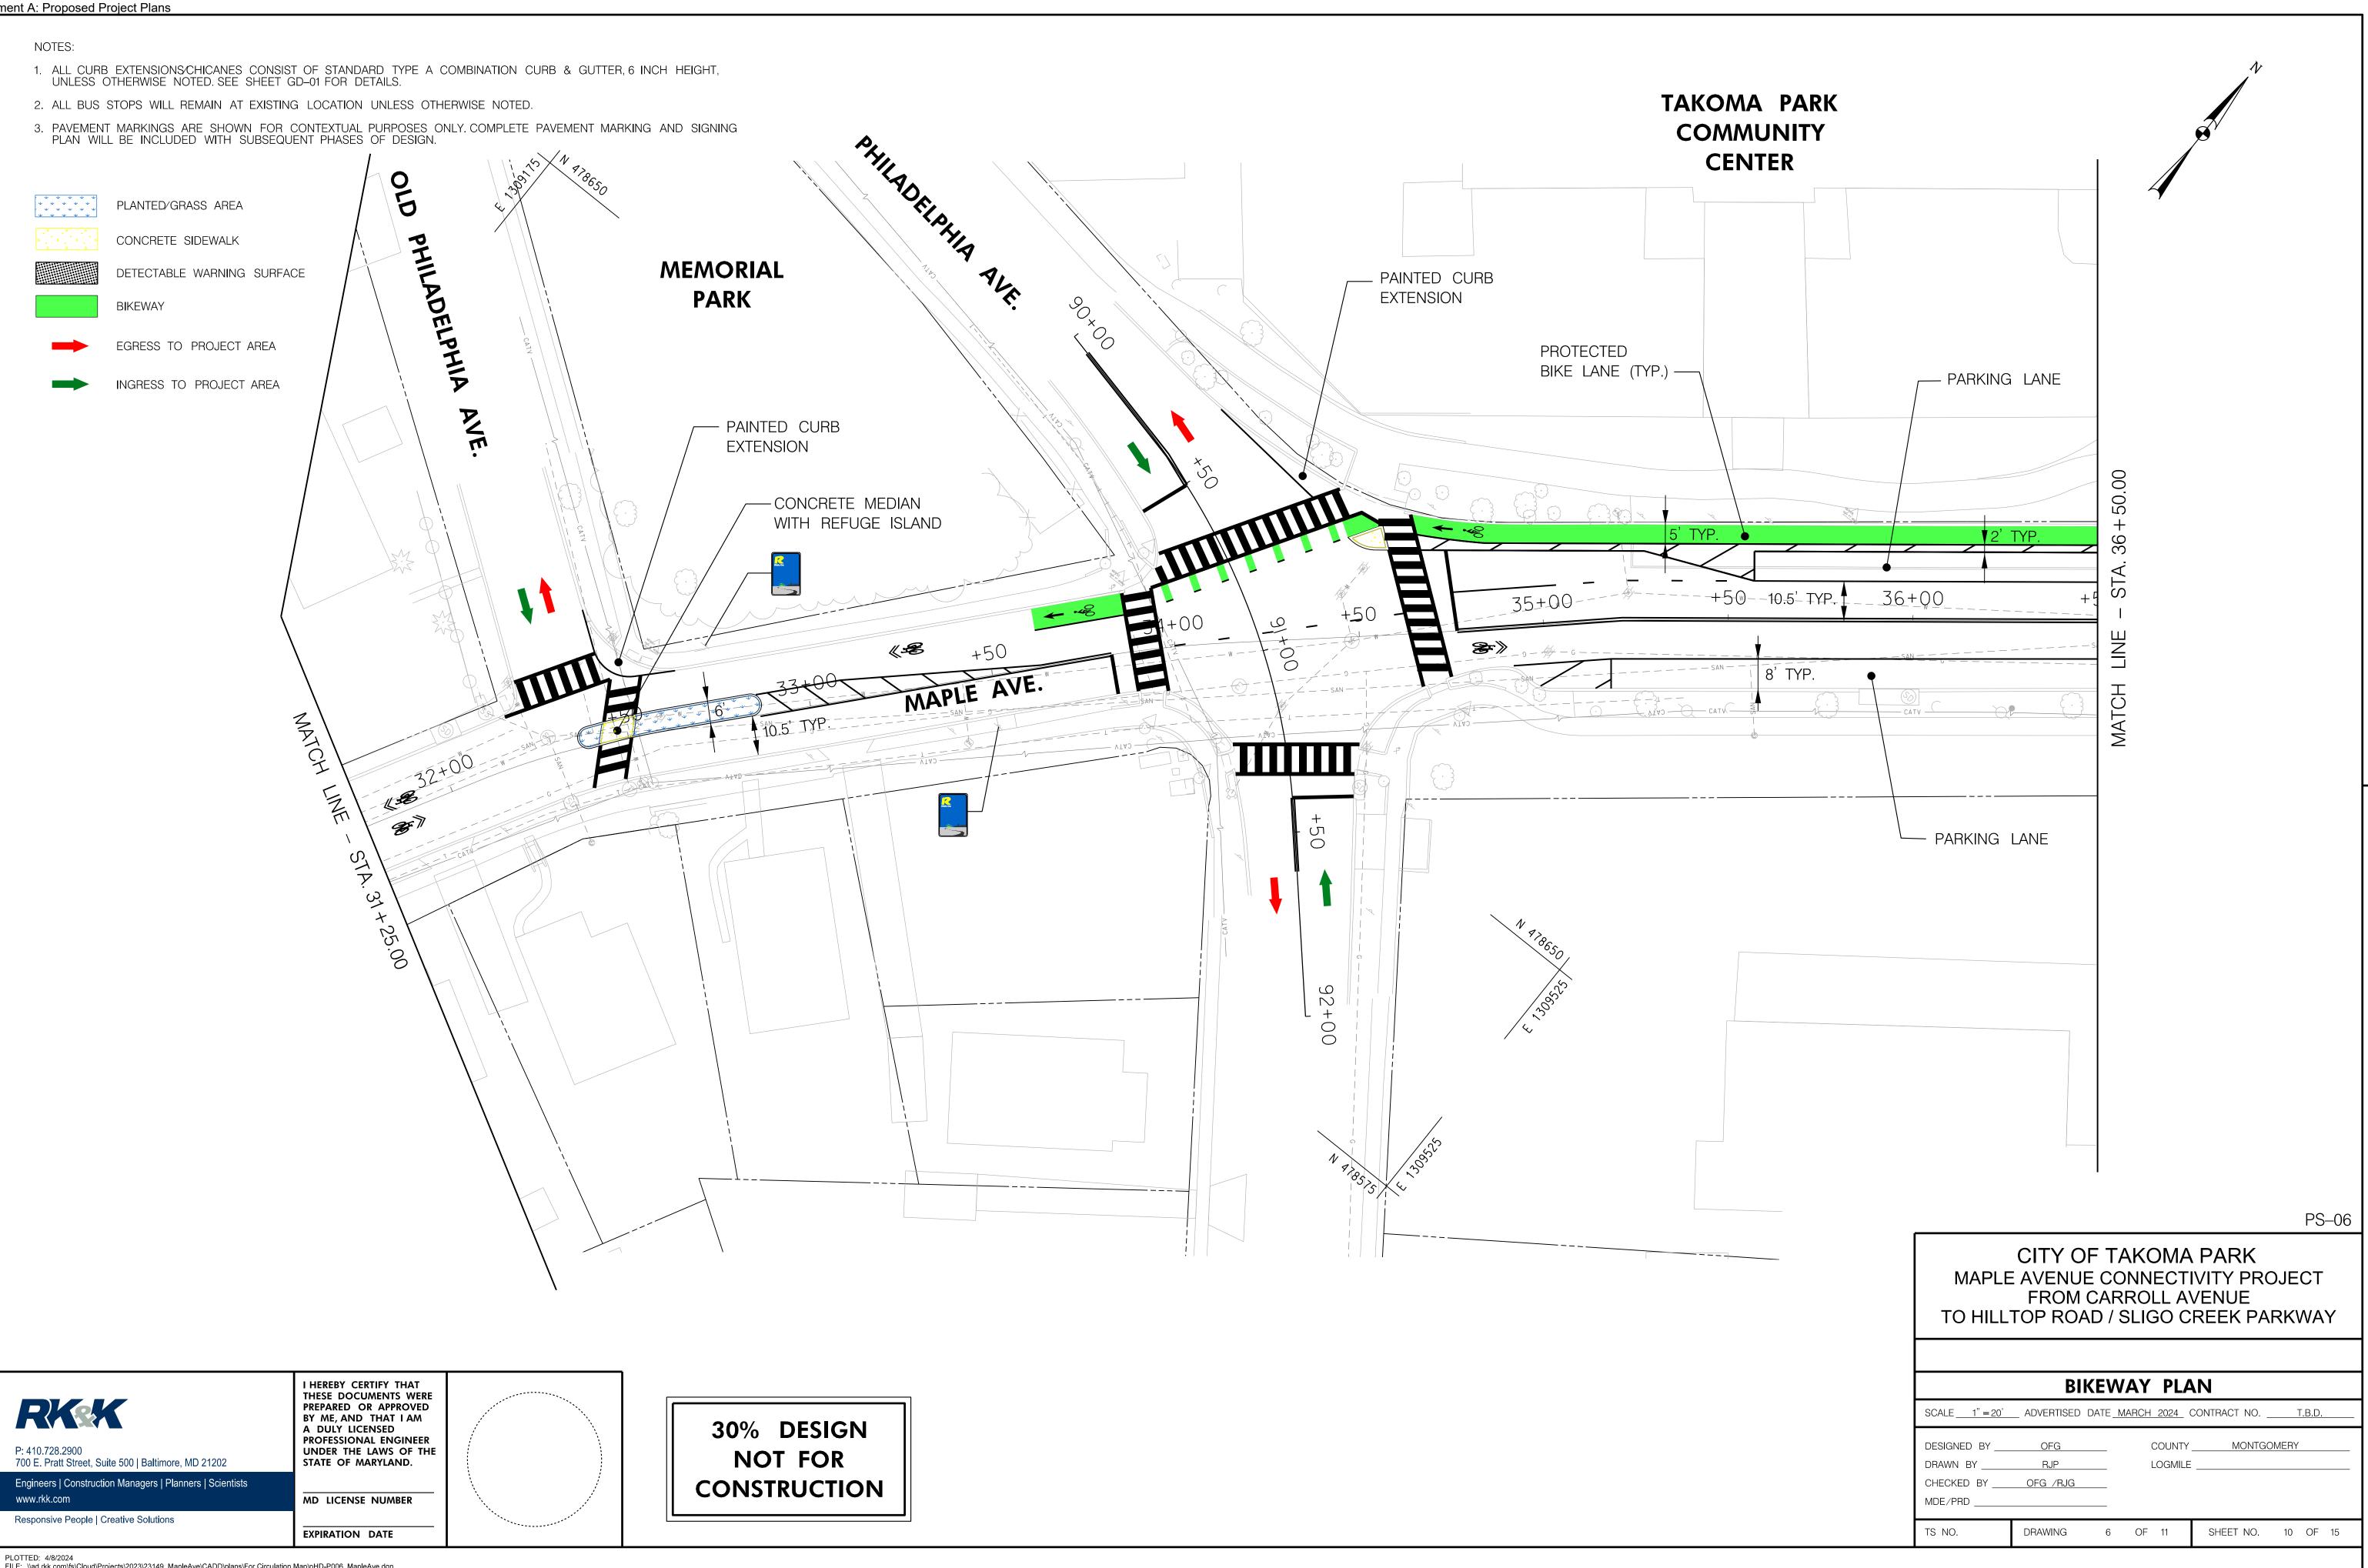


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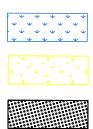
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PLANTED/GRASS AREA

CONCRETE SIDEWALK

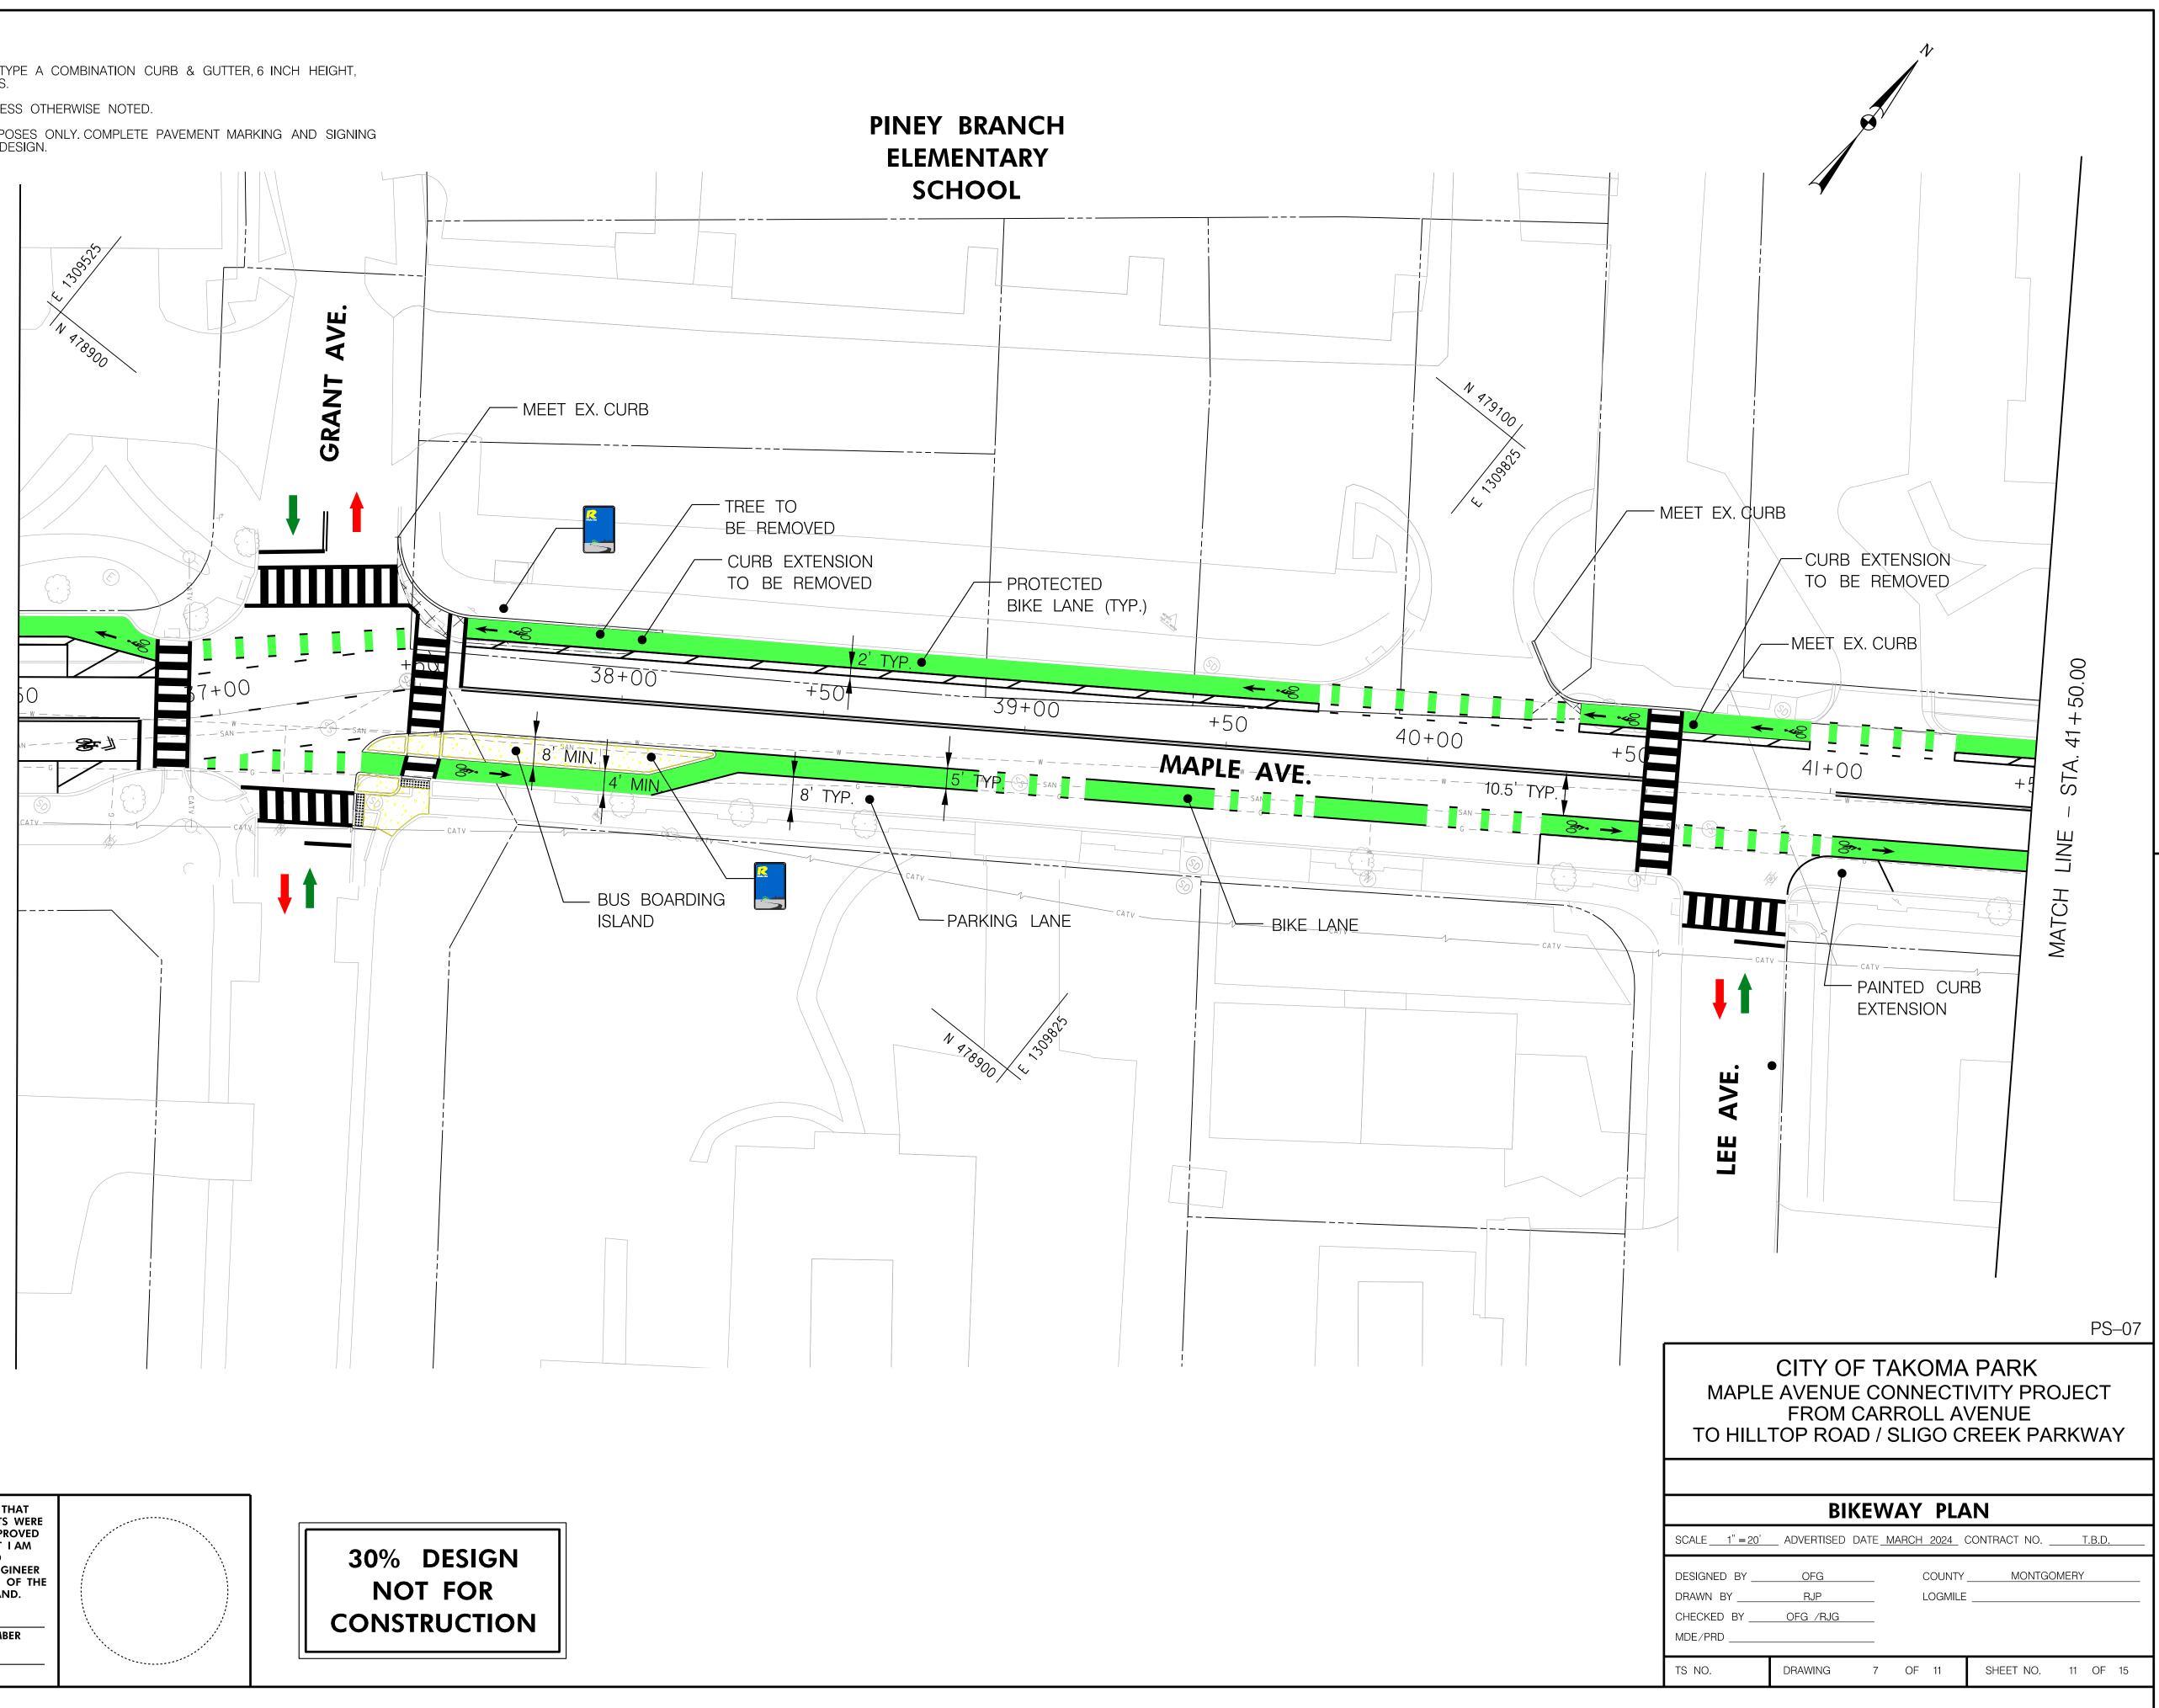
DETECTABLE WARNING SURFACE

BIKEWAY

EGRESS TO PROJECT AREA

INGRESS TO PROJECT AREA







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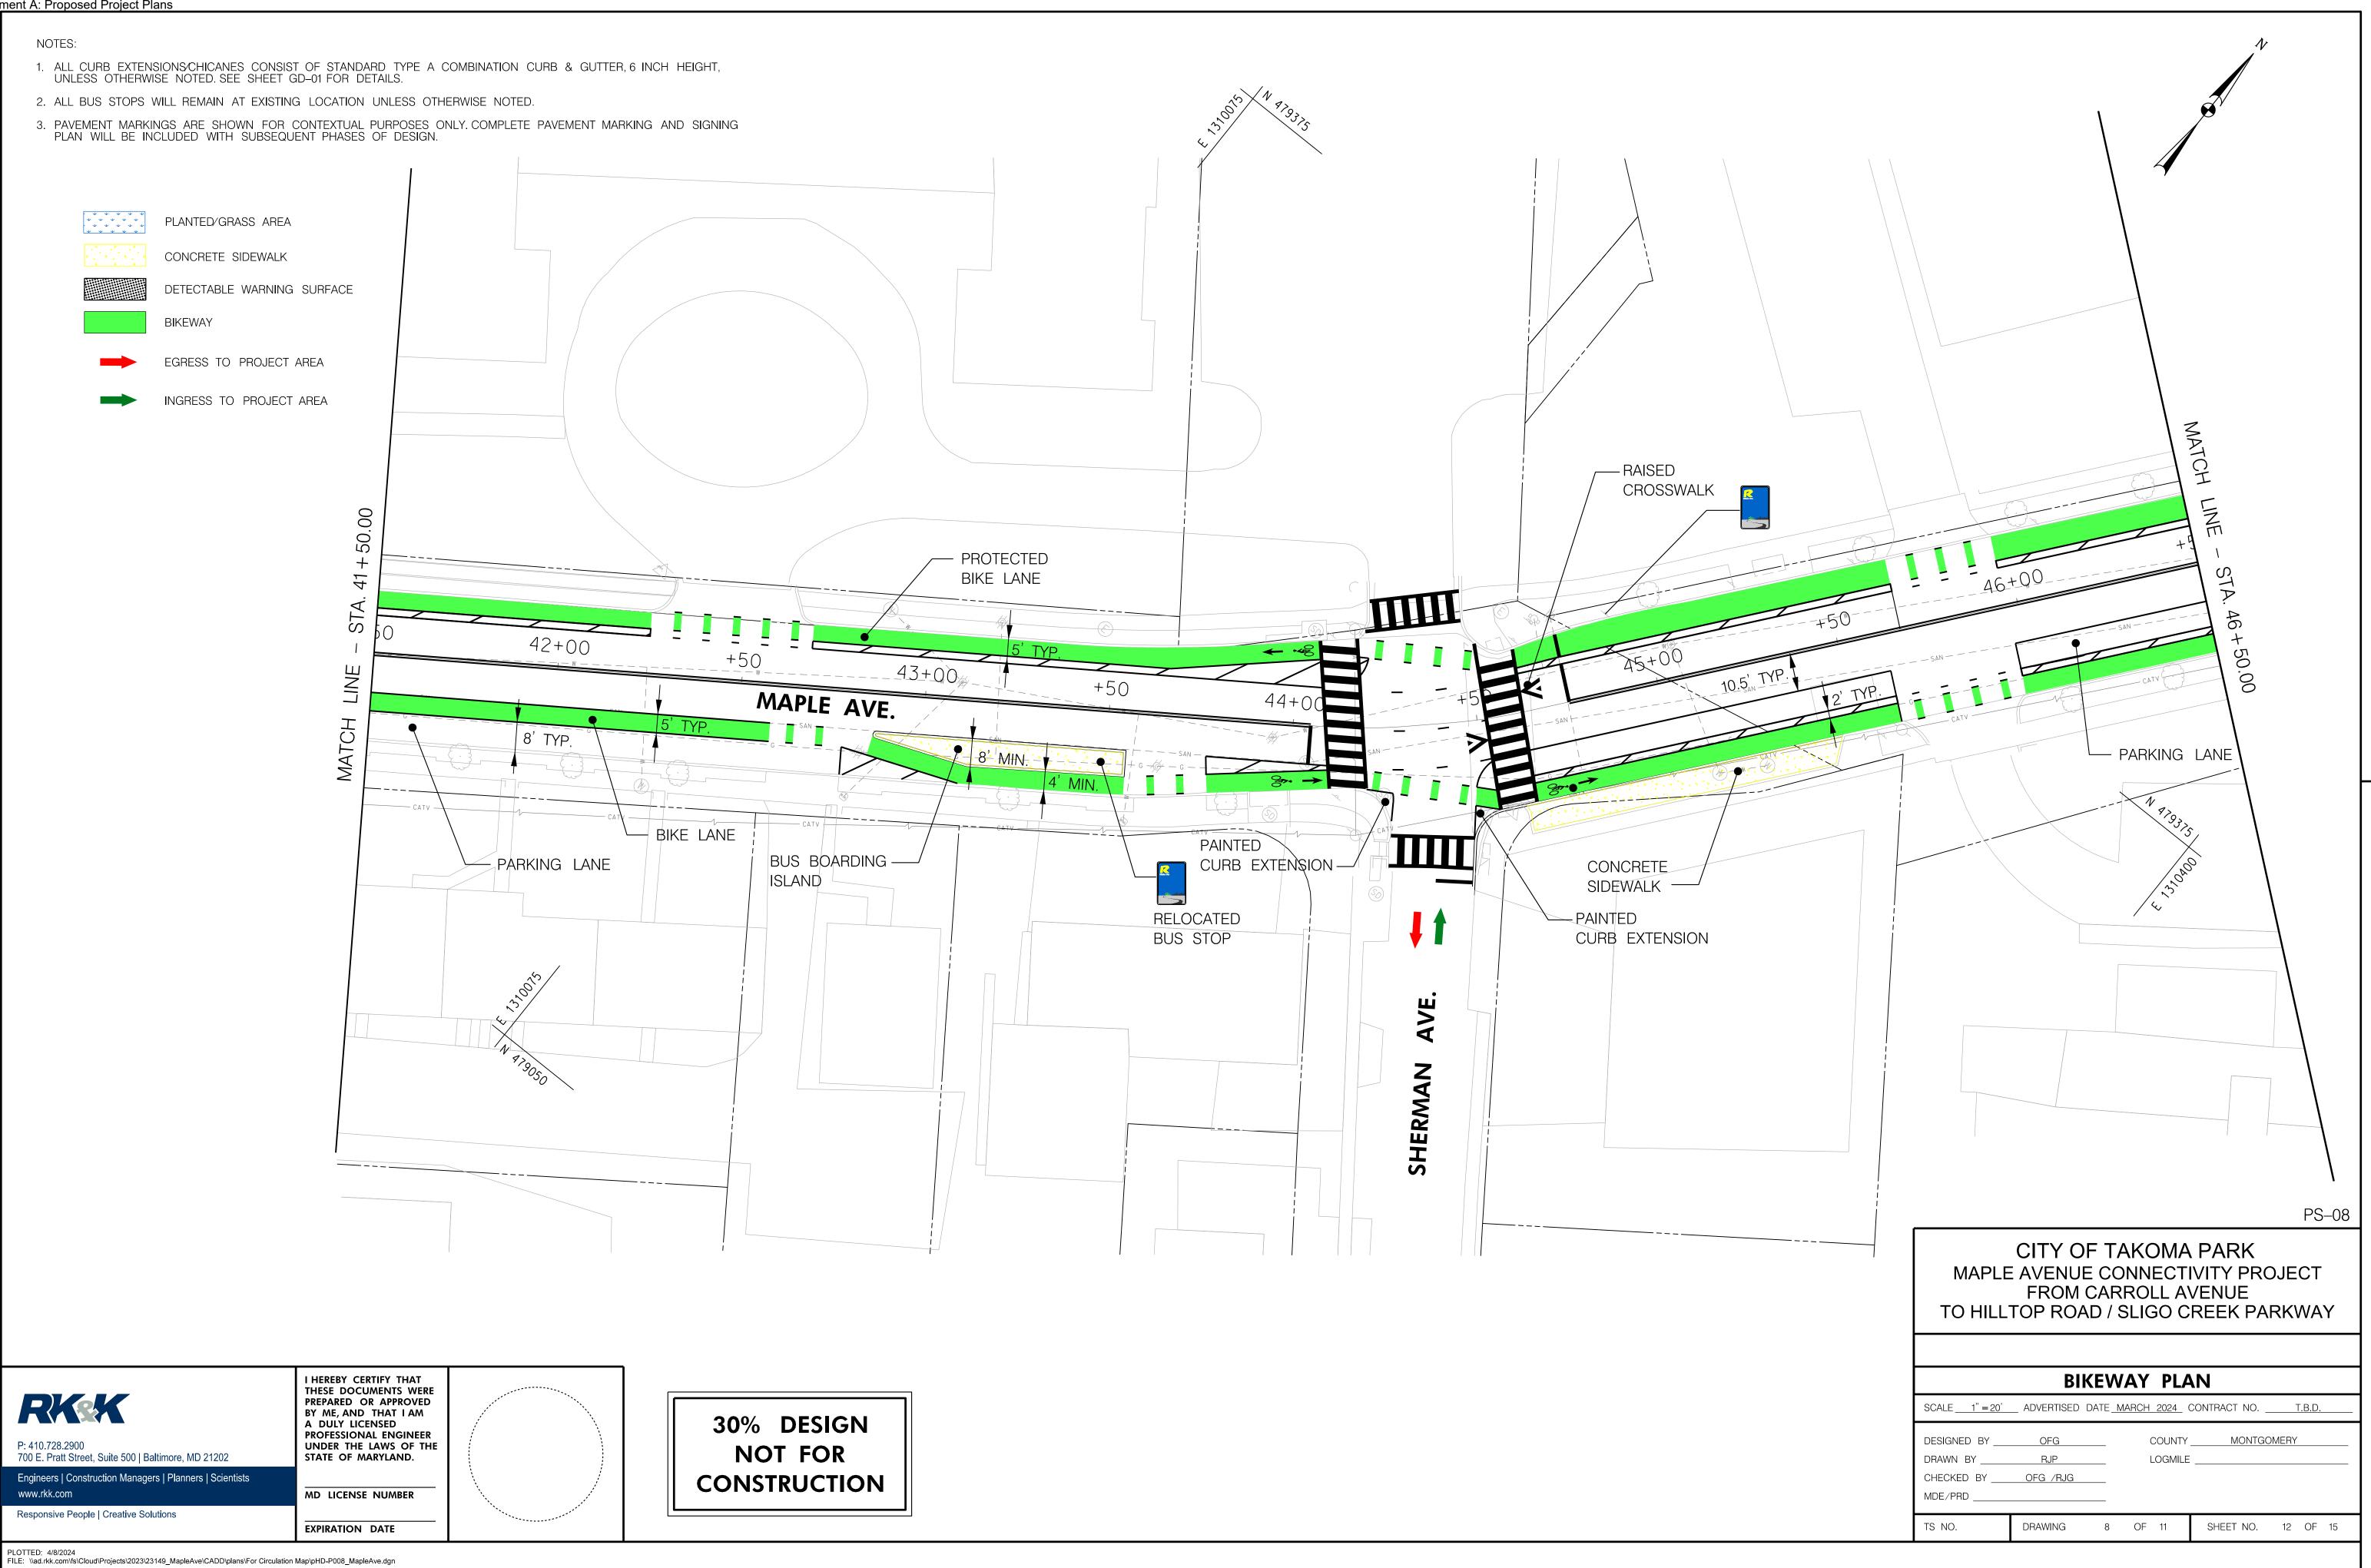
EXPIRATION DATE

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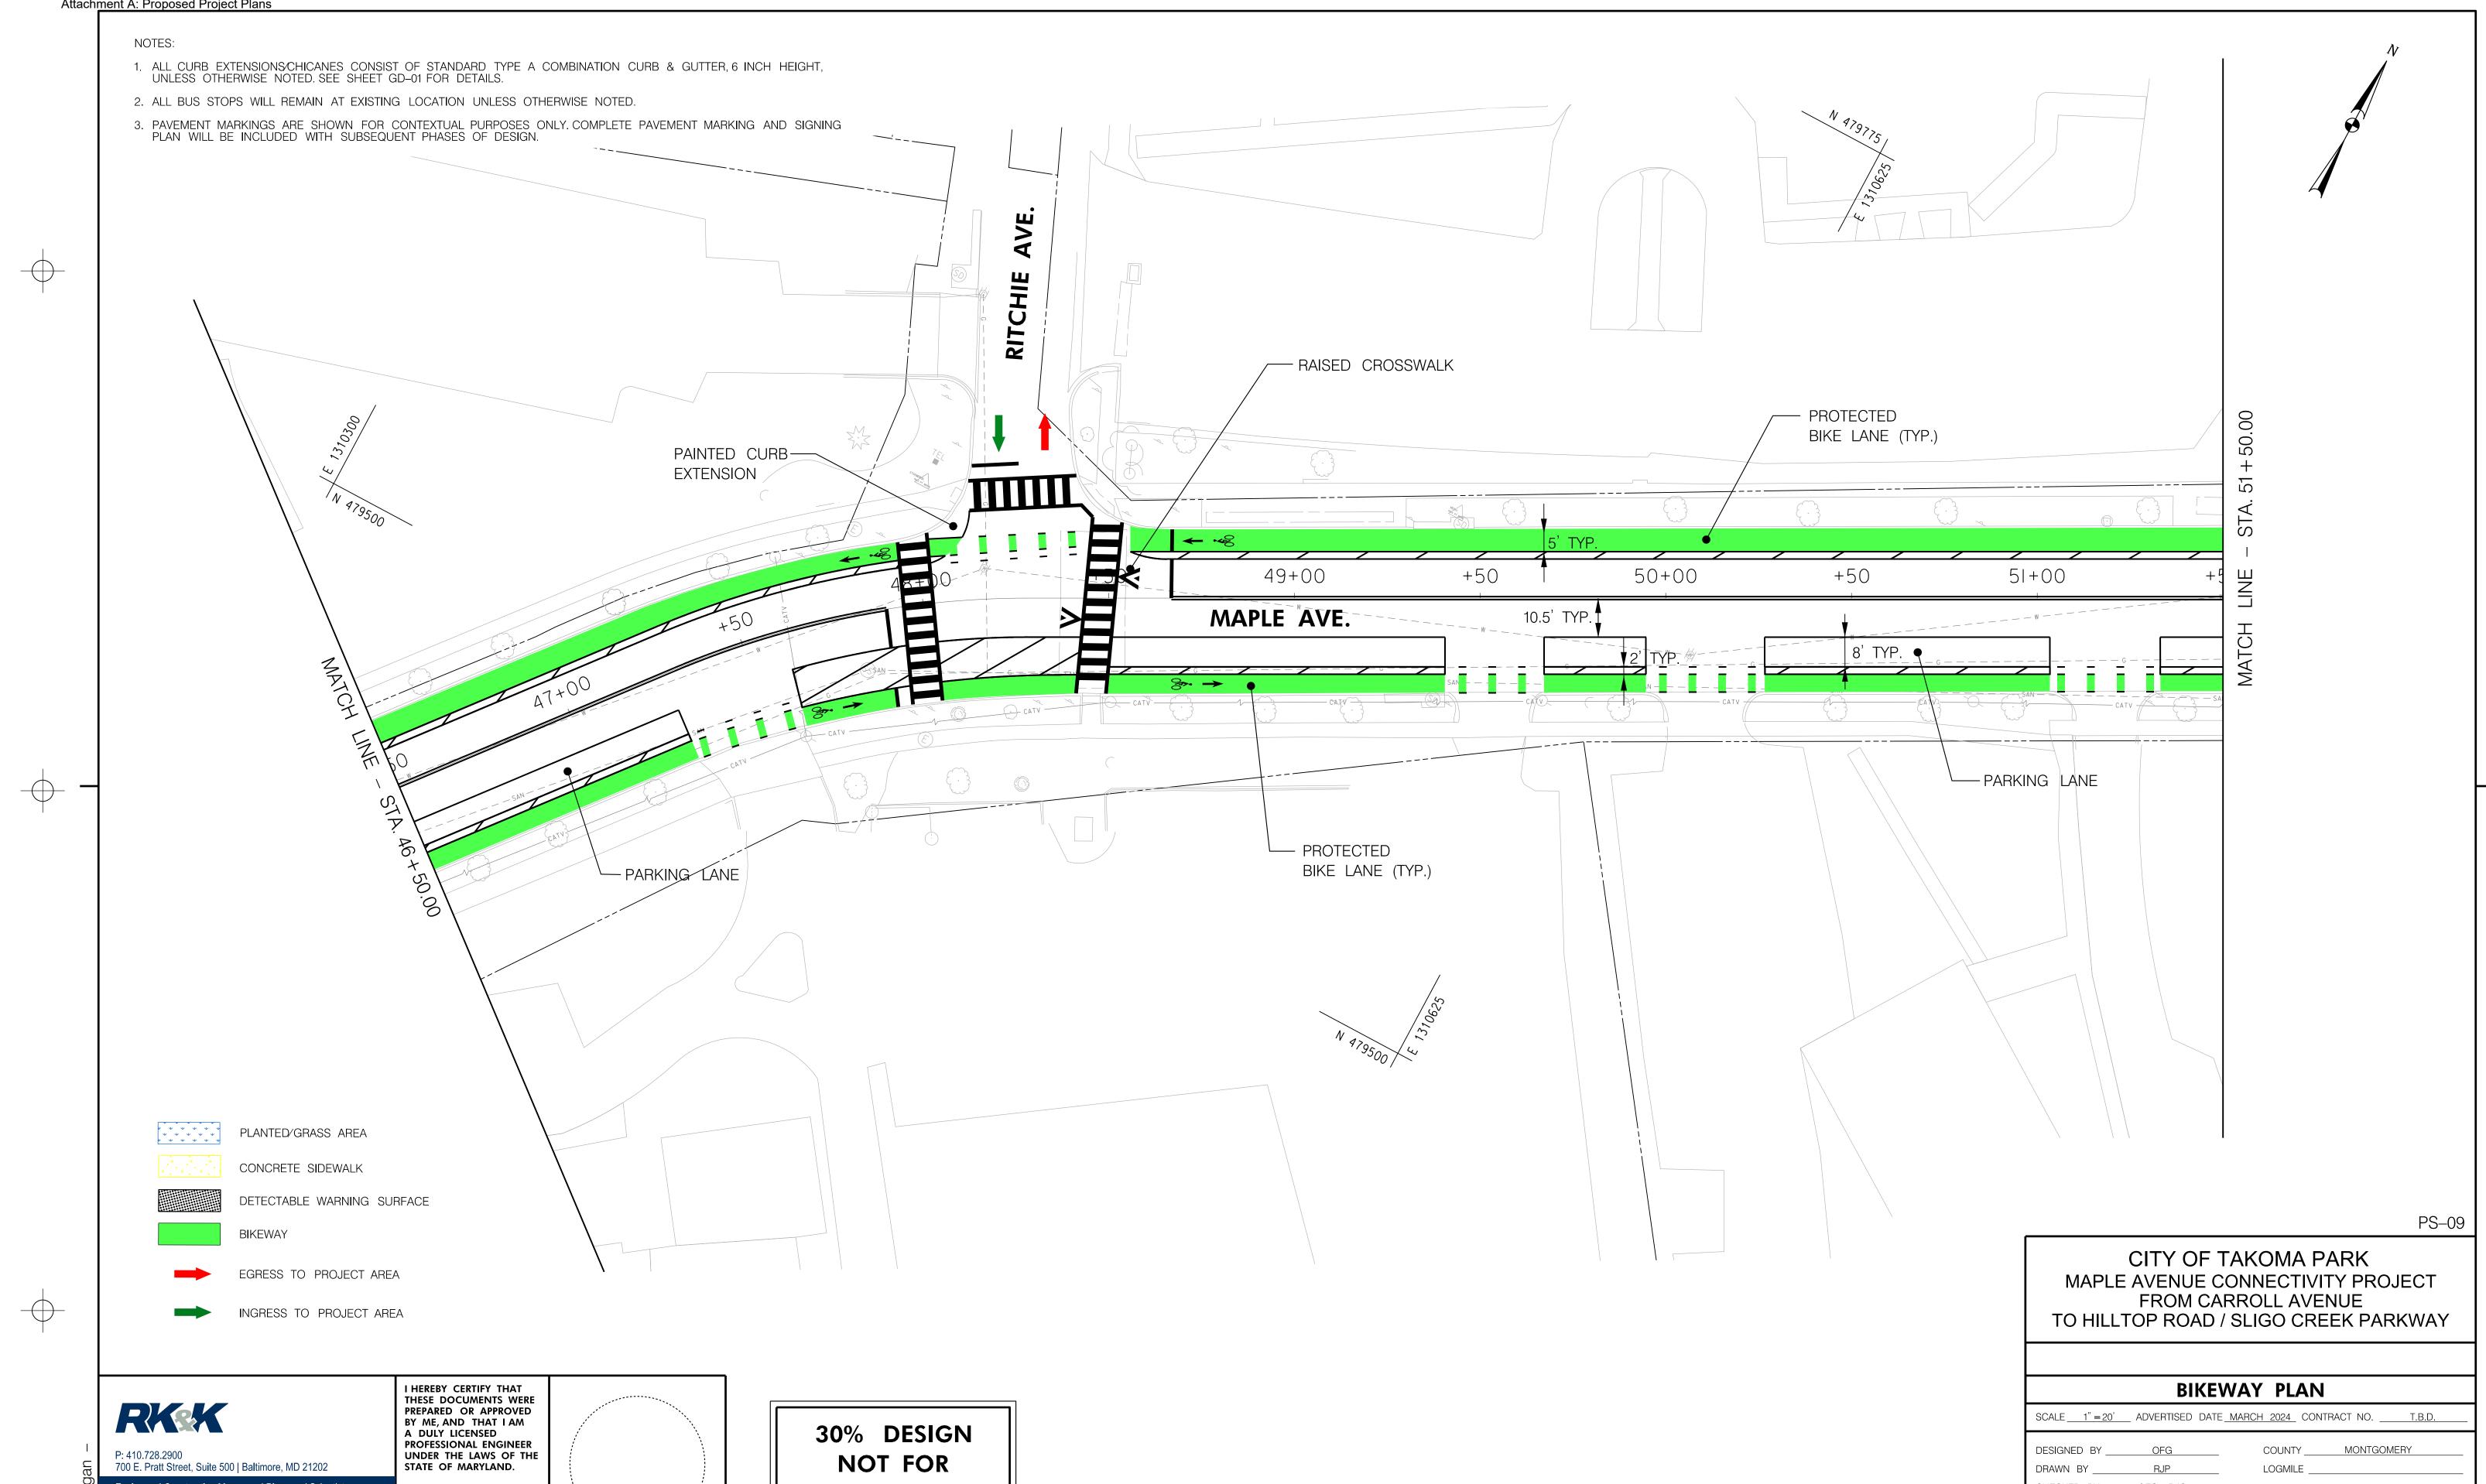
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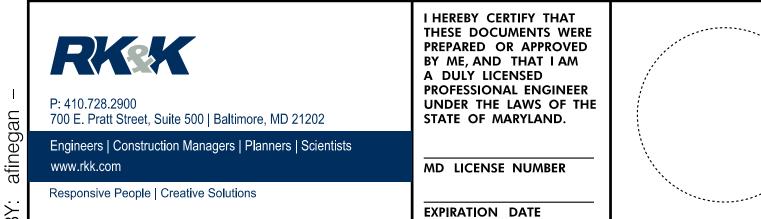




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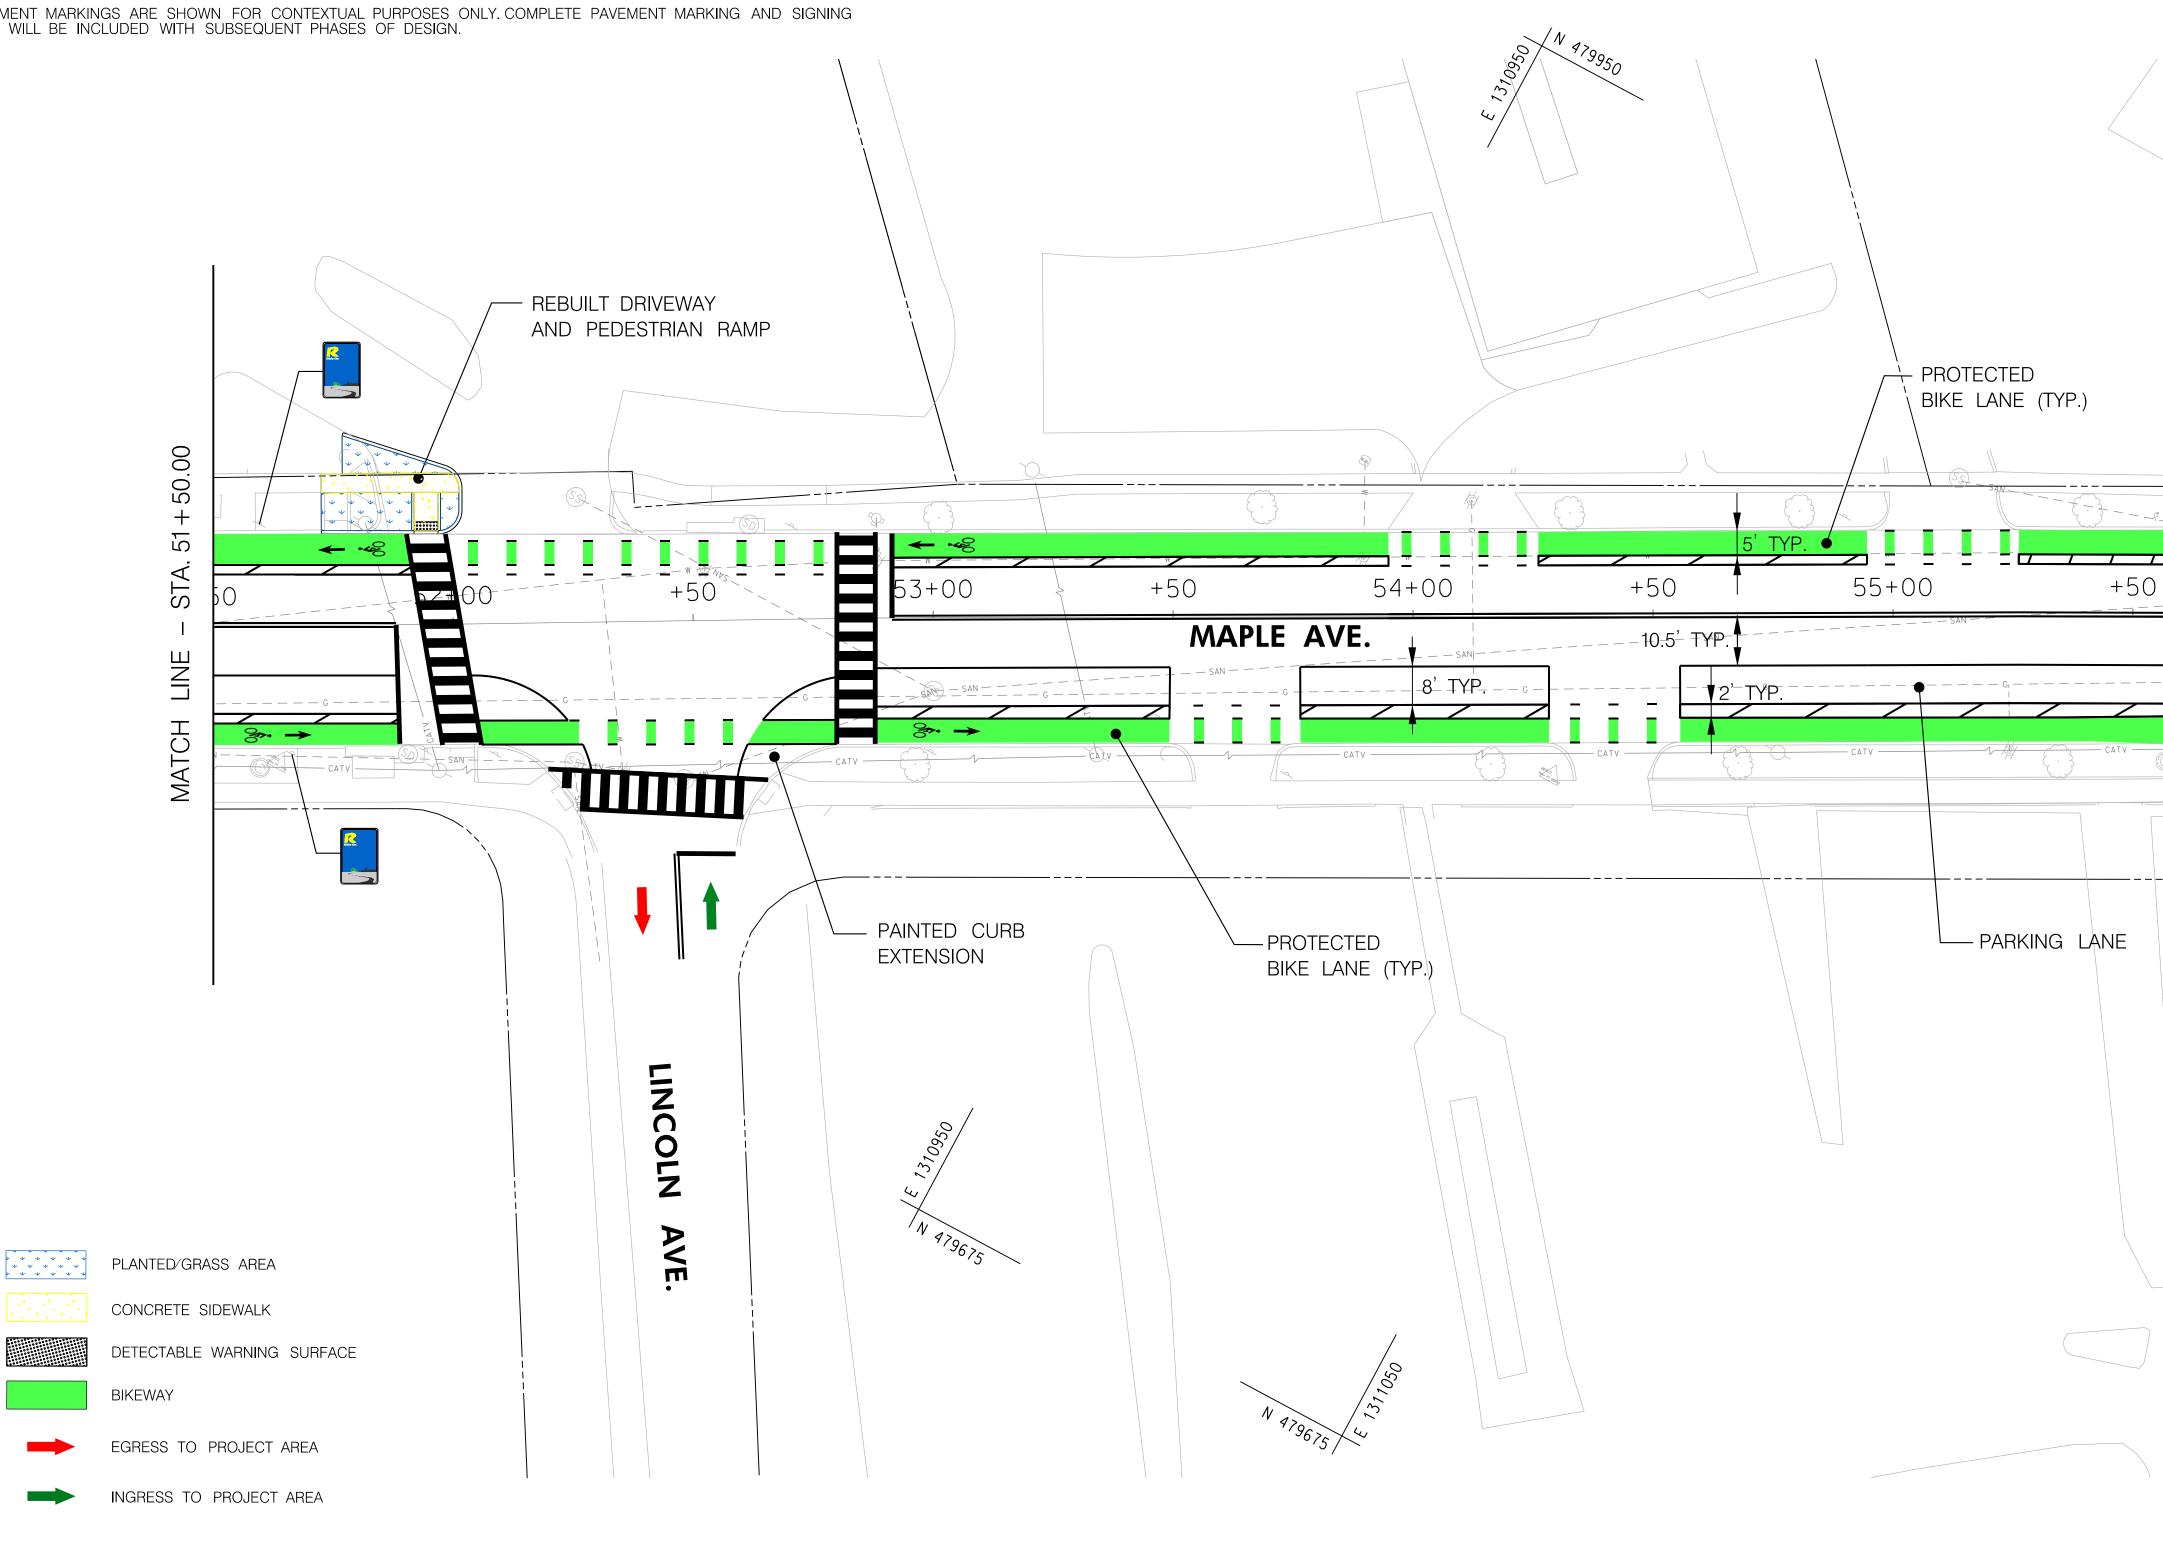
CONSTRUCTION

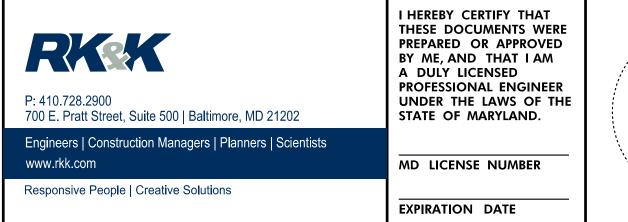


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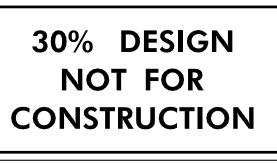




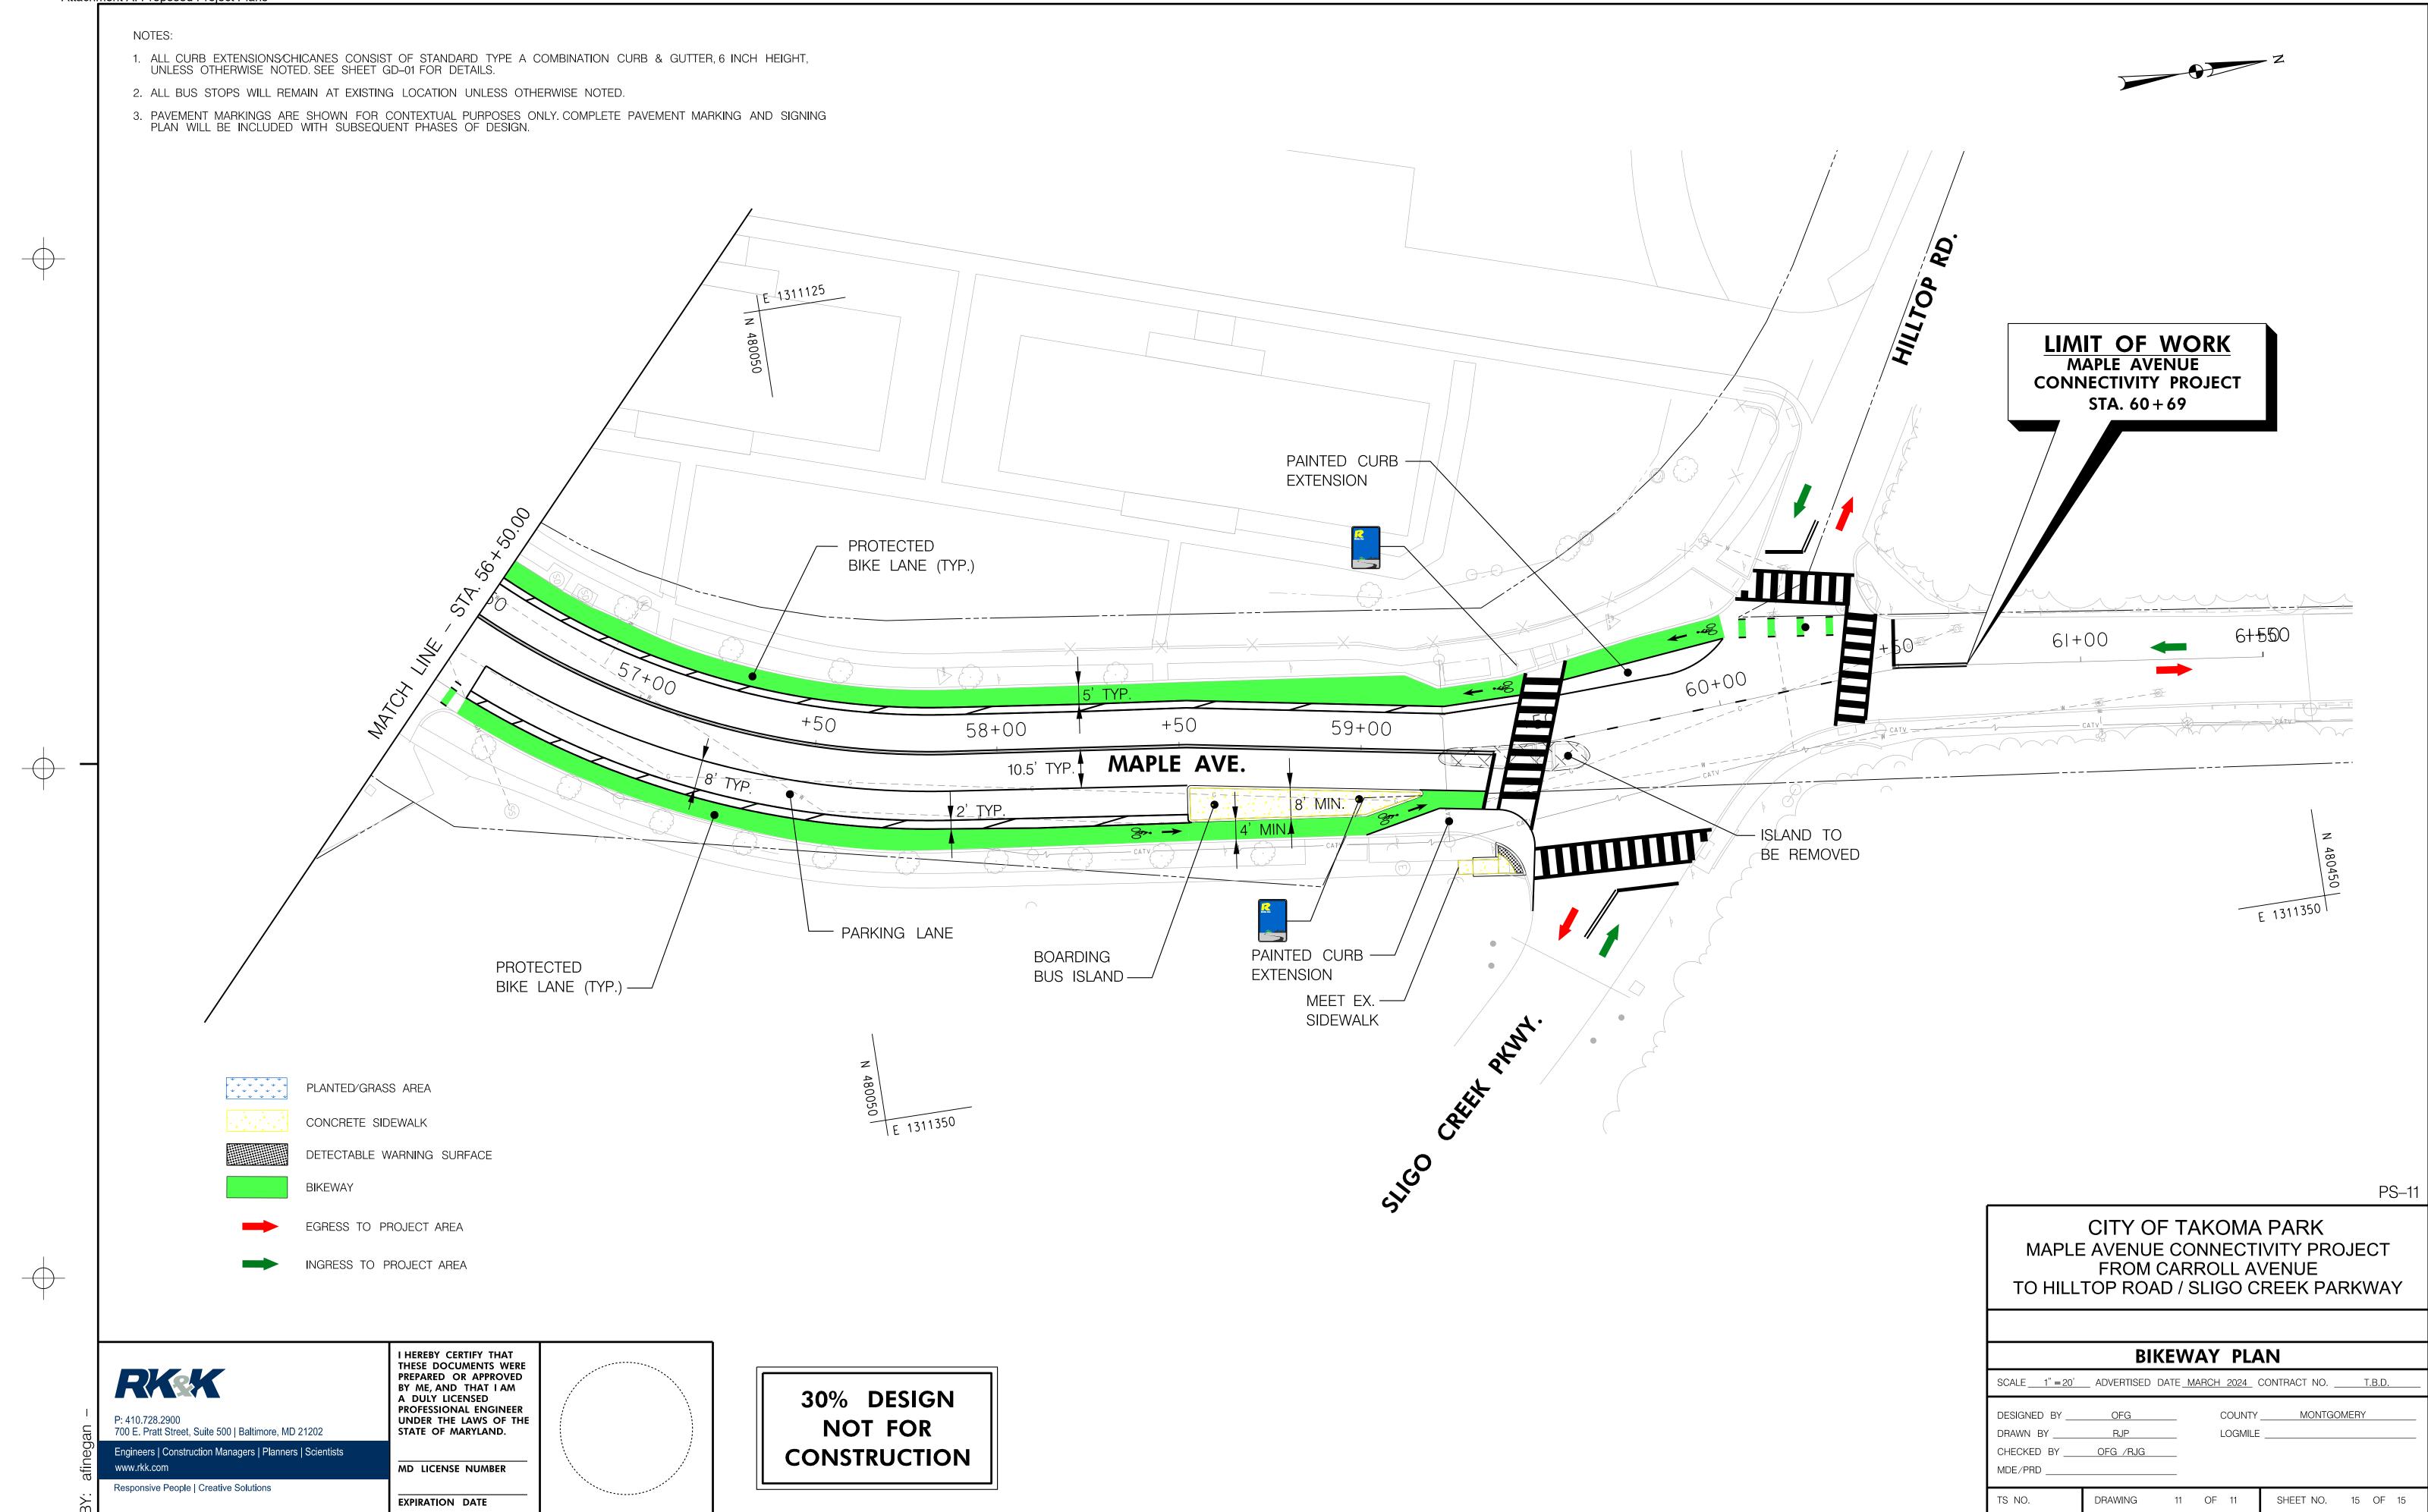


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MAT \mathcal{O} LINE 56+00 S ∇ 50 . O PS-10 CITY OF TAKOMA PARK MAPLE AVENUE CONNECTIVITY PROJECT FROM CARROLL AVENUE TO HILLTOP ROAD / SLIGO CREEK PARKWAY **BIKEWAY PLAN** SCALE <u>1" = 20'</u> ADVERTISED DATE <u>MARCH 2024</u> CONTRACT NO. <u>T.B.D.</u> DESIGNED BY OFG COUNTY ____ MONTGOMERY DRAWN BY _____RJP LOGMILE CHECKED BY OFG /RJG MDE/PRD _____ TS NO. DRAWING 10 OF 11 SHEET NO. 14 OF 15



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CITY OF TAKOMA PARK MAPLE AVENUE CONNECTIVITY PROJECT FROM CARROLL AVENUE TO HILLTOP ROAD / SLIGO CREEK PARKWAY						
BIKEWAY PLAN						
SCALE <u>1" = 20</u> ′	ADVERTISED	DATE_M	ARCH 2024 (CONTRACT NO	T.B.D.	
DESIGNED BY DRAWN BY CHECKED BY MDE/PRD	RJP OFG /RJG			MONTGC		
TS NO.	DRAWING	11	OF 11	SHEET NO.	15 OF 15	